



NONRESIDENTIAL SITE PLAN APPLICATION

City of Rochester, New Hampshire

	eded? Yes: No:_X_ Unclear:
(If so, we encourage you	to submit an application as soon as possible.)
Property information 205: 1, 2, & 6 Tax map #: 205 & 210 ; Lot #('s): 210: 32 & 33 ; Z	Industrial - Map 205: Lots 1, 2, & 6, Map 210: Lot oning district: Highway Commercial - Map 210: Lot 32
Property address/location: 7, 18, 16 Amarosa Drive & 0	, 124 Milton Road
Name of project (if applicable): Sig Sauer	
Size of site: 44.79 acres; overlay zoning district(
	ap 210, Lot 33: City of Rochester
- 101 200, LOT 2 & WE	ap 210, Lot 32: Sig Sauer Real Estate, Inc.
Name (include name of individual): Map 205, Lot 6: NH City of Rochester: 31 Wakefield Street, Roch	ester NH 03867
Mailing address: Sig Sauer Real Estate, Inc.: 72 Pease Blvd.,	Newington, NH 03801
NH Business Finance Authority: 135 North S	tate Street, Concord, NH 03301
Telephone #: Sig Sauer, attn: Rob Terrazzano - (603) 994-0023	Email: robert.terrazzano@sigsauer.com
Applicant/developer (if different from property ov	vner)
Name (include name of individual):	
Mailing address:	
Telephone #:	Email:
Engineer/designer	
Name (include name of individual):Allen & Major Asso	ciates, Inc. (Attn: Brian Jones, PE)
Mailing address: 400 Harvey Road, Manchester, NH 03103	
Telephone #:603-627-5500	Fax #:603-627-5501
Email address: _bjones@allenmajor.com	Professional license #: 13809
Proposed activity (check all that apply) New building(s): Site development (other Addition(s) onto existing building(s): Der	

Page 1 (of 3 pages)

The project proposes to add multiple building additions, update utility connections, enhance stormwater design & treatment, and tie into the municipal sewer system for the existing Sig Sauer Facility. The project will also introduce a round-a-bout in Milton Road (Route 125).

Describe p	proposed	activity/use:
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The existing 7 & 16 Amarosa Drive properties are used for the e Sig Sauer Facility. The existing 8 Amarosa Drive and 0 Milton R properties are vacant to date. The 124 Milton Road property is o occupied by two buildings along the roadway and contains unde
land in the centralized and rear portions of the parcel.
Utility information
City water? yes no; How far is City water from the site?50+/- feet
City sewer? yes <u></u> no; How far is City sewer from the site?25+/- feet
If City water, what are the estimated total daily needs? gallons per day
If City water, is it proposed for anything other than domestic purposes? yes (Fire) no
If City sewer, do you plan to discharge anything other than domestic waste? yes no
Where will stormwater be discharged? On-site storm water management facilities with outlet to wetland area
Building information
Type of building(s): Concrete block masonry with corrugated metal facade/finish.
Building height: 1-2 stories, <55 ft (Varies) Finished floor elevation: Varies, average is 247.9
Other information
parking spaces: existing: 587+/- total proposed: 812; Are there pertinent covenants? N/A Number of cubic yards of earth being removed from the site TBD
Number of existing employees: 300+/- ; number of proposed employees total: 475+/- Check any that are proposed: variance N/A; special exception; conditional use N/A
Wetlands: Is any fill proposed? N/A : area to be filled: N/A : buffer impact?

Proposed <u>post-development</u> disposition of site (should total 100%)							
	Square footage	% overall site					
Building footprint(s) – give for each building	271,800 +/- sf (existing building with additions)	13.8%					
Parking and vehicle circulation	434,700 +/- sf	22.1%					
Planted/landscaped areas (excluding drainage)	155,750 +/- sf	7.9%					
Natural/undisturbed areas (excluding wetlands)	319,600 +/- sf	16.2%					
Wetlands	786,900 +/- sf	40.0%					
Other – drainage structures, outside storage, etc.	1,050 +/- sf	0.005%					

Comments
Please feel free to add any comments, additional information, or requests for waivers here:
Submission of application
This application must be signed by the property owner, applicant/developer (if different from property owner), and/or the agent.
I(we) hereby submit this Site Plan application to the City of Rochester Planning Board
pursuant to the City of Rochester Site Plan Regulations and attest that to the best of my
knowledge all of the information on this application form and in the accompanying application
materials and documentation is true and accurate. As applicant/developer (if different from
property owner)/as agent, I attest that I am duly authorized to act in this capacity.
Jeff Chierepko VP US Facilities Signature of property owner: Mgt, Sig Sauer Digitally signed by Jeff Chierepko VP US Facilities Mgt, Sig Sauer Date: 2023,01.18 13,07.40 -05100'
Date:
Signature of applicant/developer:
Signature of agent: Date:
Authorization to enter subject property
I hereby authorize members of the Rochester Planning Board, Zoning Board of Adjustment,
Conservation Commission, Planning Department, and other pertinent City departments,
boards and agencies to enter my property for the purpose of evaluating this application
including performing any appropriate inspections during the application phase, review phas
post-approval phase, construction phase, and occupancy phase. This authorization applies
specifically to those particular individuals legitimately involved in evaluating, reviewing, or
inspecting this specific application/project. It is understood that these individuals must use a reasonable care, courtesy, and diligence when entering the property.
Signature of property owner:
Date:

Site Plan Checklist (residential and nonresidential)

*To be filled out by applicant/agent (with notes to be inserted by staff) See regulations for other specific requirements City of Rochester Planning & Development Department 205 1, 2, & 6

Project Name: Sig Sauer		_ Map:	210	Lot:	32 & 33	Date:_	01-20-23	_
Applicant/agent: Robert Terrazzano	Signature:							
(Staff review by:	Date:							
General items	Yes	No	N/A	Waiv Regu		Comm	ents	
4 sets completed application								_
Total application fee					<u> </u>			_
4 copies of narrative (drainage report)								_
3 sets of full-size plans	\checkmark							_
2 sets of 11 X 17 reductions	V				¥			_
Completed abutters list								
Copy of existing covenants, easements, deed restrictions								
 Plan Information Basic information including: Title sheet Name of Project Date North arrow Scale Legend Revision block Vicinity sketch -not less than 1" = 1,000 	✓						=	
Name and address of developer/applican	_							
Name, stamp, and NH license # of land survey, engineer, and/or architect								_
City tax map & lot #'s	V							_
Notation on plans: "For more information about this site plan contact"	V							_


General items Continued	V	Al-	NI/A	Waiver	.4a.d	Comments
Approval block (for signature by staff attesting to Planning Board approval)	Yes	No	N/A			Comments
References to neighboring plans and subdivisions			V			
Surveyed property lines including: existing and proposed bearings existing and proposed distances pins, stakes, bounds monuments 		₩				, and an
 benchmarks Include error of closure statement 						
Information on abutting properties: owner name owner address tax map and lot # square footage of lots approximate building footprints use	Ø					
Zoning Zoning designations of subject tract and in vicinity of tract	Ø			□ .		
Zoning requirements for district: • frontage • lot dimensions/density • all setbacks • lot coverage	Ø				E I	
Zoning overlay districts				□ .		
Existing Topographic Features: Contour lines a (not to exceed two-foot Intervals, except on steep slopes) and spot elevations		Ø		Π,		
Soil types and boundaries	Ø					
Soil test pit locations, profiles, and		V				
Depth to water table and ledge Percolation test locations and results		abla				

Existing Topographic Features Co				Waive	
Water features (ponds, streams)	Yes	No	N/A	Reque	ested Comments
Wetlands including name of certified Wetlands scientist who delineated	Ø				
Statement whether located in flood area, And if so, 100 year flood elevation	V				
Delineation of trees and open areas	V				
Overview of types of trees and vegetation	abla				
Stone walls and archaeological features	\checkmark				
Locations of trails and paths					
Other natural/cultural resources (productive farmland, habitats, scenic views, historic structures, etc)			Ø		
Building Information Existing buildings/structures including square footage and use	Ø				
Proposed building/structures including square footagefirst floor elevationuse# bedrooms per unit if residential	 ✓				
Elevation drawing of proposed buildings and structures as follows: Showing all four sides Drawn to scale with dimensions Showing exterior materials Showing exterior colors		✓			
Circulation and Parking Plans Existing and proposed driveways and access points including: Width of opening Turning radii Cross section of driveway	Ø				3
Curbing & edge treatment	abla				:
Traffic control devices, if appropriate:					

Circulation and Parking Plans Co.				Waive	
Number of parking spaces required by ordinanceproposed	Yes	No	N/A □	Requ	ested Comments
Parking layout and dimensions of spaces	V				
Handicap spaces	\checkmark				
Loading area	V				
Pedestrian circulation plan (including existing sidewalks in vicinity, if any)	Ø				
Bicycle rack, if appropriate			abla		<u></u>
Buffers, landscaping & screening	\checkmark				
Snow storage areas/plan	\checkmark				
<u>Utilities</u> Show all pertinent existing and proposed p	orofiles	, eleva	itions, r	material —	s, sizes, and details
Water lines/well (with protective radius)	abla				
Sewer lines/septic and leaching areas	V				
Pump stations	\checkmark				
Stormwater management system: pipes, culverts,, catch basins detention/ retention basins, swales, rip rap, etc.	V				
Fire hydrant location(s) and details	V				
Electric, telephone, cable TV (underground or overhead)	V				
Gas lines	V				
Fire alarm connections	V				
Treatment of solid waste (dumpsters?)	abla				
Handing of oil, grease, chemicals	V				

<u>Landscaping Plan</u>				Waive	
Demarcation of limits of construction, clear delineation of vegetation to be saved, and strategy for protecting vegetation	Yes	No	N/A	Reque	ested Comments
Proposed ground cover, shrubbery, and trees including: • botanical and common names • locations and spacing • total number of each species • size at installation					
Planting plan (size of holes, depth of planting, soil amendments, etc.)	Ø				
Irrigation: system? soaker hose? Manual? undergro	und, et	tc.			s
Protection of landscaping from vehicles (Curb stops, berm, railroad ties, etc)	V				
Specification all finished ground surfaces and edges (greenspace, mulch, asphalt, concrete, etc.)	Ø				2
Fencing/screening	V				
Signage Location and type of signs: Attached to building Freestanding Directional, if appropriate	Ø				5
Dimensions of signs: HeightAreaSetback					
Elevation drawings with colors & materials		V			
Type of Illumination, if proposed					

			Waiver	
Yes	No	N/A	Requested	d Comments
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				Yes No N/A Requested

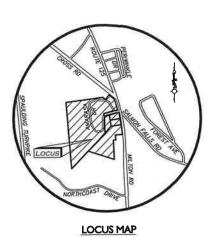


APPLICANT: SIG SAUER REAL ESTATE, INC. 72 PEASE BLVD. NEWINGTON, NH 03801 (603) 610-3000

ARCHITECT:
PORT ONE ARCHITECTS
959 ISLINGTON STREET
PORTSMOUTH, NH 03801
(603) 436-8891

CIVIL ENGINEER / LANDSCAPE ARCHITECT ALLEN & MAJOR ASSOCIATES, INC. 400 HARVEY ROAD MANCHESTER, NH 03103 (603) 627-5500

SITE DEVELOPMENT PLANS FOR SIG SAUER

TAX MAP 205, LOTS 1, 2, & 6 TAX MAP 210, LOTS 32 & 33 ROCHESTER, NH 03868

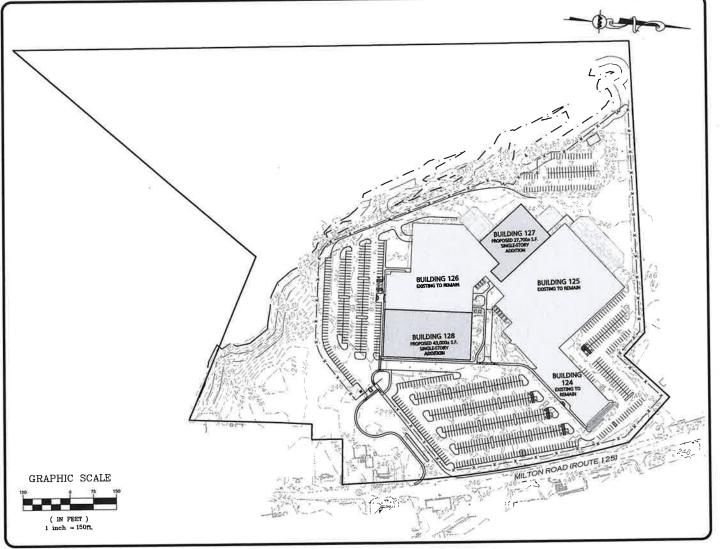

DRAWING TITLE	SHEET NO.	ISSUED	REV 1	REV 2
OVERALL COMPILED EXISTING CONDITIONS	V-101	01-20-23	*	
COMPILED EXISTING CONDITIONS	V-101A	01-20-23	- 5	•
COMPILED EXISTING CONDITIONS	V-101B	01-20-23	-	*
COMPILED EXISTING CONDITIONS	V-101C	01-20-23	+	
COMPILED EXISTING CONDITIONS	V-101D	01-20-23	2	- 5
SITE SPECIFIC SOIL MAPPING	C-100	25	-	-
OVERALL EROSION CONTROL PLAN	C-101	01-20-23	-	-
EROSION CONTROL PLAN	C-101A	01-20-23	u u	-
EROSION CONTROL PLAN	C-101B	01-20-23		
EROSION CONTROL PLAN	C-101C	01-20-23	-	140
FROSION CONTROL PLAN	C-101D	01-20-23	-	
OVERALL LAYOUT & MATERIALS PLAN	C-102	01-20-23		8.50
LAYOUT & MATERIALS PLAN	C-102A	01-20-23	•	-
LAYOUT & MATERIALS PLAN	C-102B	01-20-23		
LAYOUT & MATERIALS PLAN	C-102C	01-20-23		
LAYOUT & MATERIALS PLAN	C-102D	01-20-23	- 20	243
OVERALL GRADING & DRAINAGE PLAN	C-103	01-20-23	-	1 35
GRADING & DRAINAGE PLAN	C-103A	01-20-23		- 2
GRADING & DRAINAGE PLAN	C-103B	01-20-23	-	0.0
GRADING & DRAINAGE PLAN	C-103C	01-20-23	7.00	1.0
GRADING & DRAINAGE PLAN	C-103D	01-20-23	120	16
OVERALL UTILITIES PLAN	C-104	01-20-23	-	(-
UTILITIES PLAN	C-104A	01-20-23	1.0	
UTILITIES PLAN	C-104B	01-20-23		
UTILITIES PLAN	C-104C	01-20-23		-
UTILITIES PLAN	C-104D	01-20-23		
OVERALL SITE LIGHTING PLAN	C-105	01-20-23	(a)	-
SITE LIGHTING PLAN	C-105A	01-20-23		-
SITE LIGHTING PLAN	C-105B	01-20-23	72	-
SITE LIGHTING PLAN	C-105C	01-20-23	-	-
	C-105D	01-20-23		1
SITE LIGHTING PLAN	C-105D	01-20-23		-
TRUCK TURNING PLAN	C-106B	01-20-23		T -
TRUCK TURNING PLAN	C-201	01-20-23		2
SEWER PLAN & PROFILE	C-501	01-20-23		T -
DETAILS	C-502	01-20-23	-	
DETAILS	C-502	01-20-23		-
DETAILS	C-504	01-20-23	-	٠.
DETAILS	C-505	01-20-23	—	
DETAILS	C-505	01-20-23		-
DETAILS	C507	01-20-23		1
DETAILS	L-101	V1-2U-23		-
OVERALL LANDSCAPE PLAN				1
LANDSCAPE PLAN	L-101A	<u> </u>	+	150
LANDSCAPE PLAN	L-101B		+	
LANDSCAPE PLAN	L-101C		<u> </u>	-
LANDSCAPE PLAN	L-101D	*	+ -	
LANDSCAPE NOTES	L-102		-	-

LIST OF DRAWINGS

APPROVED - CITY PLANNING STAFF		
DATE:	DATE OF APPROVAL:	



ALLEN & MAJOR ASSOCIATES, INC.

FOR MORE INFORMATION ABOUT THIS PLAN SET, CONTACT: BRIAN D. JONES AT ALLEN & MAJOR ASSC., INC. 603-627-5500



TEL: (603) 627-5501

FAX: (603) 627-5501


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ISSUED FOR SITE PLAN REVIEW: JANUARY 20, 2023





REV DATE DESCRIPTION

SIG SAUER 7-8 AMAROSA DRIVE ROCHESTER, NH 03868

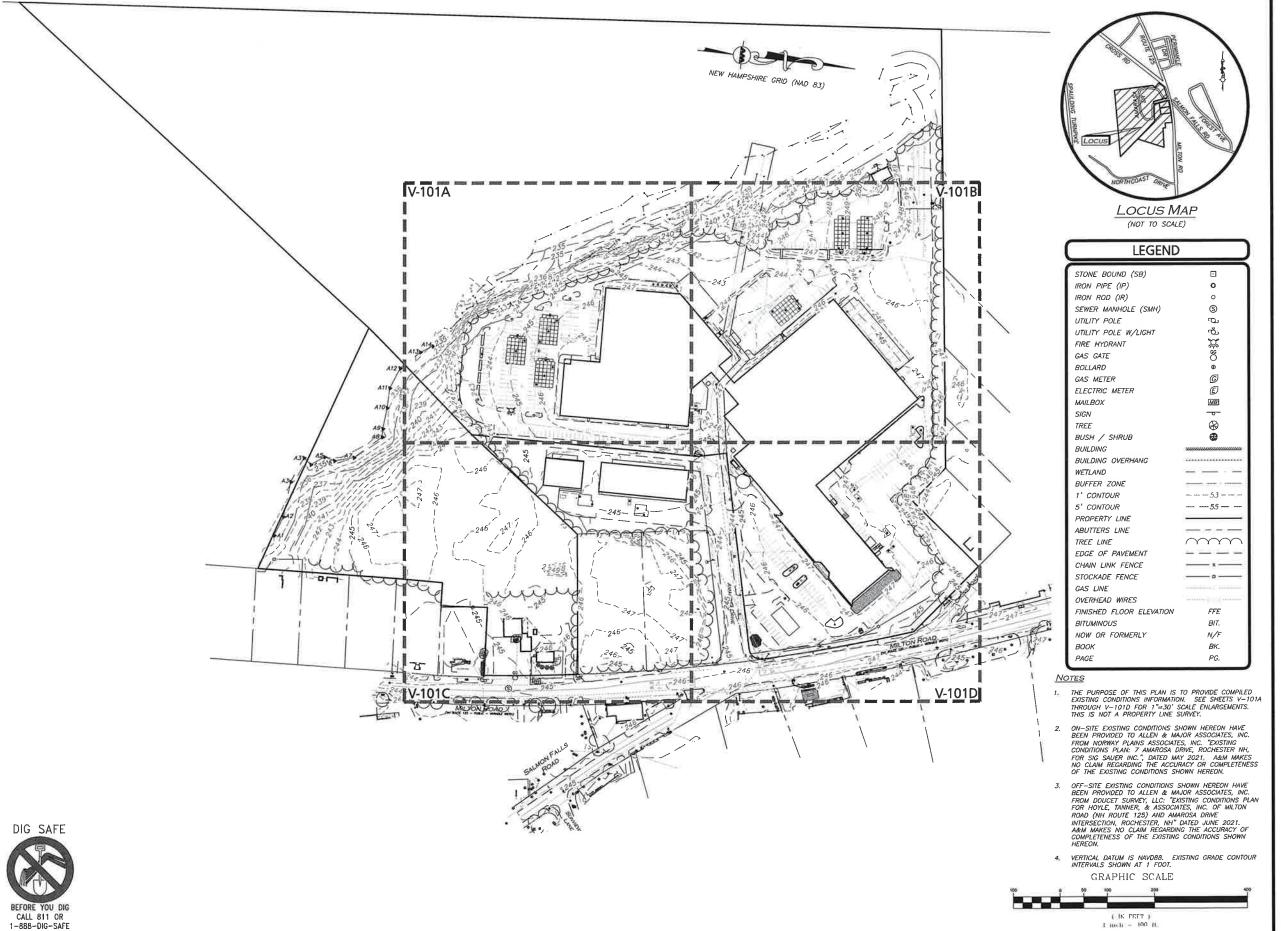7,8,16 AMAROSA DRIVE 0,124 MILTON ROAD ROCHESTER, NH 03868

PROJECT NO.	2912-01A	DATE:	01-20-23
SCALE:	1" = 100"	DWG. NAME:	C2912-01A
DESIGNED BY:	AJR	CHECKED BY:	BDJ



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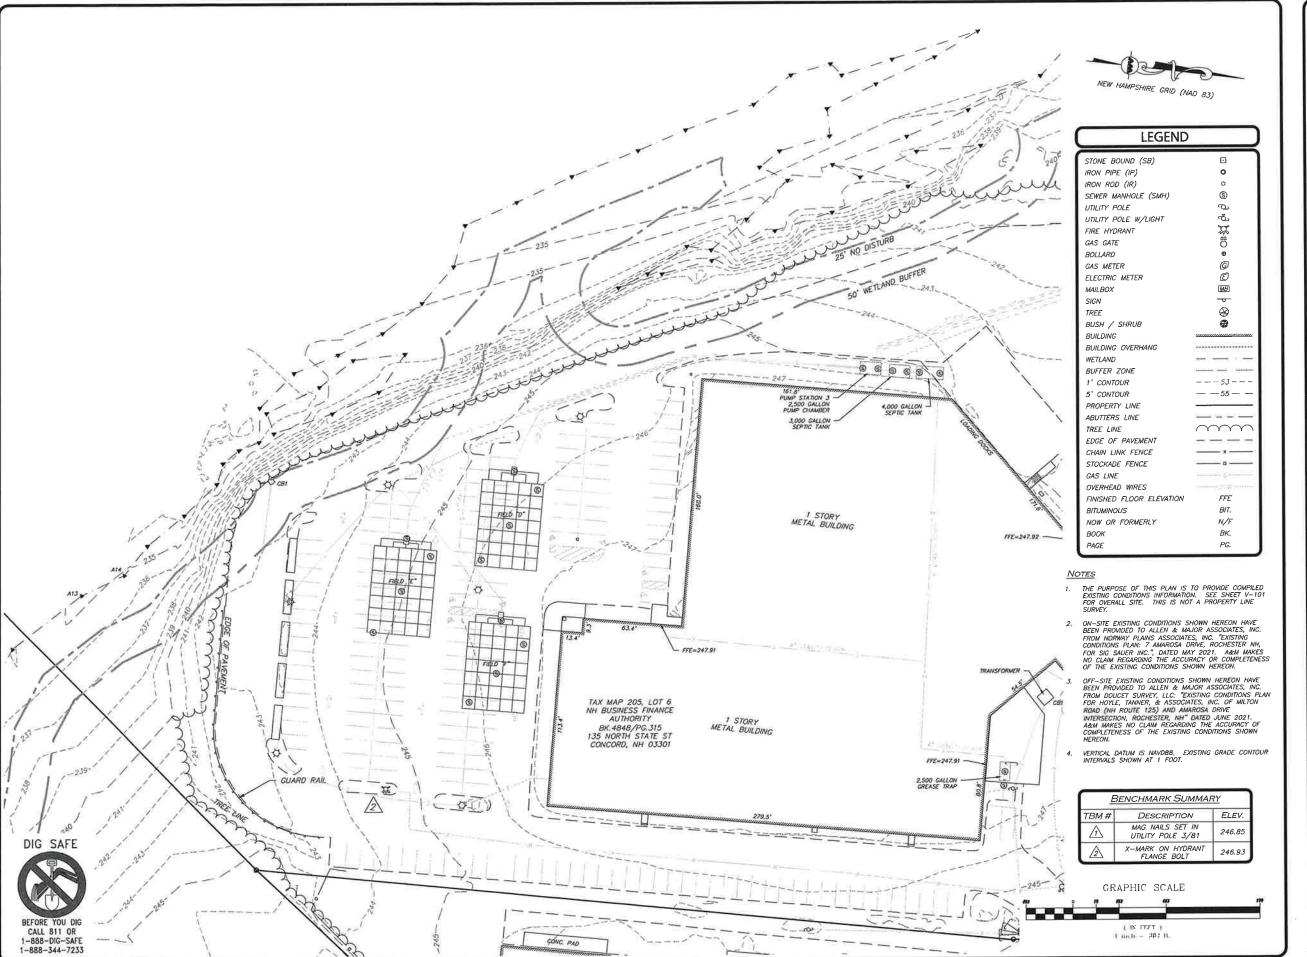
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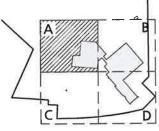
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V-101

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PROFESSIONAL ENGINEER FOR ALLEN & MAJOR ASSOCIATES, INC.

			_
REV	DATE	DESCRIPTION	

SIG SAUER 7-8 AMAROSA DRIVE ROCHESTER, NH 03868

7,8,16 AMAROSA DRIVE 0,124 MILTON ROAD ROCHESTER, NH 03868

	PROJECT NO.	2912-01A	DATE:	01-20-23
- 1	SCALE:	1" = 30'	DWG. NAME:	C2912-01A
	DESIGNED BY:	AJR	CHECKED BY:	BDI
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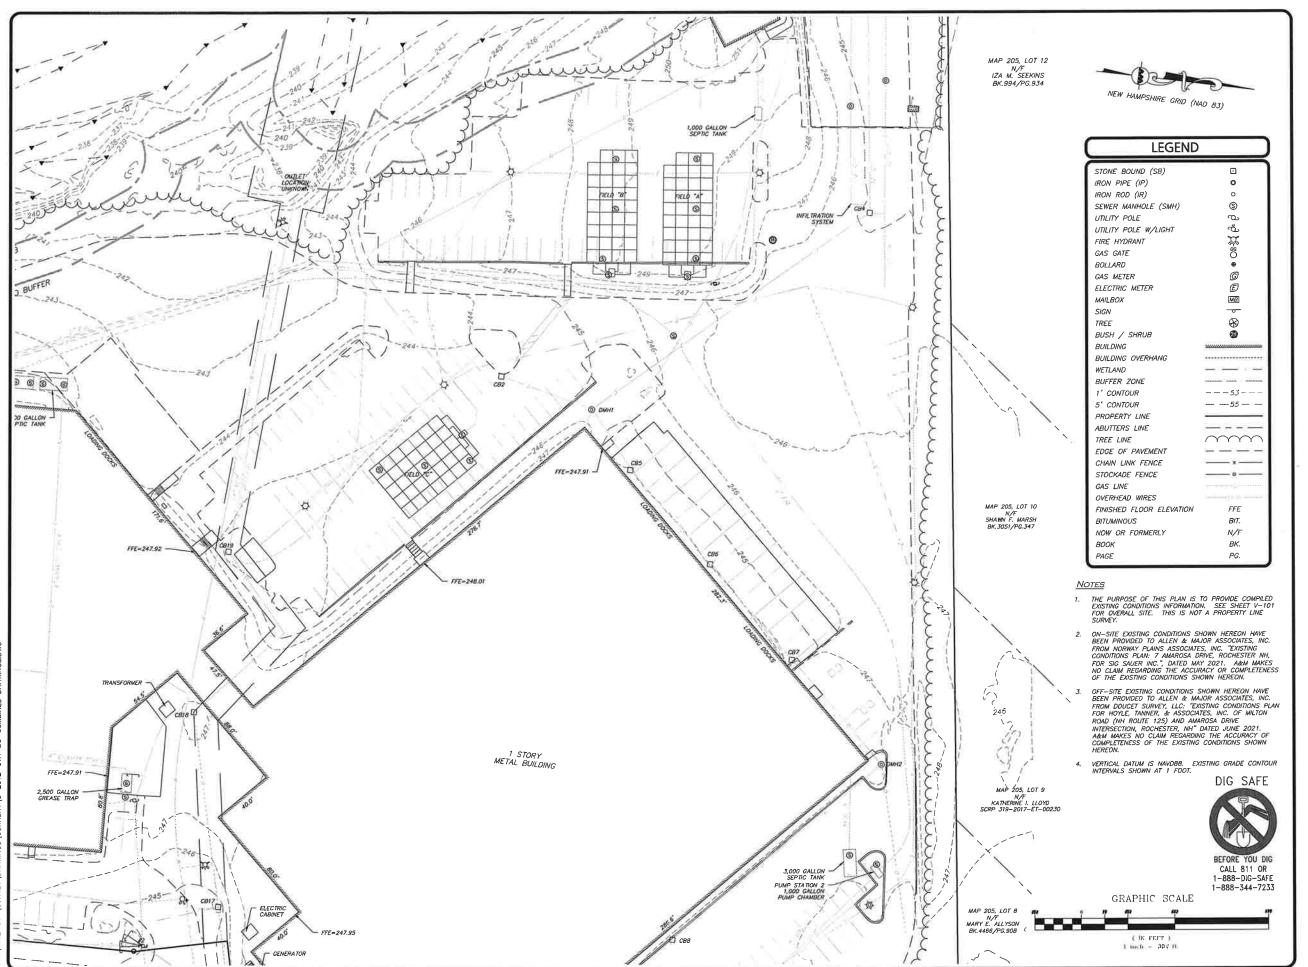
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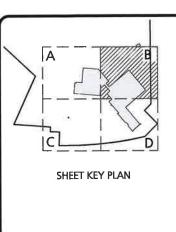
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REV	DATE	DESCRIPTION

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7,8,16 AMAROSA DRIVE 0,124 MILTON ROAD ROCHESTER, NH 03868

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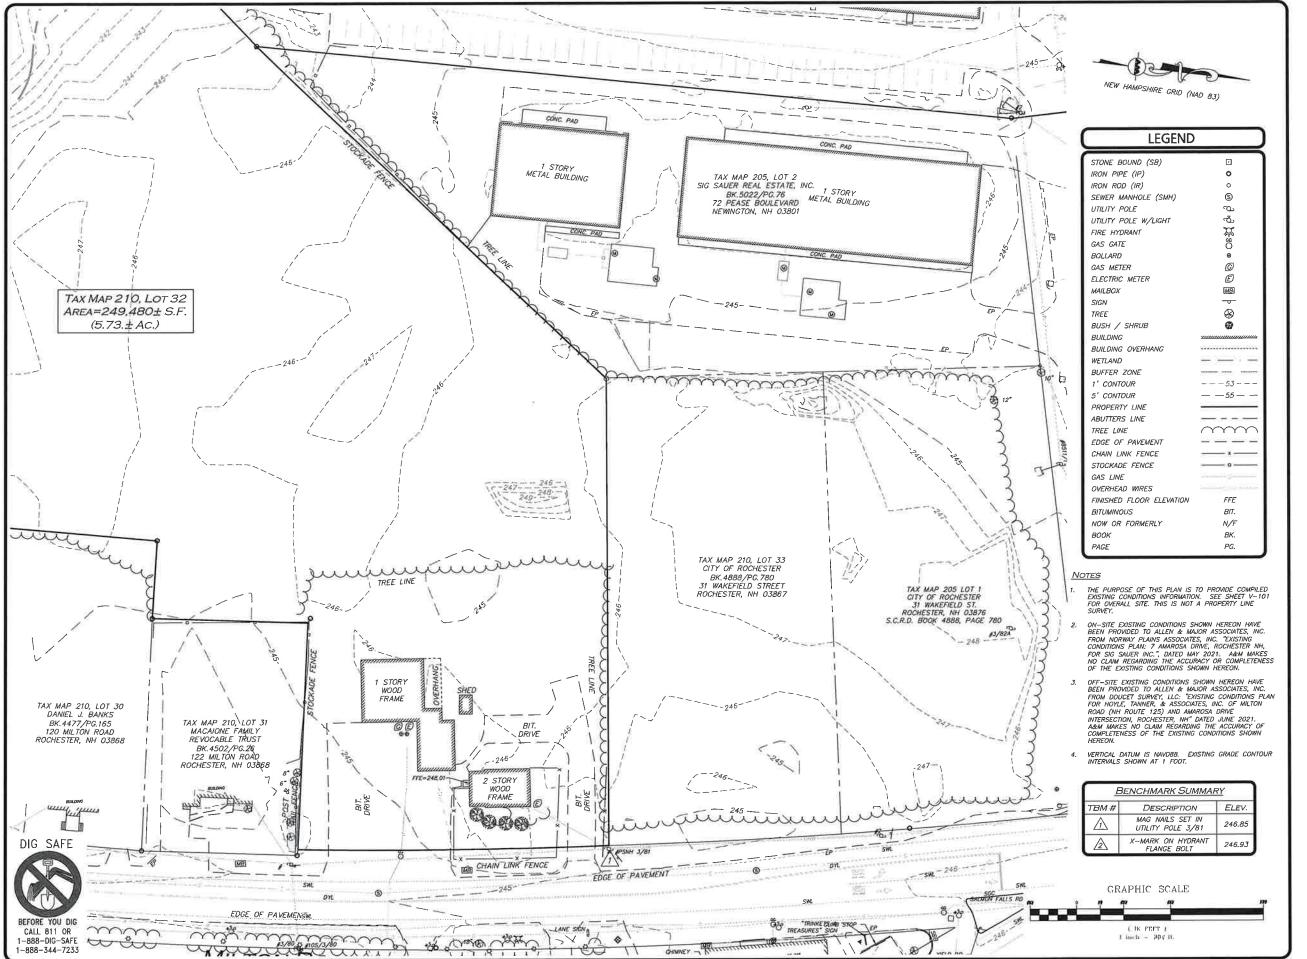
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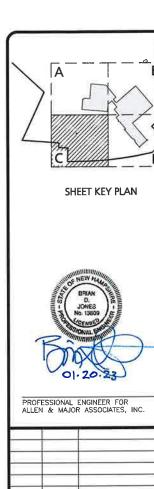
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REV DATE DESCRIPTION

ROCHESTER, NH 03868

SIG SAUER 7-8 AMAROSA DRIVE

PROJECT NO. 2912-01A DATE: 01-20-23 1" = 30' DWG, NAME: CZ912-01/ SCALE: AIR CHECKED BY: ESIGNED BY:



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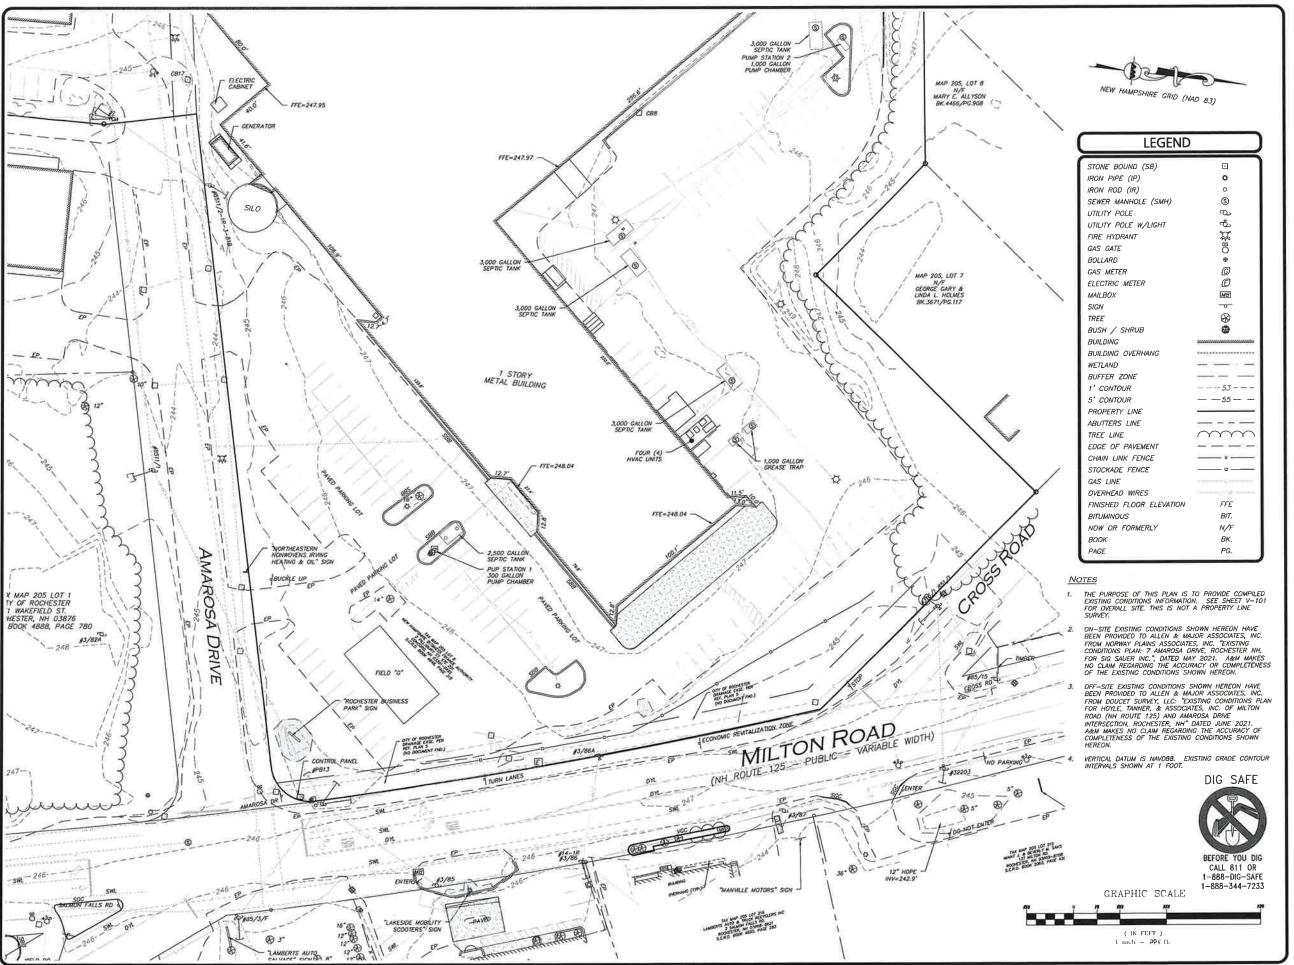
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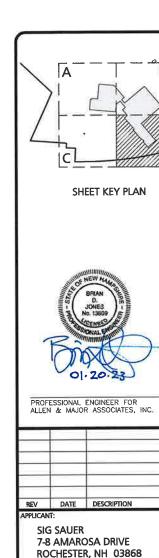
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DESIGNED BY:	AJR	CHECKED BY:	BDJ



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V-101D

- GENERAL SEQUENCE OF CONSTRUCTION:

 1. CONTACT THE CITY ENGINEERING DEPARTMENT AT LEAST TWO (2) WEEKS PRIOR TO START OF CONSTRUCTION.
- INSTALL STABILIZED CONSTRUCTION ENTRANCES, SITE ACCESS SHALL BE ACHIEVED ONLY FROM THE DESIGNATED CONSTRUCTION ENTRANCE.
- 3. PREPARE TEMPORARY PARKING AND STORAGE AREA. UPON IMPLEMENTATION AND INSTALLATION OF THE FOLLOWING AREAS: TRAILER, PARKING, LAY DOWN, WHEEL WASH, CONCRETE WASHOUT, MASON AREA, FULL AND MATERIAL STORAGE CONTAINERS, SOLID WASTE CONTAINERS, ETC., DEMOTE THEM ON THE SITE MAPS IMMEDIATELY AND NOTE ANY CHANGES IN THE LOCATIONS AS THEY OCCUR THROUGHOUT THE CONSTRUCTION PROCESS,
- INSTALL THE TUBULAR BARRIERS AND SILT SACKS AS SHOWN HEREON, SEE ALSO SHEETS C-101A THROUGH C-101D.
- 5. CLEAR AND GRUB THE SITE.
- CONSTRUCT TEMPORARY SEDIMENTATION AND SEDIMENT TRAP BASINS AS NECESSARY.

7. BEGIN GRADING THE SITE.

C-101A

C-101C

- 8. CONSTRUCT STORMWATER MEASURES. SITE SHALL BE STABILIZED PRIOR TO STORMWATER MEASURES RECEIVING RUNOFF.
- 9. START CONSTRUCTION OF BUILDING PAD AND STRUCTURES, TEMPORARILY SEED DENUDED AREAS. ALL CUT AND FILL SLOPES SHALL BE SEEDED / LOAMED WITHIN 72 HOURS OF ACHIEVING FINISH GRADE, EXCEPT WHERE RIP RAP IS APPLIED.
- 10. INSTALL BUILDING, UTILITIES, STORM SEWERS, CURBS AND GUTTERS.
- 11, INSTALL INLET PROTECTION DEVICES AROUND ALL STORM DRAIN STRUCTURES.
- 12. INSTALL RIP RAP AROUND OUTLET STRUCTURES. 13. FINALIZE GRADING, AND PREPARE SITE FOR PAYING, NOTE, ALL PARKING LOTS SHALL BE STABILIZED WITHIN 72 HOURS OF ACHIEVING FINISH GRADE.
- 14. PAVE SITE. COMPLETE FINISH GRADING AND INSTALL PERMANENT SEEDING AND PLANTING.
- 15, ONCE SITE IS STABILIZED, REMOVE ALL TEMPORARY EROSION AND SEDIMENT CONTROL DEVICES.
- 16, ALL EROSION CONTROL MEASURES SHALL BE INSPECTED WEEKLY AND AFTER ALL RAINFALL EVENTS GREATER THAN 0.25°, AND SHALL BE MAINTAINED, REPAIRED OR REPLACED AS REQUIRED OR AT THE DIRECTION OF THE OWNER'S ENGINEER, OR THE TOWN ENGINEER.
- 17. SEDIMENT ACCUMULATION UP-GRADIENT OF THE TUBULAR BARRIERS GREATER THAN 6" IN DEPTH SHALL BE REMOVED AND DISPOSED OF IN ACCORDANCE WITH ALL APPLICABLE REGULATIONS.
- 18, IF IT APPEARS THAT SEDIMENT IS EXITING THE SITE, SILT SACKS SHALL BE INSTALLED IN ALL CATCH BASINS ADJACENT TO THE SITE. SEDIMENT ACCUMULATION ON ALL ADJACENT CATCH BASIN INLETS SHALL BE REMOVED AND THE SILT SACK REPLACED IF TORN OR DAMAGED.

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19. THE CONTRACTOR SHALL COMPLY WITH THE GENERAL AND EROSION NOTES AS SHOWN ON THE SITE DEVELOPMENT PLANS.

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C-101B

C-101D



LEGEND

TUBULAR BARRIER CATCH BASIN FILTER STABILIZED ENTRANCE STOCKPILE/STAGING AREA LIMIT OF DISTURBANCE LIMIT OF 'CLEAR AND GRUB' BUILDING TO BE REMOVED PAVEMENT TO BE REMOVED

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GENERAL NOTES:

- THE PURPOSE OF THIS PLAN IS TO PROVIDE OVERALL EROSION CONTROL INFORMATION FOR THE PROPOSED BUILDING ADDITIONS AND ASSOCIATED SITE IMPROVEMENTS. SEE SHEETS C-101A THROUGH C-101D FOR 1*=30' SCALE ENLARGEMENTS.
- 2. EXISTING CONDITIONS SHOWN HEREON HAVE BEEN PROVIDED TO ALLEN & MAJOR ASSOCIATES, INC. FROM NORWAY PLAINS ASSOCIATES, INC. DESTROY PLAINS (ASSOCIATES, INC. DESTROY PLAINS PLAIN FOR SIG SAUER INC., DATED MAY 2021. A&M MAKES NO CLAIM RECARDING THE ACCURACY OR COMPLETENESS OF THE EXISTING CONDITIONS SHOWN HEREON.
- 3. ALL WORK MUST CONFORM TO THE CITY OF ROCHESTER, DEPARTMENT OF PUBLIC WORKS STANDARD SPECIFICATIONS AND ANY WORK WITHIN THE CITY RIGHT-OF-WAY REQUIRES AN EXCAVATION PERMIT.
- EXCAVATION PERMIT.

 4. THE CONTRACTOR IS SPECIFICALLY CAUTIONED THAT THE LOCATION AND/OR ELEVATION OF EXISTING UTILITIES AND STRUCTURES AS SHOWN ON THESE PLANS IS BASED ON RECORDS OF VARIOUS UTILITY COMPANIES AND WHERE POSSIBLE, MEASUREMENTS TAKEN IN THE FIELD. THIS INFORMATION IS NOT TO BE RELIED ON AS BEING EXACT OR COMPLETE. THE LOCATION OF ALL UNIDERGROUND UTILITIES AND STRUCTURES SHALL BE VERIFIED IN THE FIELD BY THE CONTRACTOR MUST TO THE START OF CONSTRUCTION. THE CONTRACTOR MUST CONTRACT THE APPROPRIATE UTILITY COMPANY, ANY GOVERNING PERMITTING AUTHORITY, AND "DIGSAFE" AT LEAST 72 HOURS PRIOR TO ANY EXCAVATION WORK TO REQUEST EXACT FIELD LOCATION OF ANY UTILITIES INITERFERING WITH THE PROPOSED CONSTRUCTION AND APPROPRIATE REMIDUAL ACTION TAKEN BEFORE PROCECEDING WITH THE WORK. IT SHALL BE THE RESPONSIBILITY OF THE CONTRACTOR TO RELOCATE ALL EXISTING UTILITIES INTERFERING WITH THE PROPOSED IMPROVEMENTS SHOWN ON THE FLANS.
- 5. ALL ELEVATIONS REFER TO NAVD '88.
- 6. NO MATERIAL CONTAINING ANY LIVING OR VIABLE PORTION OF PLANTS ON THE NEW HAMPSHIRE PROHIBITED INVASIVE SPECIES LIST (AGRASBOO TABLE 3500.1) SHALL BE TRANSPORTED TO OR FROM CONSTRUCTION SITE WITHOUT NOTHERATION AND APPROVAL FROM THE NEW HAMPSHIRE DEPARTMENT OF AGRICULTURE PER RSA 430:55.
- A WATERING TRUCK SHALL BE USED TO PERIODICALLY SPRINKLE CONSTRUCTION AREAS IN ORDER TO KEEP THE LEVEL OF DUST TO A MINIMUM DURING THE DRY MONTHS AND AS REQUIRED IN ACCORDANCE WITH ENV-A1000.
- 8. THE INFORMATION SHOWN ON THIS PLAN IS THE SOLE PROPERTY OF ALLEN & MAJOR ASSOCIATES, INC. ITS INTENDED USE IS TO PROVIDE INFORMATION, ANY ALTERATION, MISUSE, OR RECALCULATION OF INFORMATION OR DATA WITHOUT THE EXPRESSED, WRITTEN CONSENT OF ALLEN & MAJOR ASSOCIATES, INC. IS STRICTLY PROHIBITED.
- IF, DURING CONSTRUCTION, IT BECOMES APPARENT THAT ADDITIONAL EROSION CONTROL MEASURES ARE REQUIRED TO STOP ANY EROSION ON THE CONSTRUCTION SITE, IT HE PROPERTY OWNER SHALL BE REQUIRED TO INSTALL THE NECESSARY EROSION PROTECTION AT NO EXPENSE TO THE CITY.
- 10. ALL EROSION CONTROLS SHALL BE INSPECTED WEEKLY AND WITHIN 24 HOURS OF THE END OF A STORM WITH RAINFALL AMOUNT GREATER THAN 0.25 INCHES, THE INSPECTIONS SHALL VERIEY THAT THE STRUCTURAL BIMPS SHOWN AND DESCRIBED ON THE PLANS ARE IN GOOD CONDITION AND ARE MINIMIZING EROSION. A MAINTENANCE AND INSPECTION REPORT SHALL BE SHALL BE KEPT ON STITE FOR THE DURATION OF THE PROJECT AND SEE MADE AVAILABLE FOR THE FOR THE DURATION OF THE PROJECT AND SEE MADE AVAILABLE FOR REVIEW BY THE CITY UPON REQUEST.
- 11. THE CONTRACTOR SHALL VERIFY EROSION CONTROL MEASURES, WHICH ARE PLACED IN OR NEAR CITY RIGHTS-OF-WAY, ARE WHICH ARE PLACED IN OR NEAR CITY RIGHTS—UP-WAIT, ARE
 PROPERLY MAINTAINED JUST PRIOR TO AND/OR DURING LARGE
 STORM EVENTS IN ORDER TO PREVENT POTENTIAL STREET
 FLOODING DURING THE CONSTRUCTION DURATION.
- 12. A NOTICE OF INTENT (NOI) SHALL BE PREPARED AND SUBMITTED TO THE EPA UNDER THE NPDES CGP. A SWPPP SHALL BE PREPARED AND MAINTANCE ON SITE. THE NOI AND SWPPP SHALL ALSO BE SUBMITTED TO DPW.

GRAPHIC SCALE





PROFESSIONAL ENGINEER FOR ALLEN & MAJOR ASSOCIATES, INC.

REV	DATE	DESCRIPTION	

SIG SAUER 7-8 AMAROSA DRIVE ROCHESTER, NH 03868

7,8,16 AMAROSA DRIVE 0,124 MILTON ROAD ROCHESTER, NH 03868

PROJECT NO. 2912-01A DATE: SCALE: 1° = 100' DWG, NAME: C2912-01A DESIGNED BY JRG CHECKED BY:



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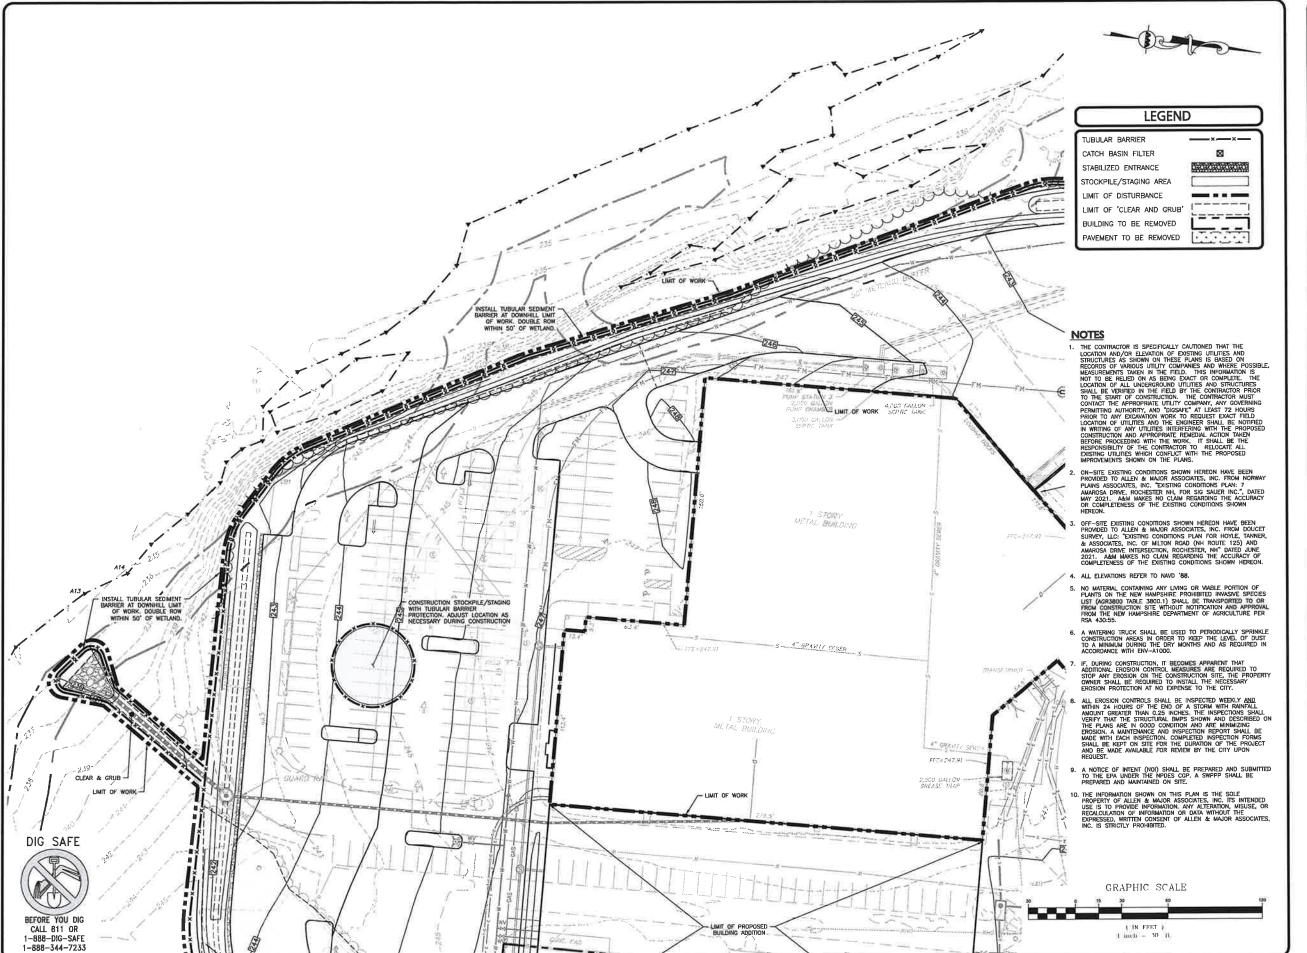
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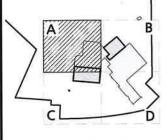
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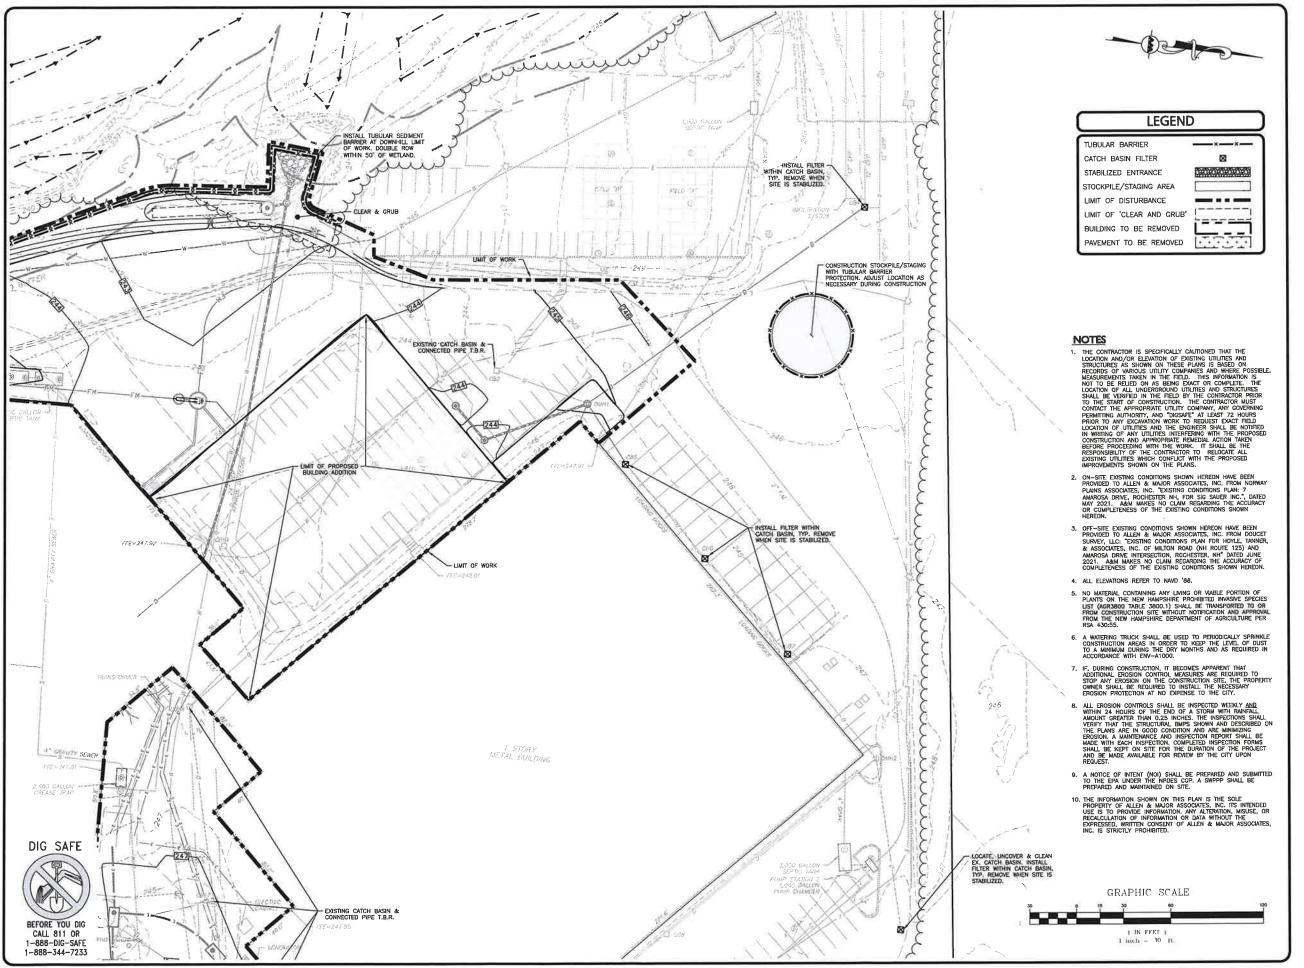
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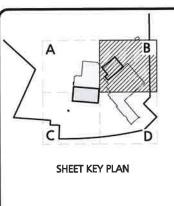
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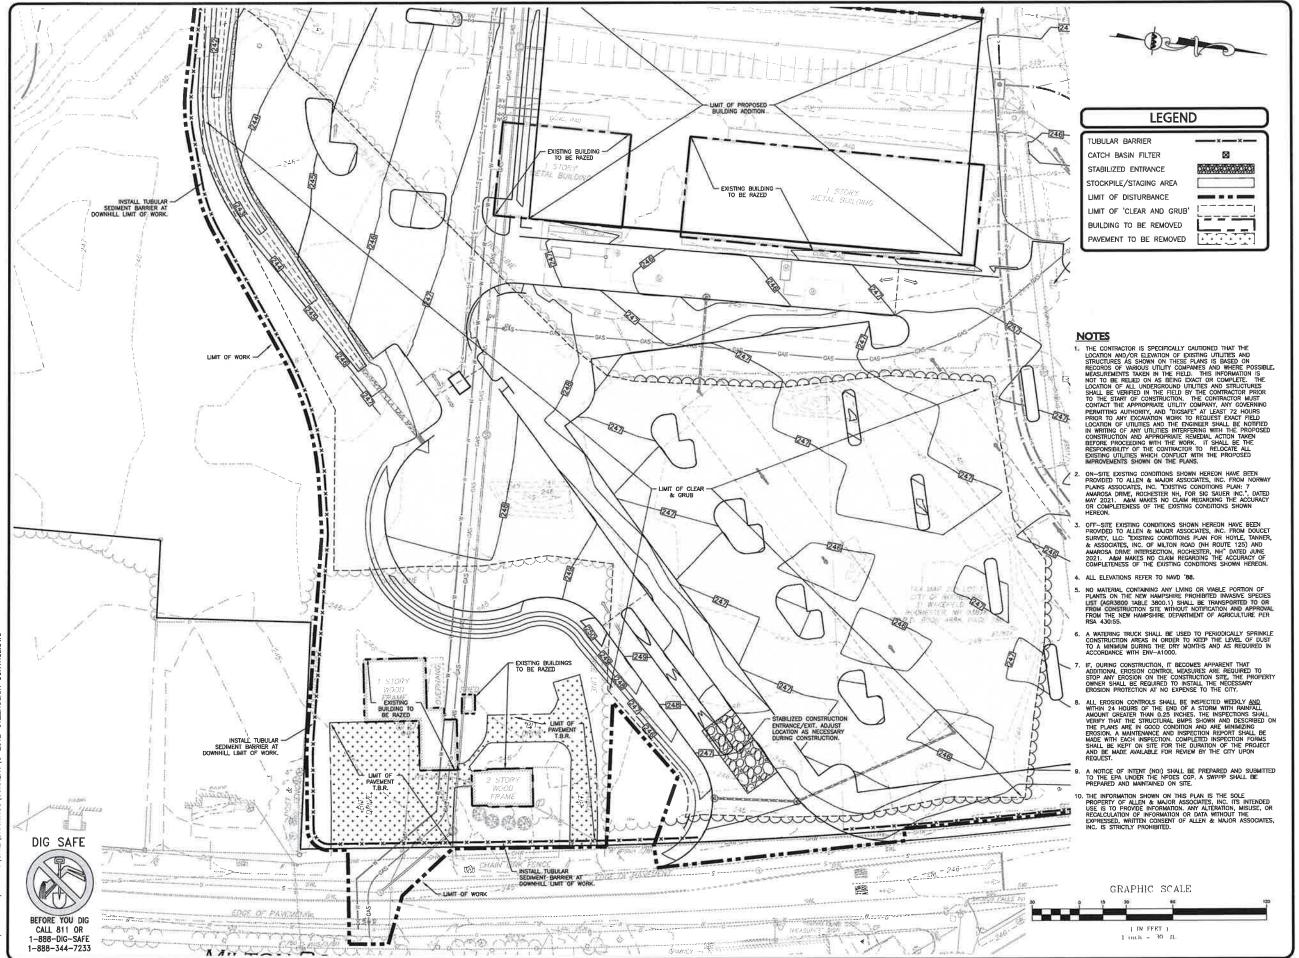
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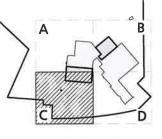
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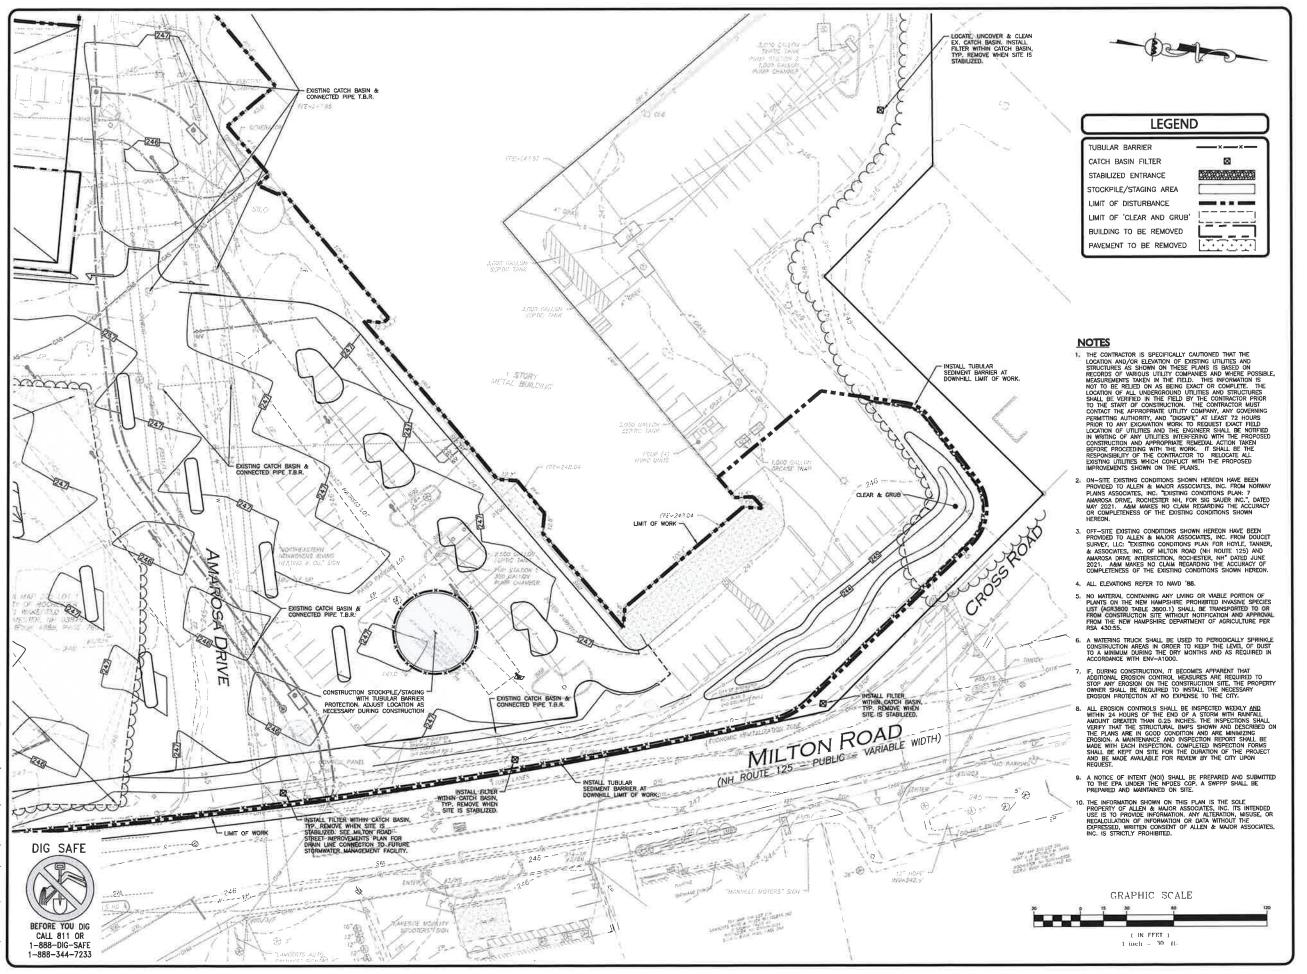
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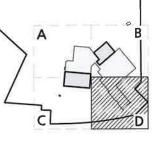
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PROFESSIONAL ENGINEER FOR ALLEN & MAJOR ASSOCIATES, INC.

APPLICANT

SIG SAUER 7-8 AMAROSA DRIVE ROCHESTER, NH 03868

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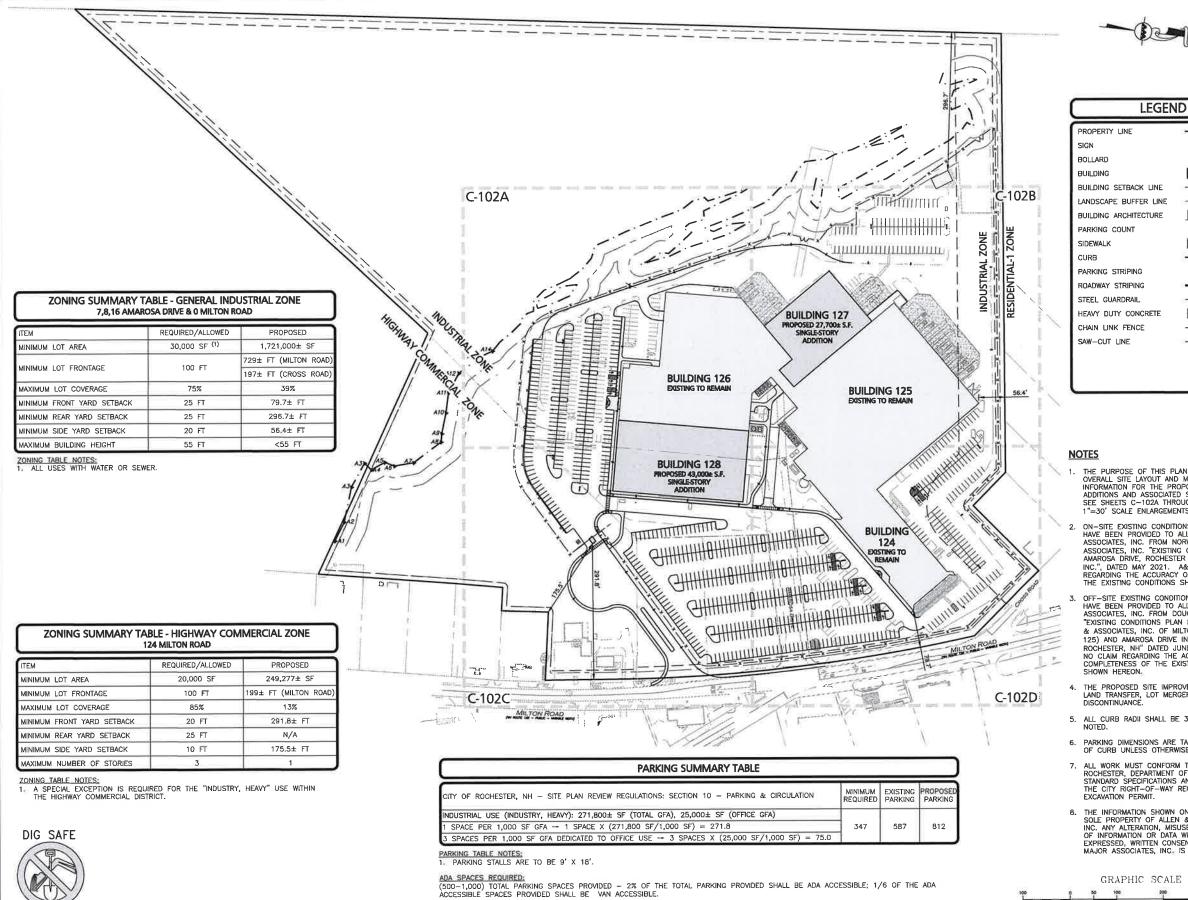
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REV DATE DESCRIPTION

SIG SAUER 7-8 AMAROSA DRIVE ROCHESTER, NH 03868

7,8,16 AMAROSA DRIVE 0.124 MILTON ROAD **ROCHESTER, NH 03868**

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OVERALL LAYOUT & MATERIALS PLAN

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GRAPHIC SCALE I IN FFET 1 1 inch - 100 t

THE PURPOSE OF THIS PLAN IS TO PROVIDE OVERALL SITE LAYOUT AND MATERIALS INFORMATION FOR THE PROPOSED BUILDING ADDITIONS AND ASSOCIATED SITE IMPROVEMENTS. SEE SHEETS C-102A THROUGH C-102D FOR 1"=30' SCALE ENLARGEMENTS.

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ON-SITE EXISTING CONDITIONS SHOWN HEREON HAVE BEEN PROVIDED TO ALLEN & MAJOR ASSOCIATES, INC. FROM NORWAY PLAINS ASSOCIATES, INC. "EXISTING CONDITIONS PLAN: 7 AMAROSA DRIVE, ROCHESTER NH, FOR SIG SAUER INC.", DATED MAY 2021. A&M MAKES NO CLAIM REGARDING THE ACCURACY OR COMPLETENESS OF THE EXISTING CONDITIONS SHOWN HEREON.

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4. THE PROPOSED SITE IMPROVEMENTS REQUIRE A LAND TRANSFER, LOT MERGER, AND STREET

5. ALL CURB RADII SHALL BE 3' UNLESS OTHERWISE

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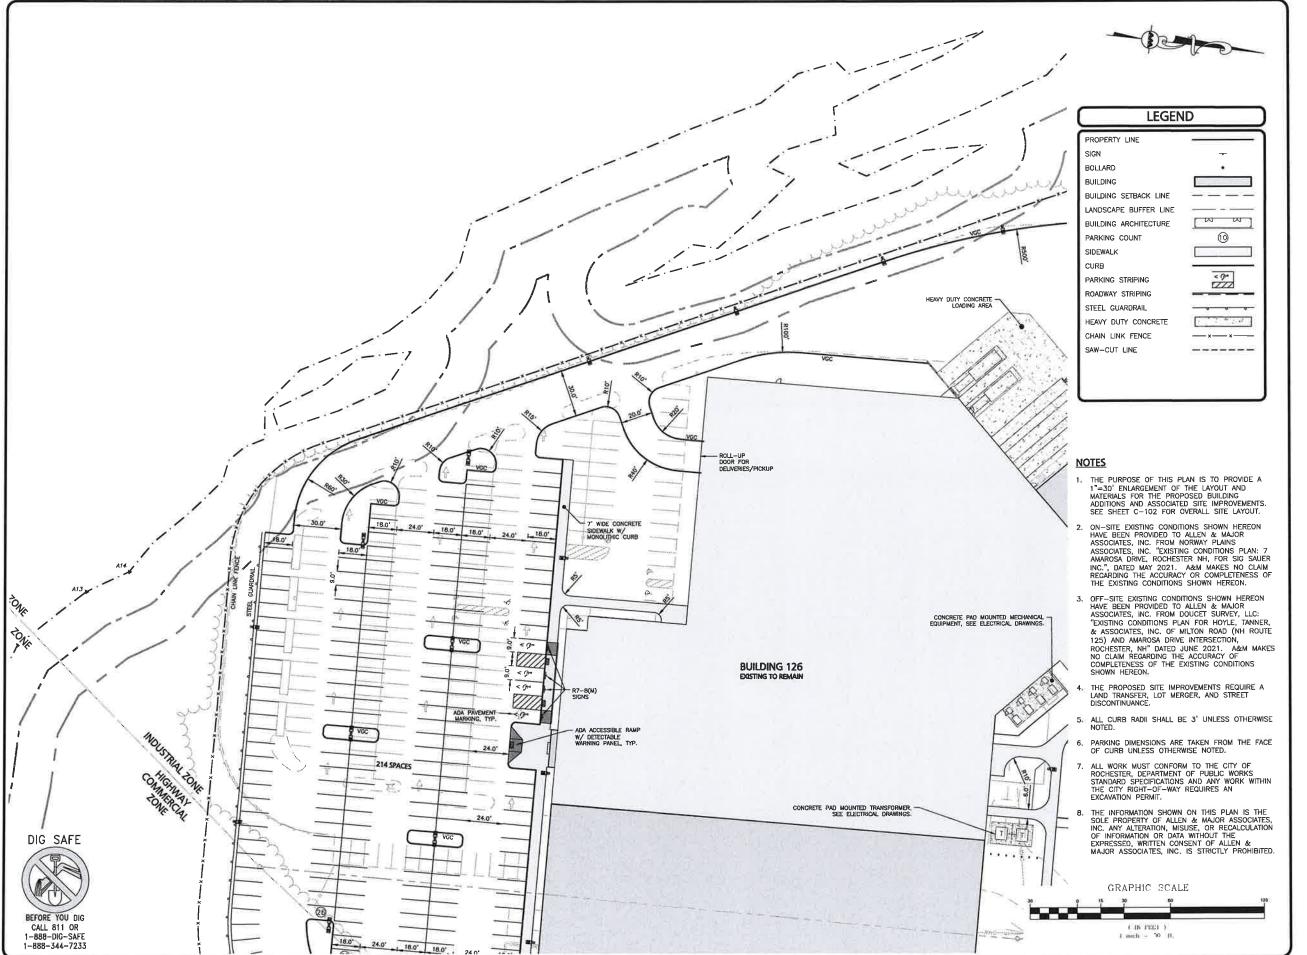
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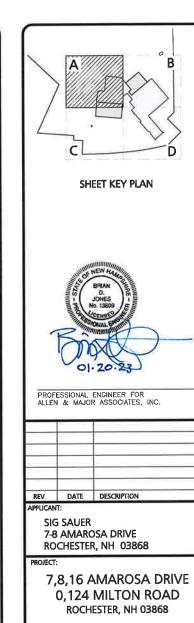
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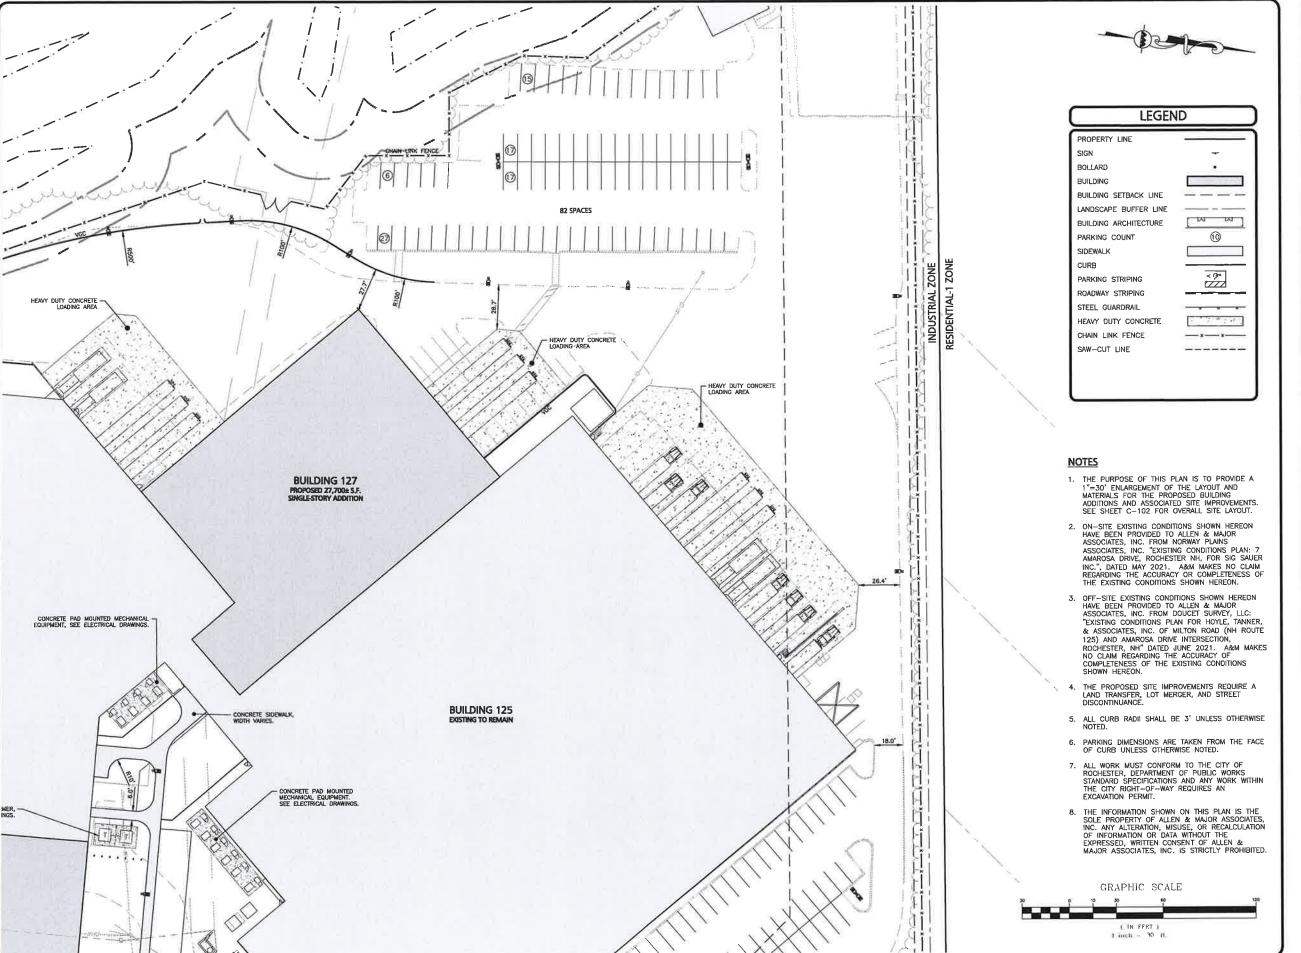
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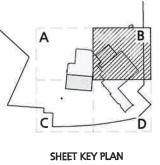
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REV	DATE	DESCRIPTION	

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PROJECT NO.	2912-01A	DATE:	01-20-23
SCALE:	1° = 30'	DWG. NAME:	C2912-01A
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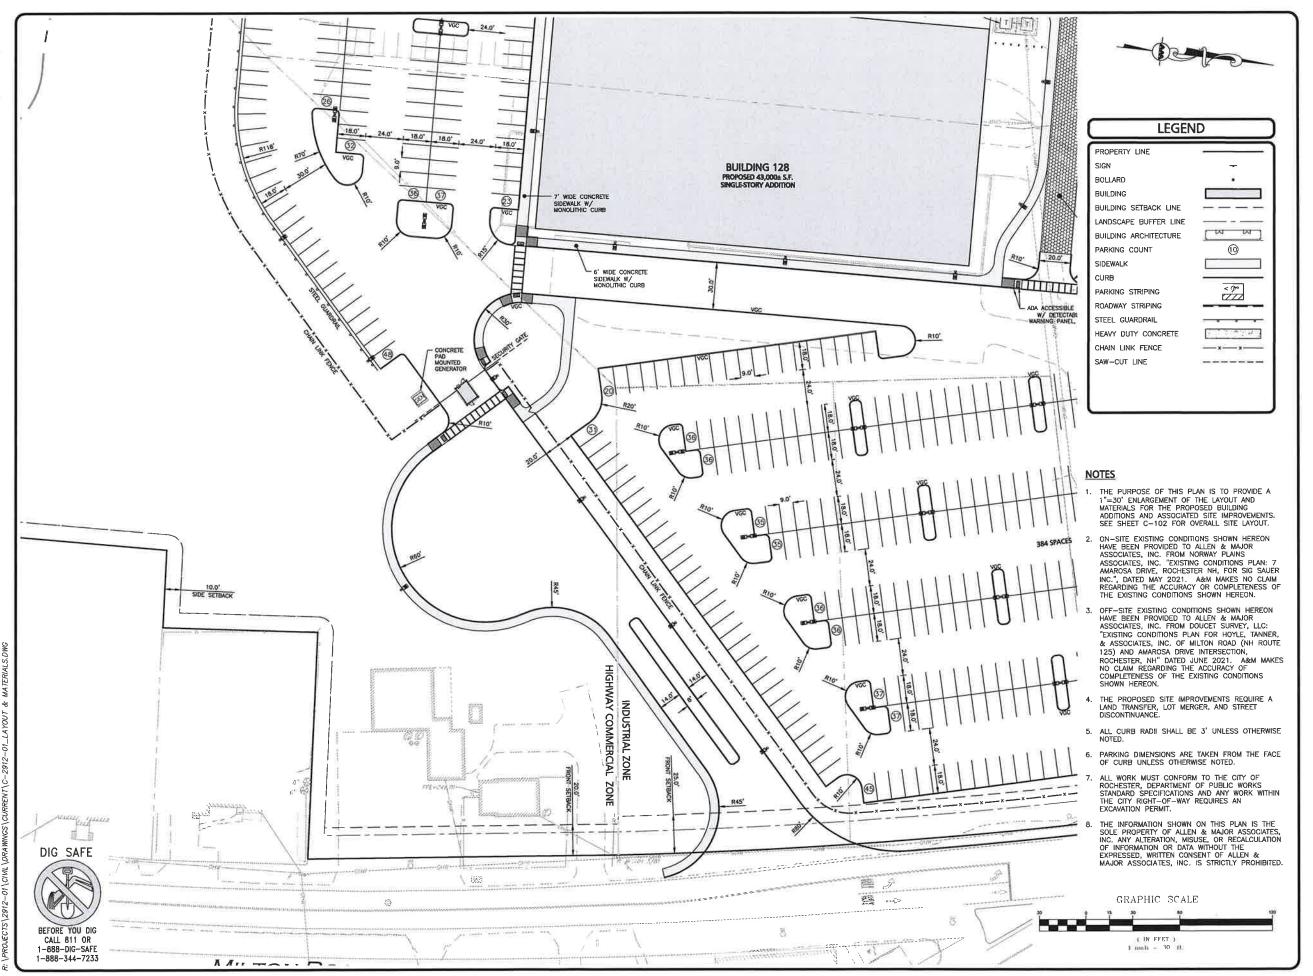
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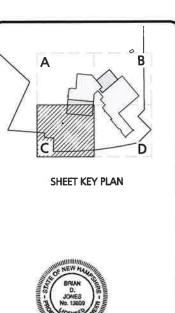
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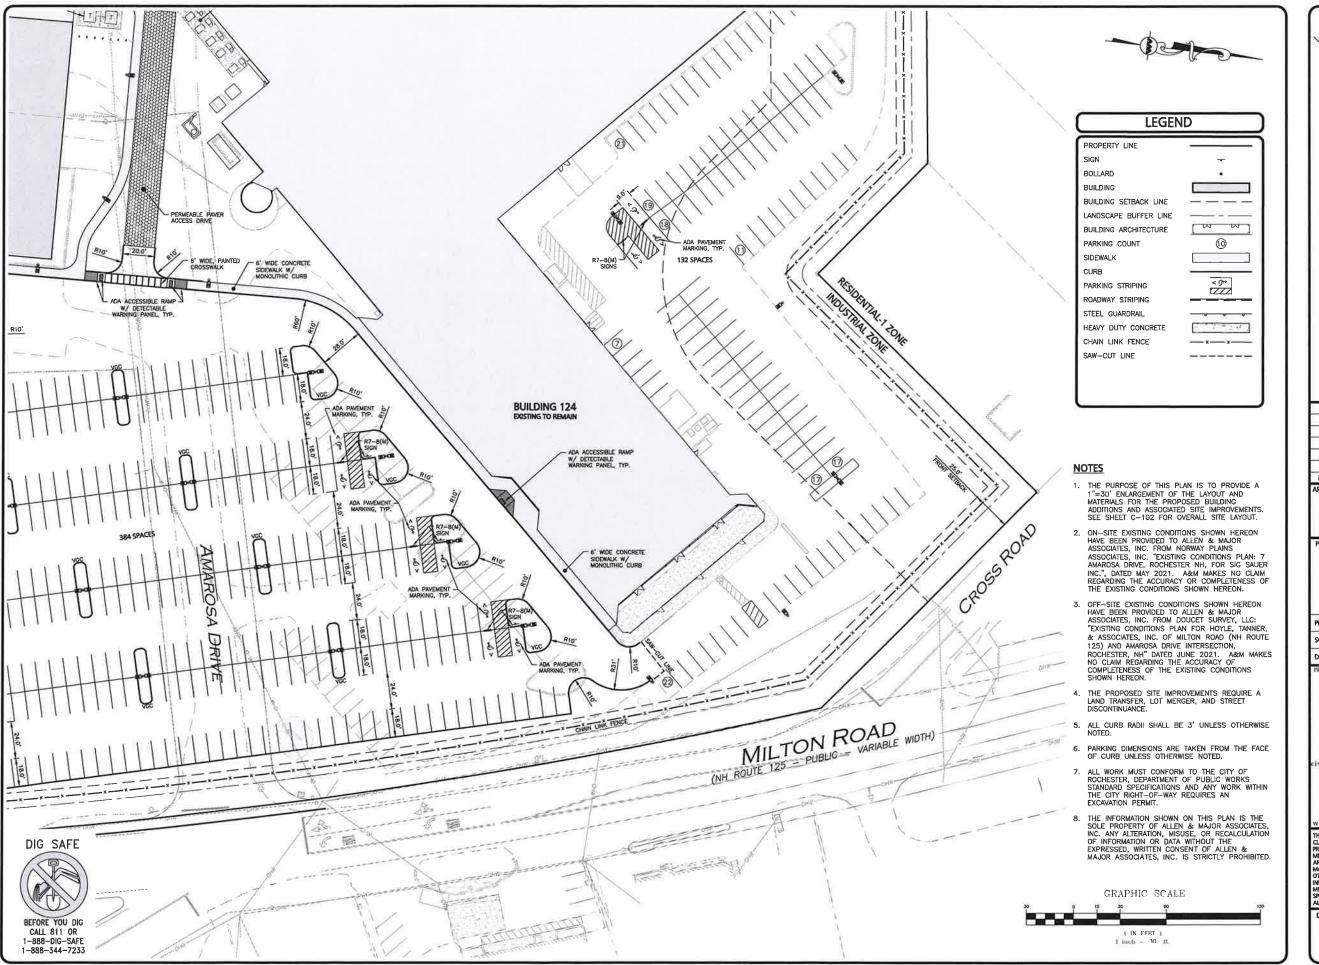
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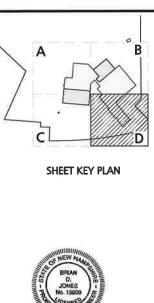
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PPLICANT

SIG SAUER 7-8 AMAROSA DRIVE ROCHESTER, NH 03868

7,8,16 AMAROSA DRIVE 0,124 MILTON ROAD ROCHESTER, NH 03868

-	PROJECT NO.	2912-01A	DATE:	01-20-23
1	SCALE:	1" - 100'	DWG. NAME:	C2912-01A
ı	DESIGNED BY:	JRG	CHECKED BY:	BDJ



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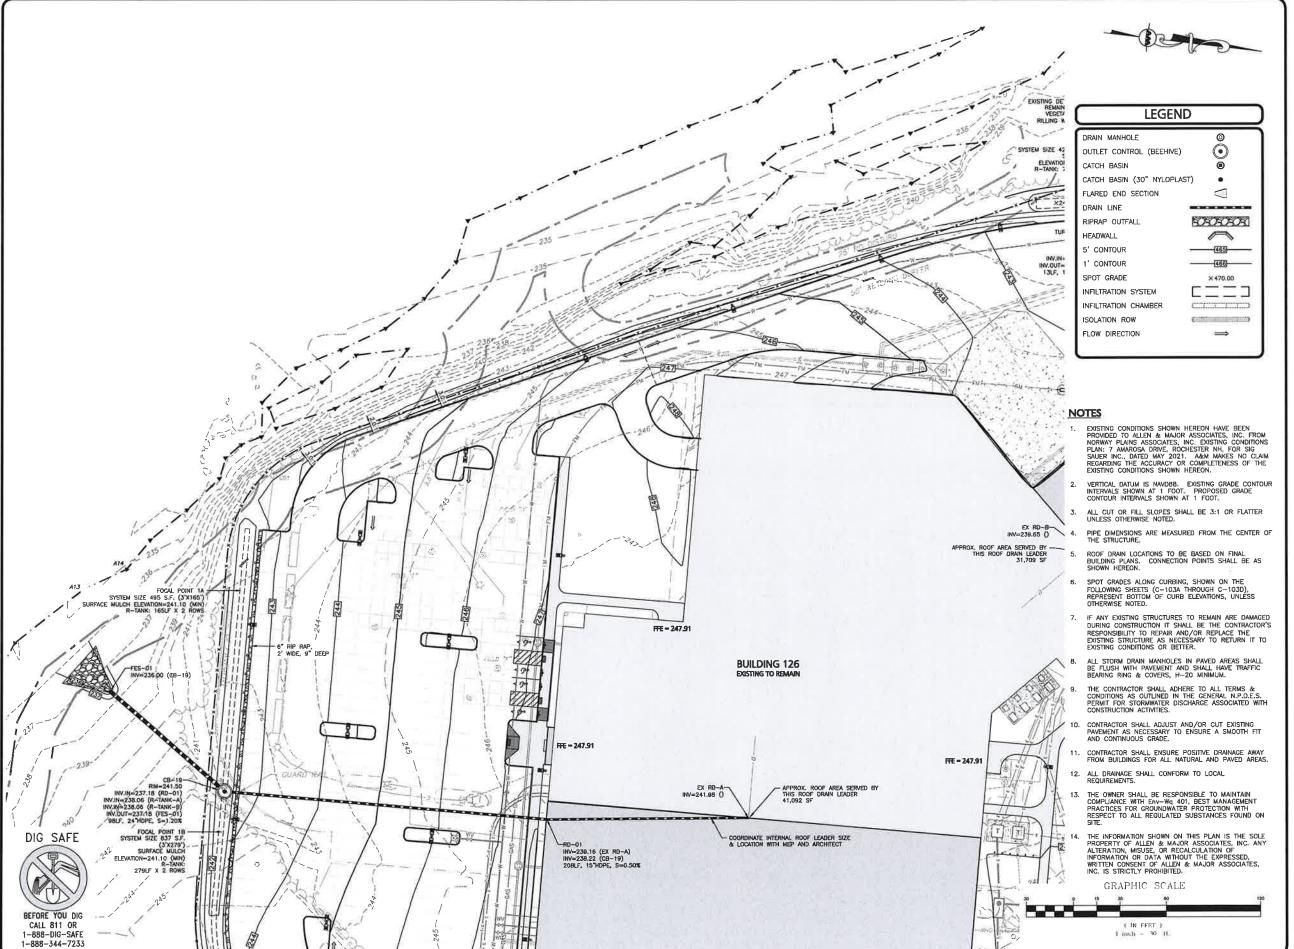
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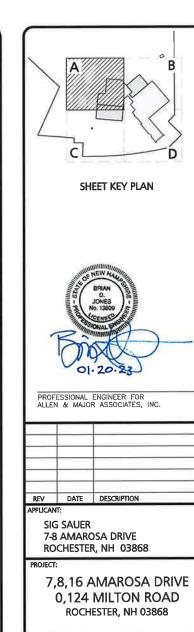
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PROJECT NO. 2912-01A DATE: 01-20-23 1" = 30' DWG, NAME: C2912-01/ SCALE DESIGNED BY JRG CHECKED BY:




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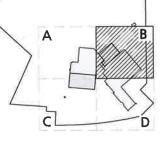
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REV DATE DESCRIPTION

SIG SAUER 7-8 AMAROSA DRIVE ROCHESTER, NH 03868

7,8,16 AMAROSA DRIVE 0.124 MILTON ROAD ROCHESTER, NH 03868

2912-01A DATE: PROJECT NO. 1" = 30' DWG. NAME: C2912-01A DESIGNED BY JRG CHECKED BY:

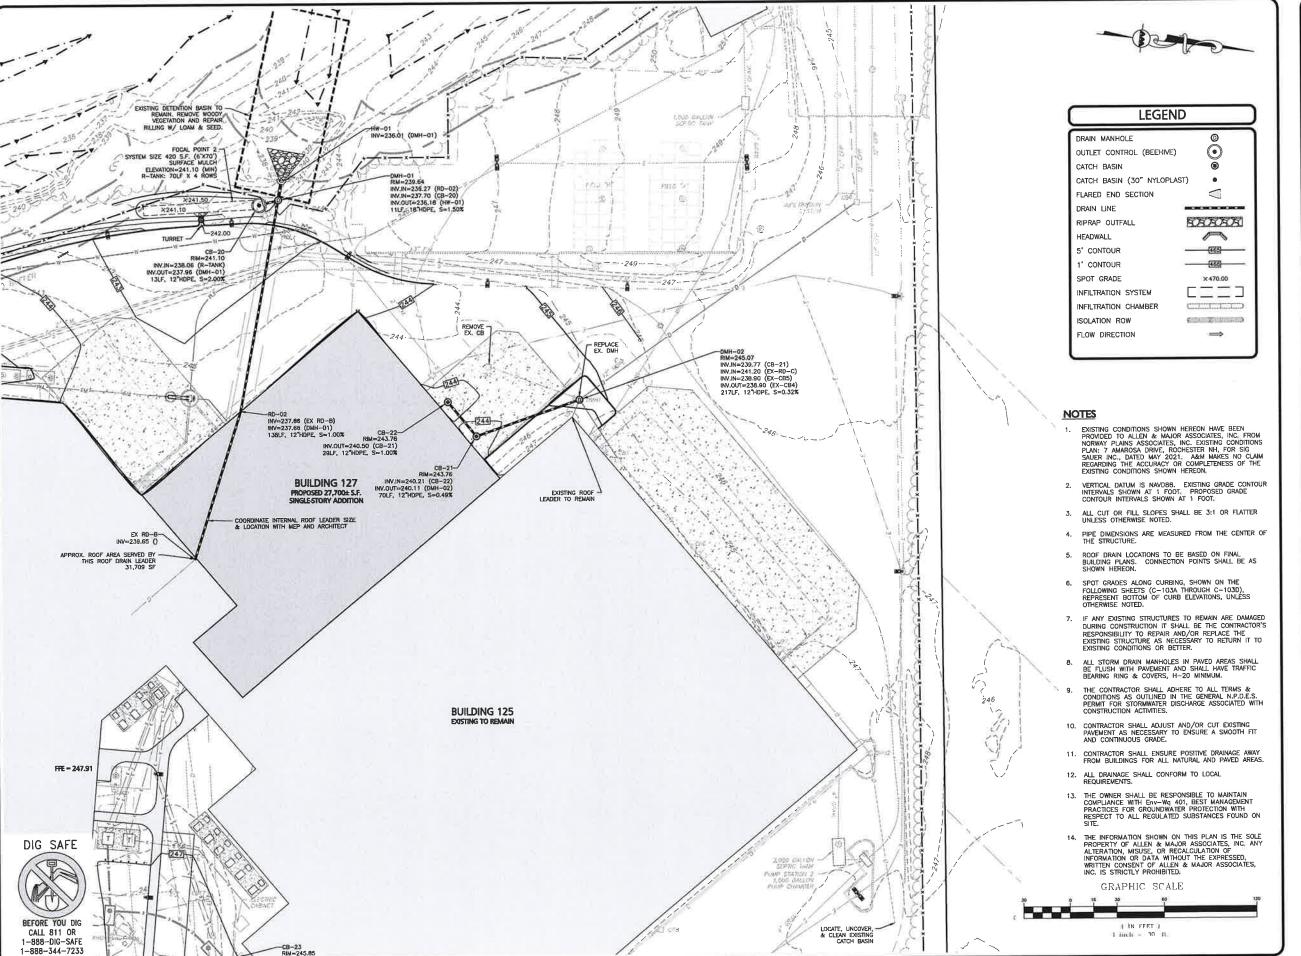

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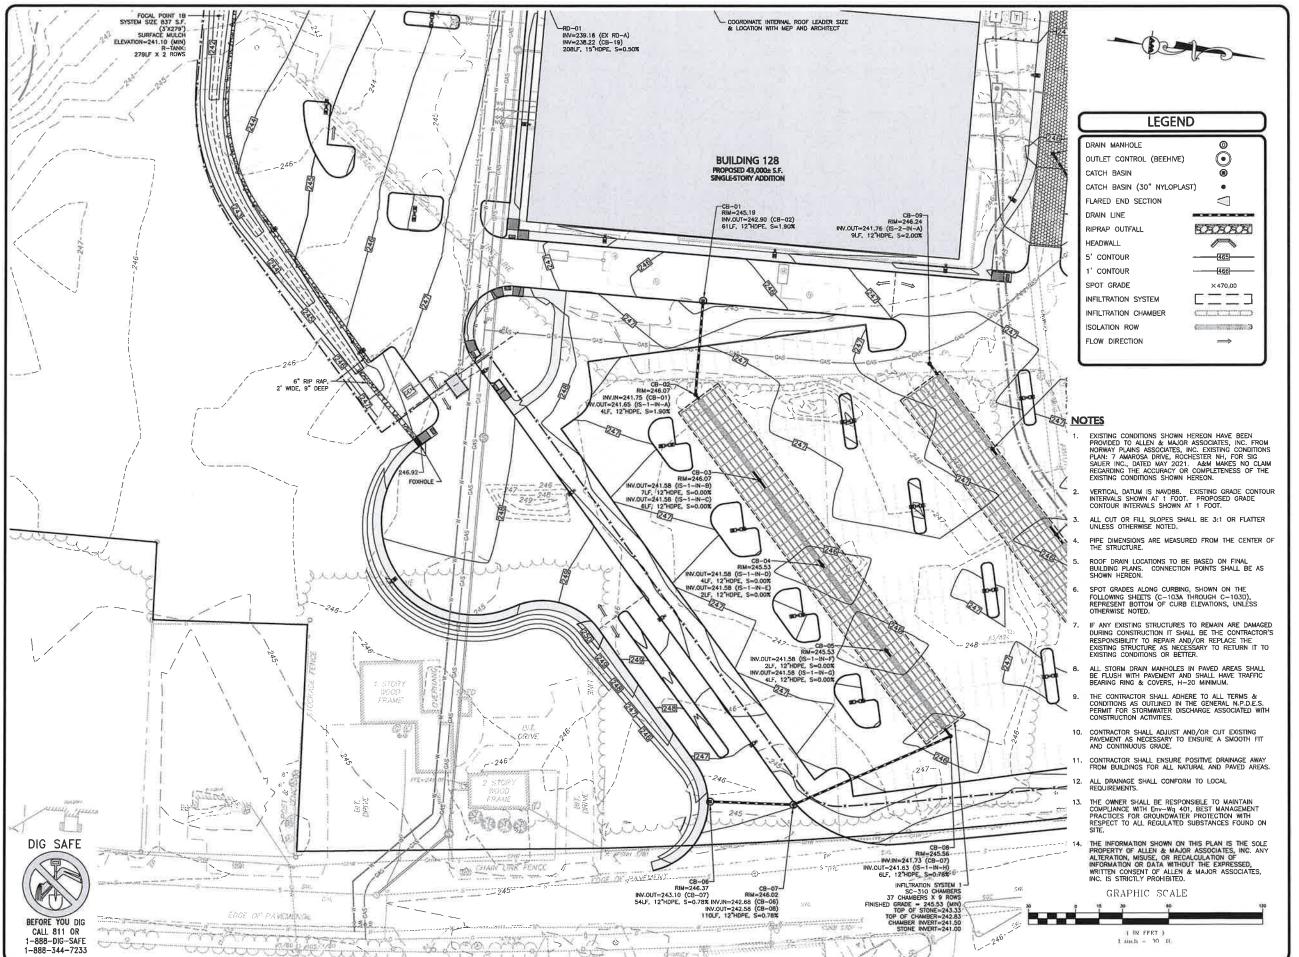
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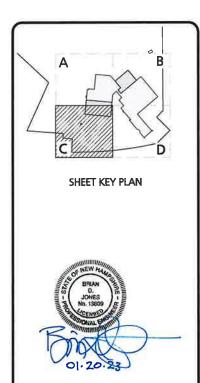
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POJECT:

7,8,16 AMAROSA DRIVE 0,124 MILTON ROAD ROCHESTER, NH 03868

PROJECT NO.	2912-01A	DATE:	01-20-23
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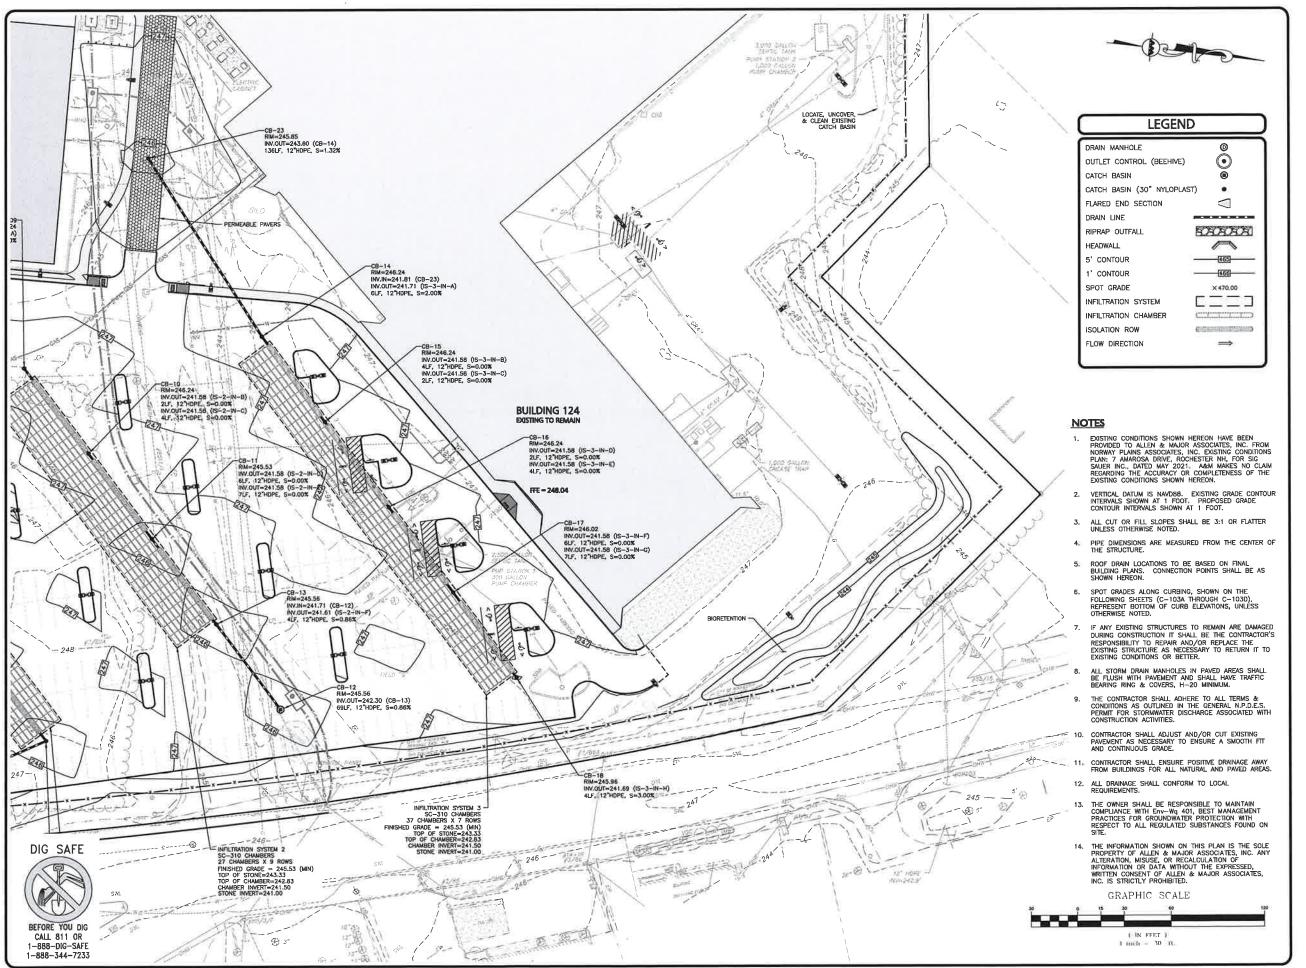
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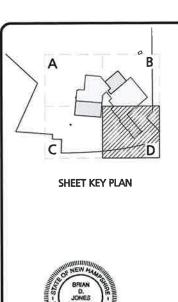
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APPLICANT

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7,8,16 AMAROSA DRIVE 0,124 MILTON ROAD ROCHESTER, NH 03868

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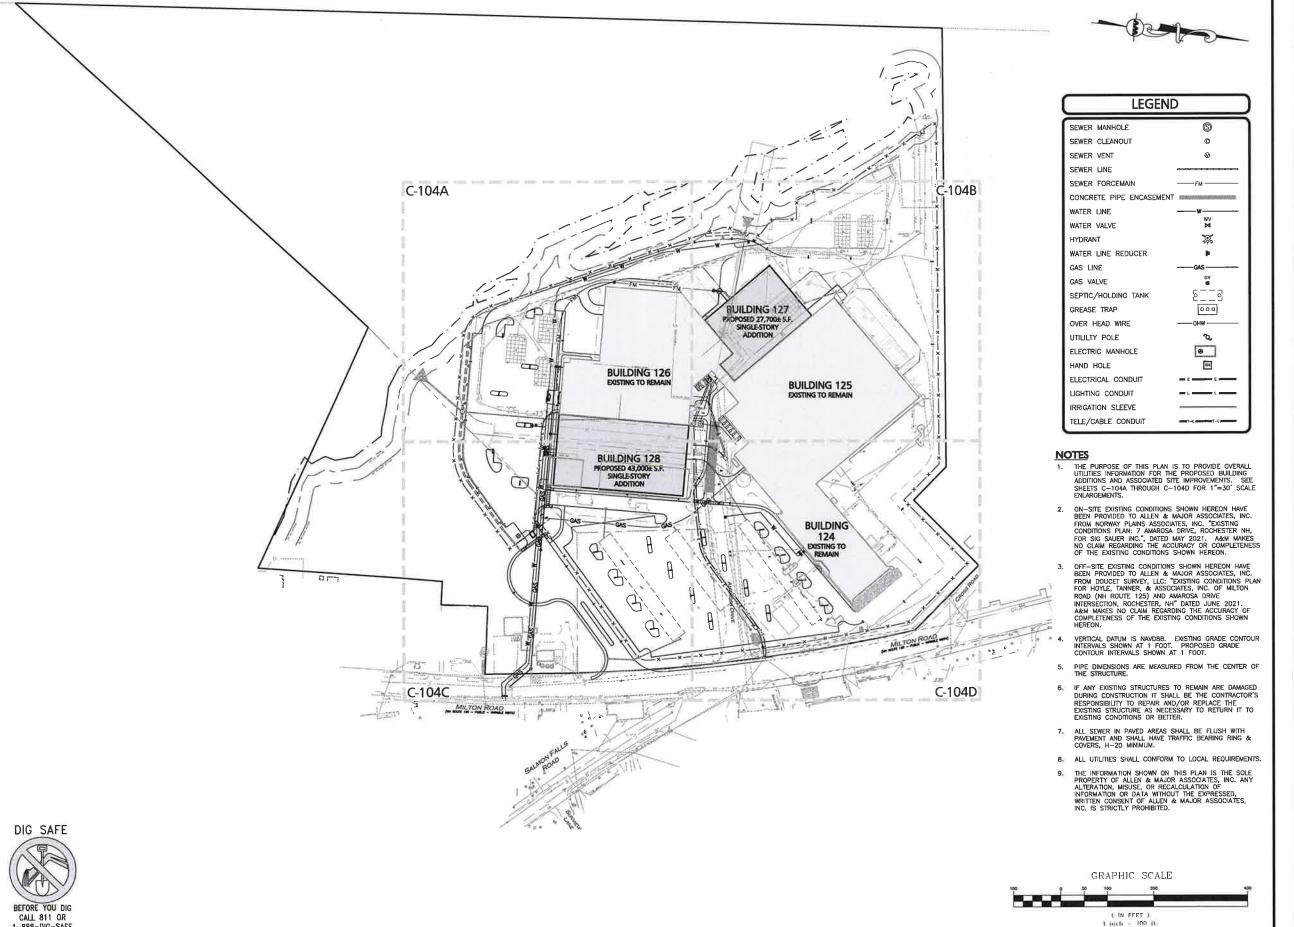
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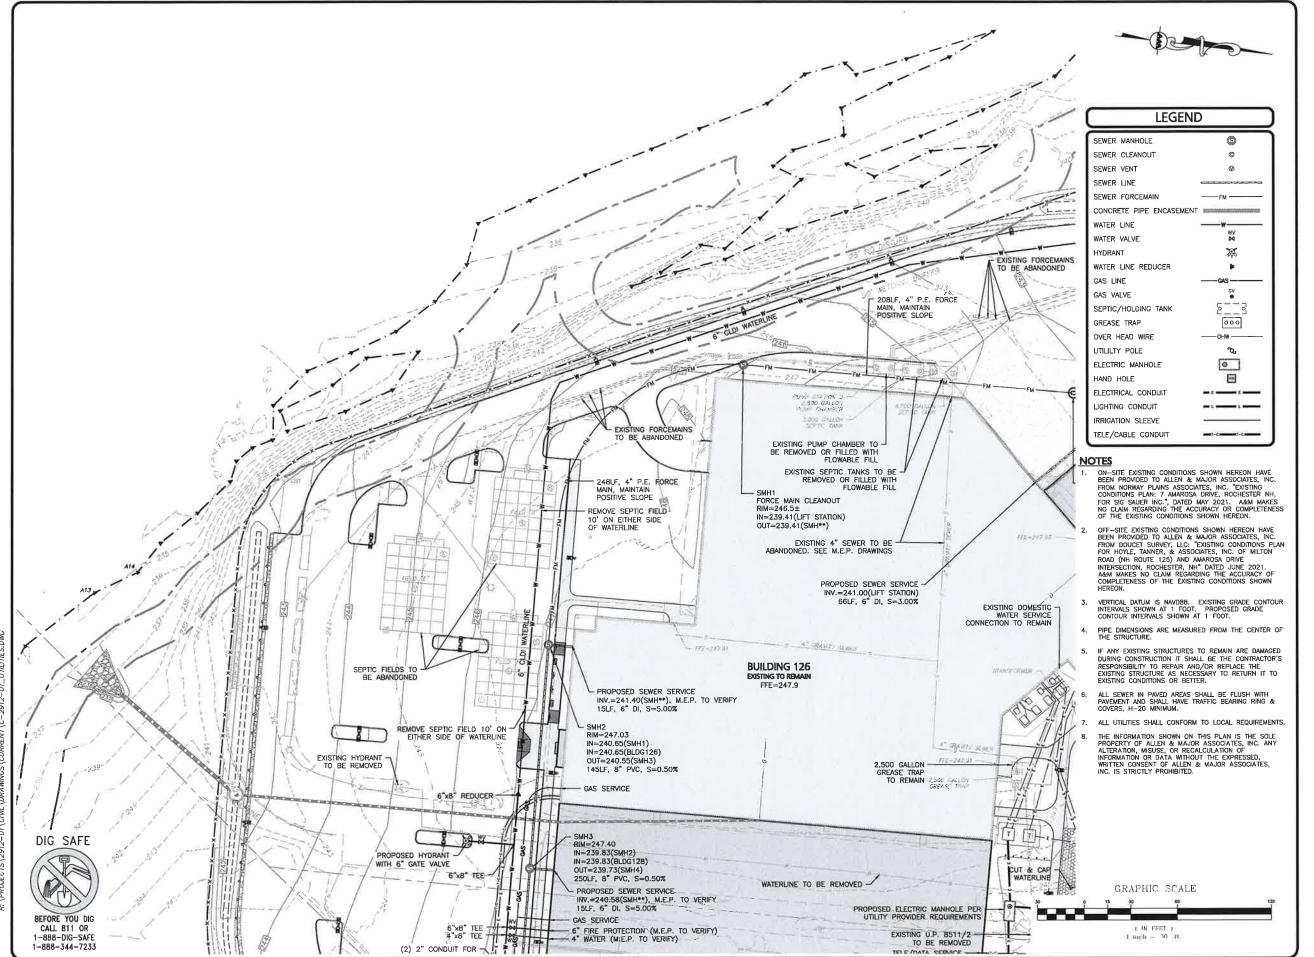
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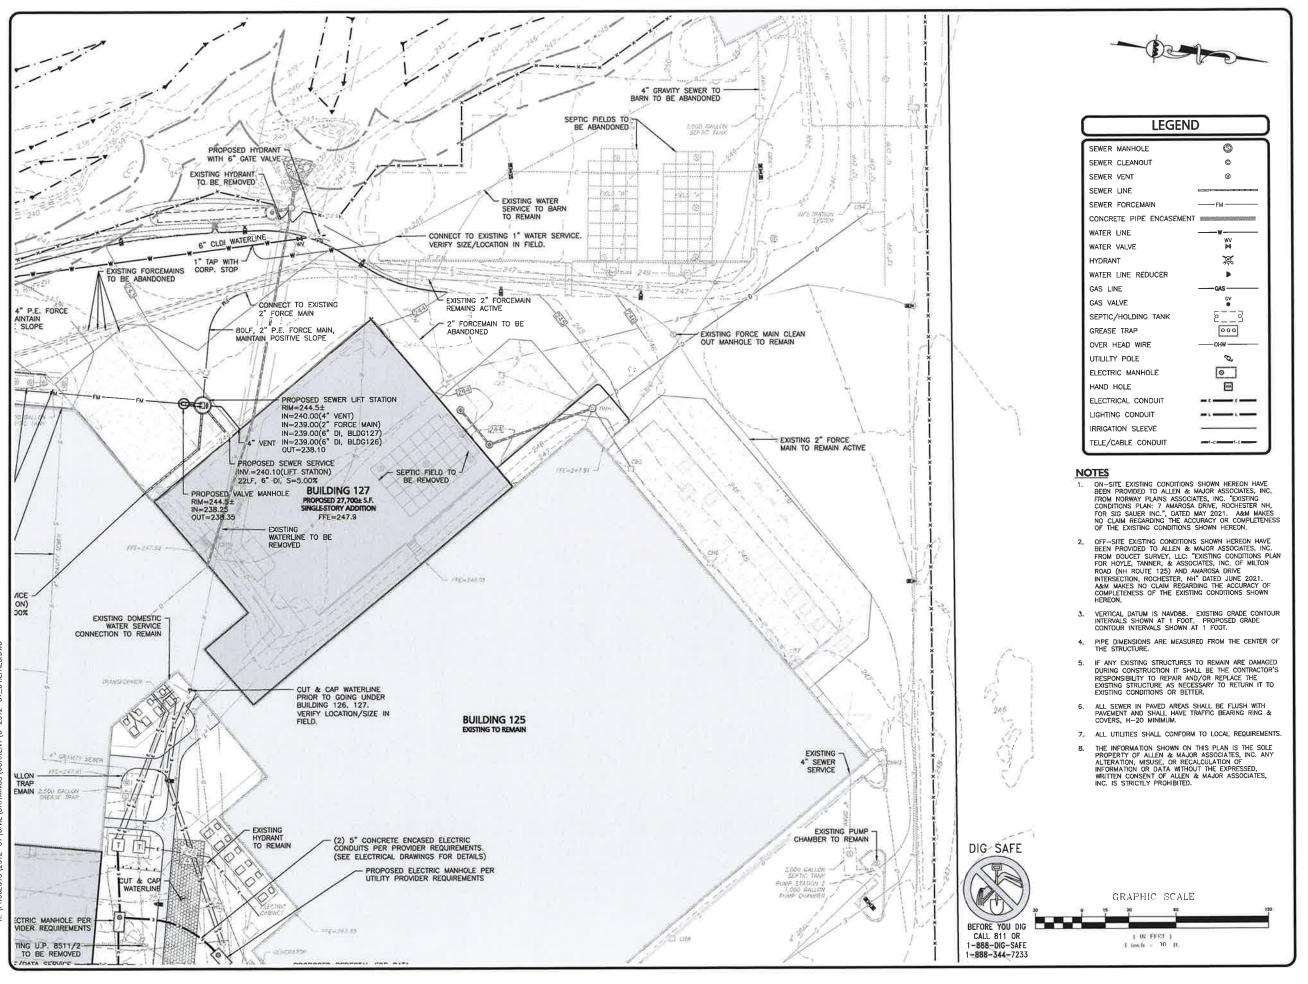
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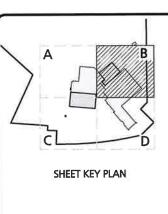
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JRG	CHECKED BY:	BDJ
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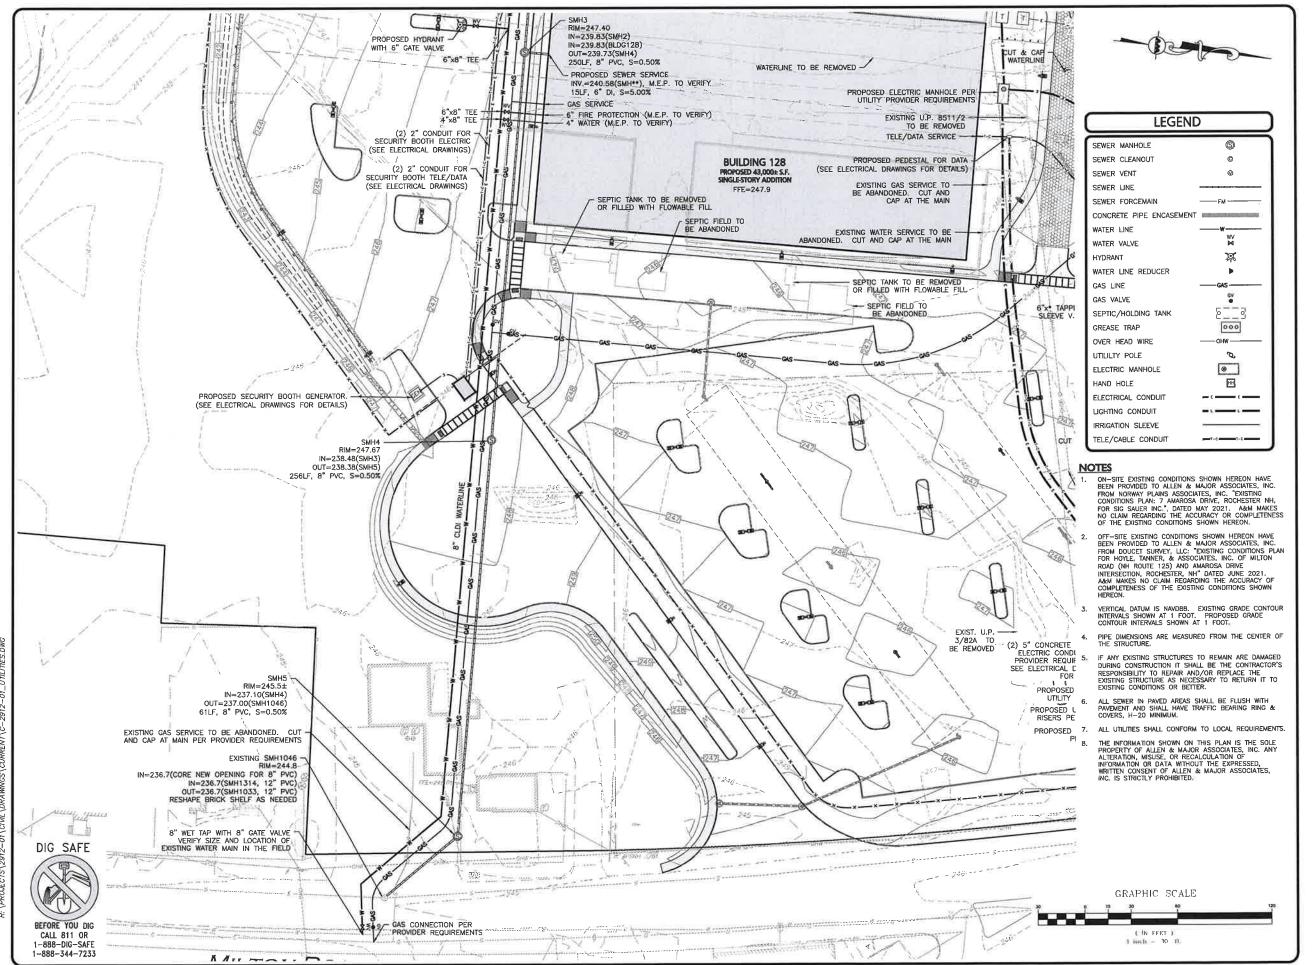
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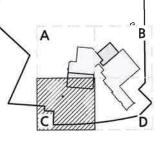
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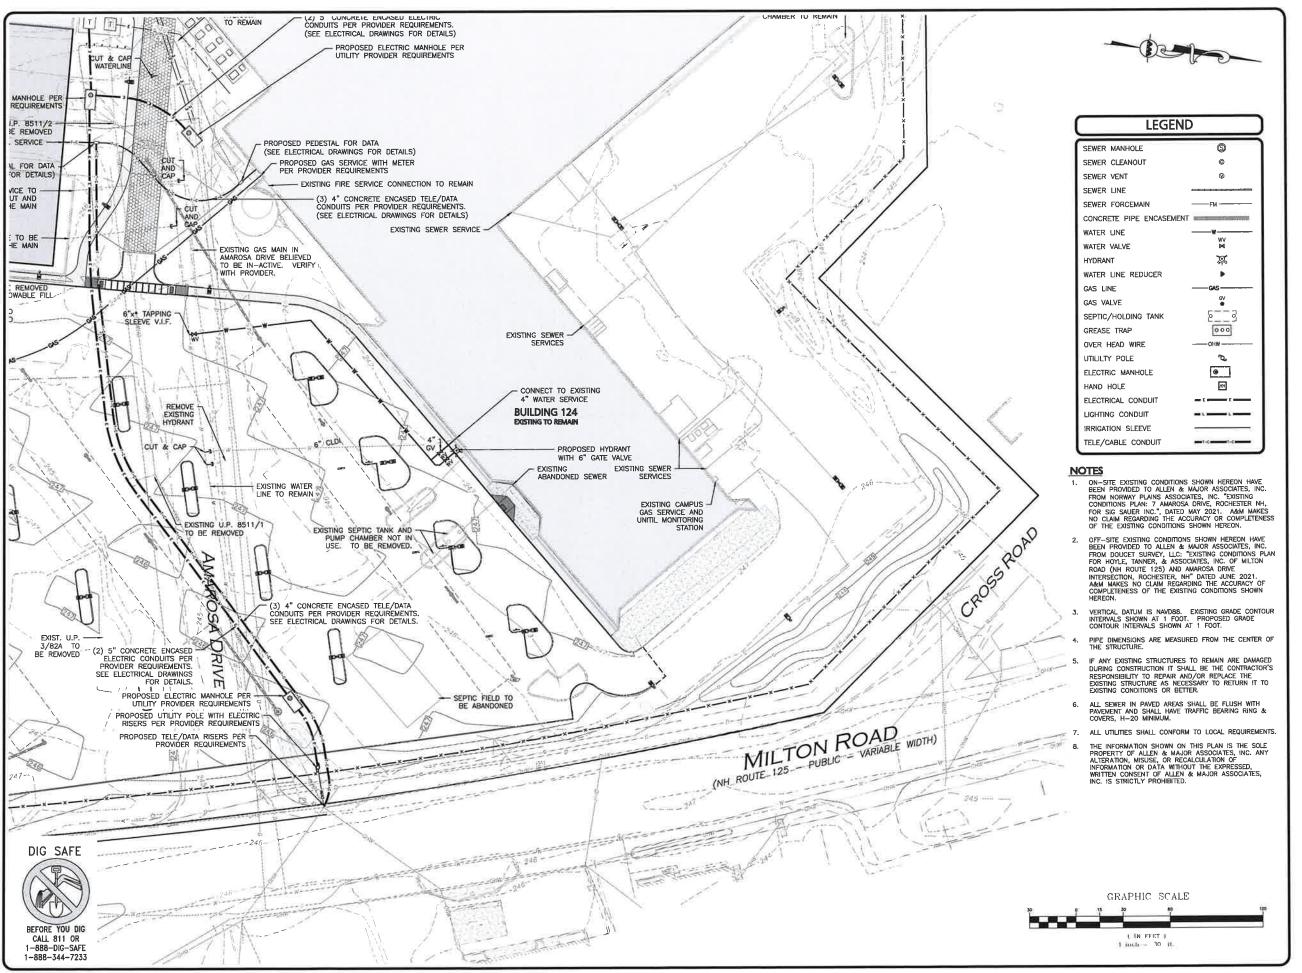
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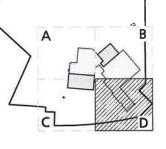
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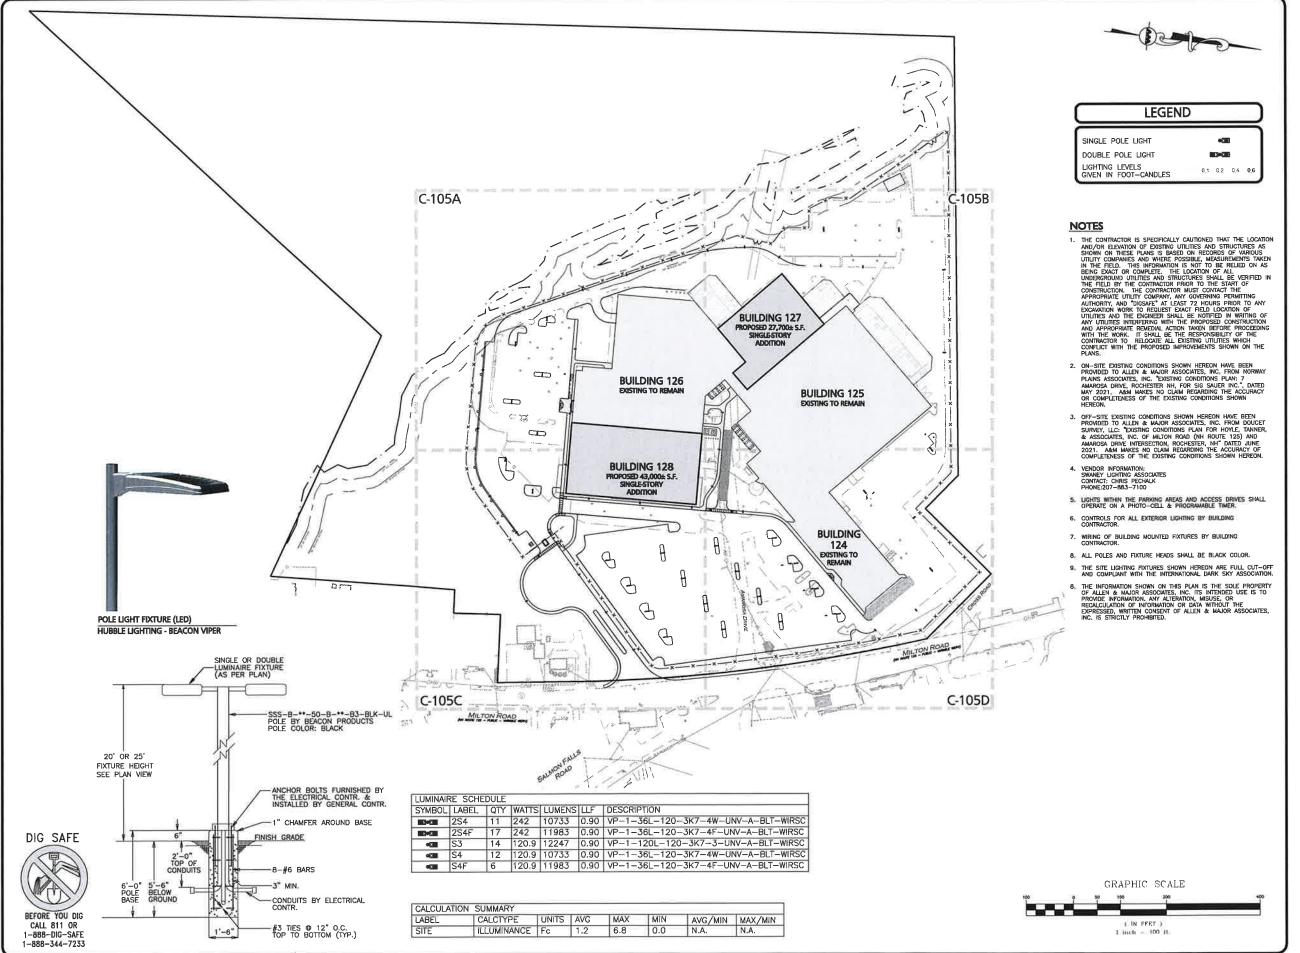
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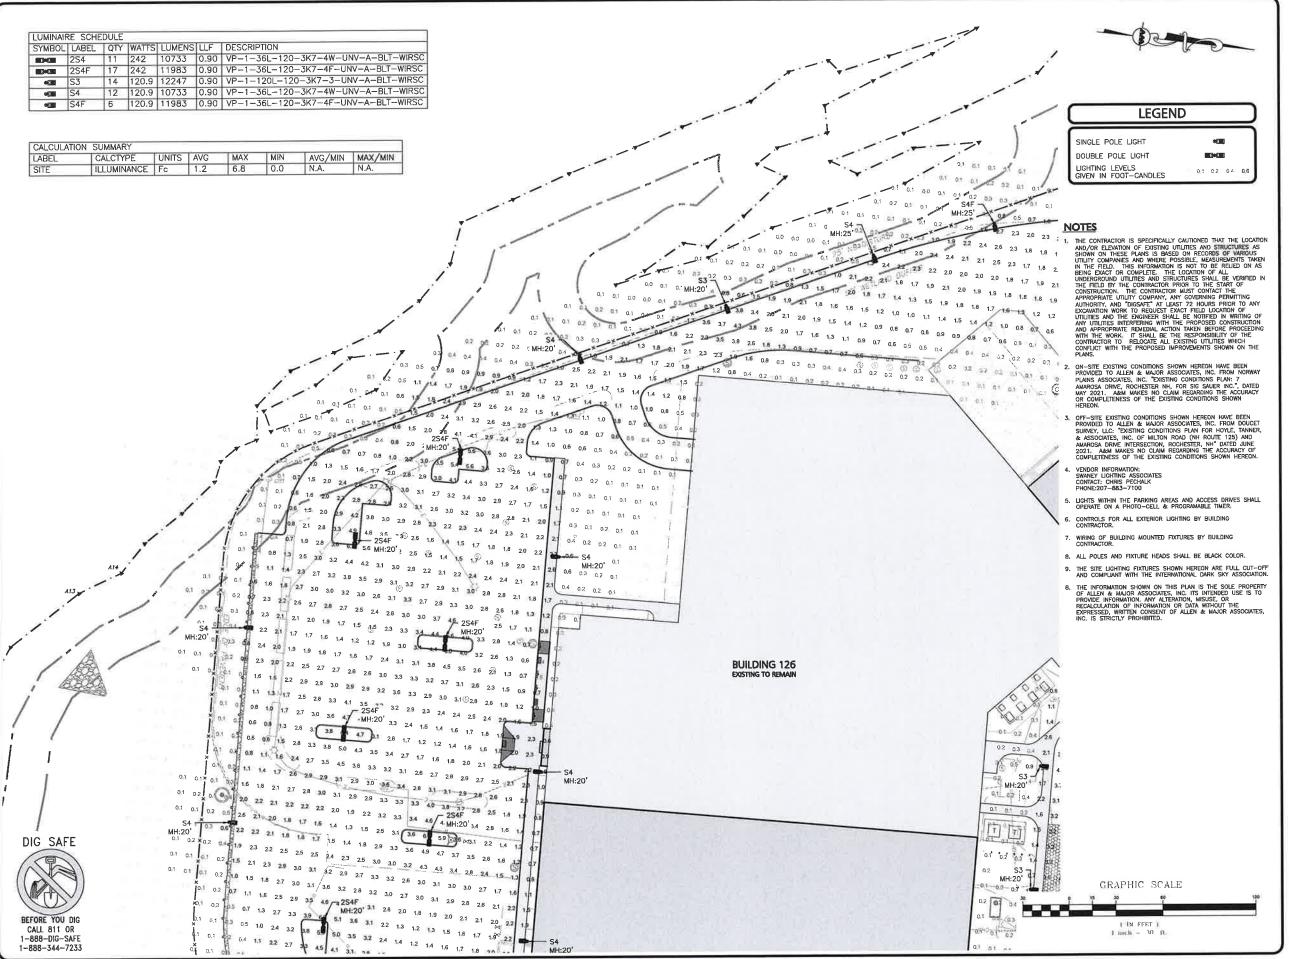
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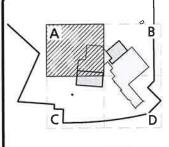
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SHEET KEY PLAN



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SIG SAUER 7-8 AMAROSA DRIVE ROCHESTER, NH 03868

REV DATE DESCRIPTION

PROJECT:

7,8,16 AMAROSA DRIVE 0,124 MILTON ROAD ROCHESTER, NH 03868

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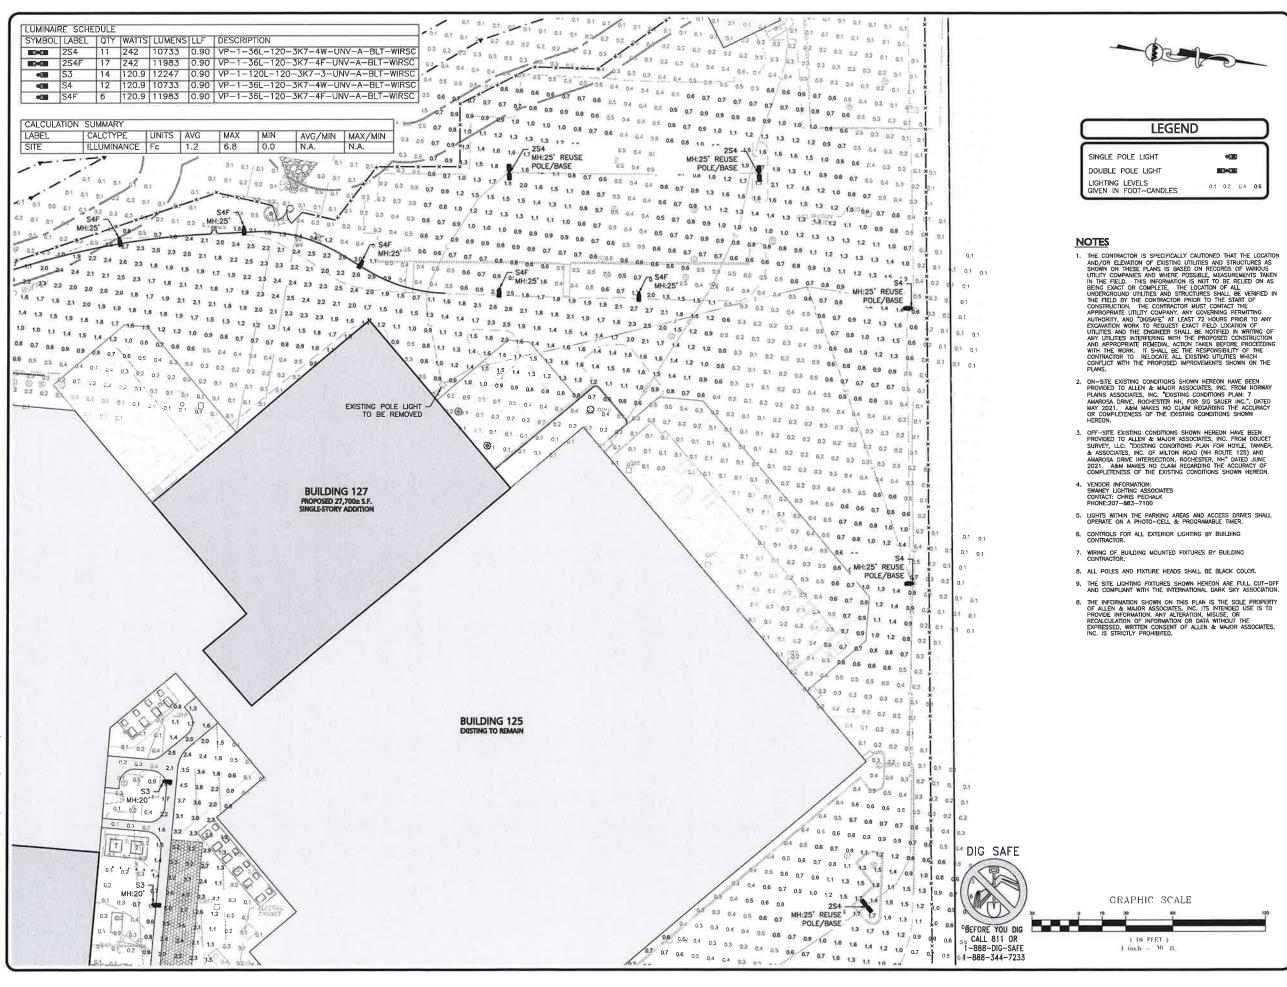
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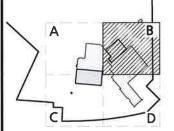
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SITE LIGHTING PLAN

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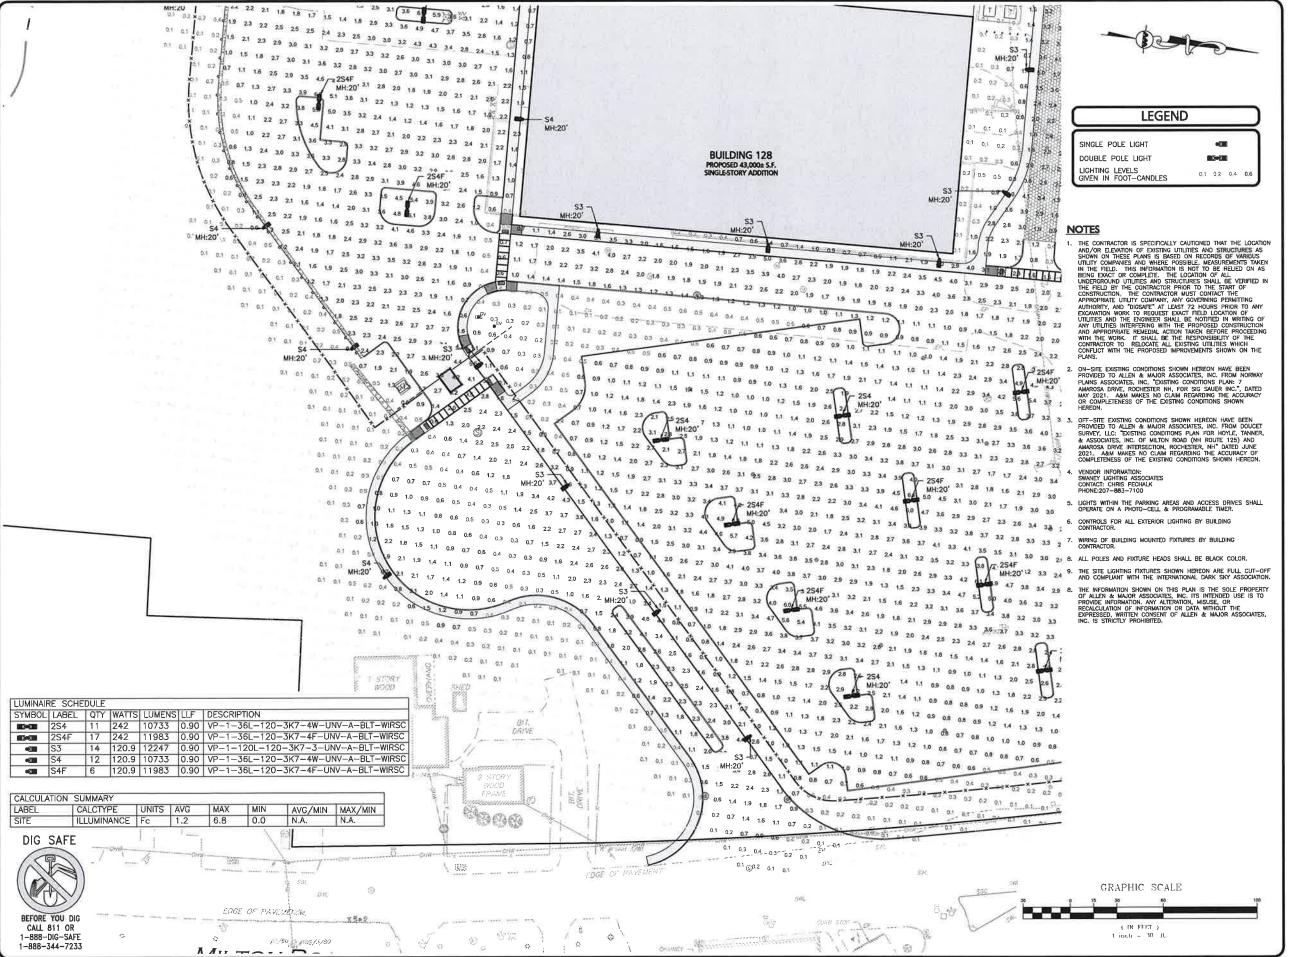
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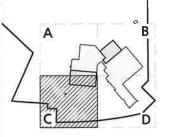
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SHEET KEY PLAN



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REV	DATE	DESCRIPTION

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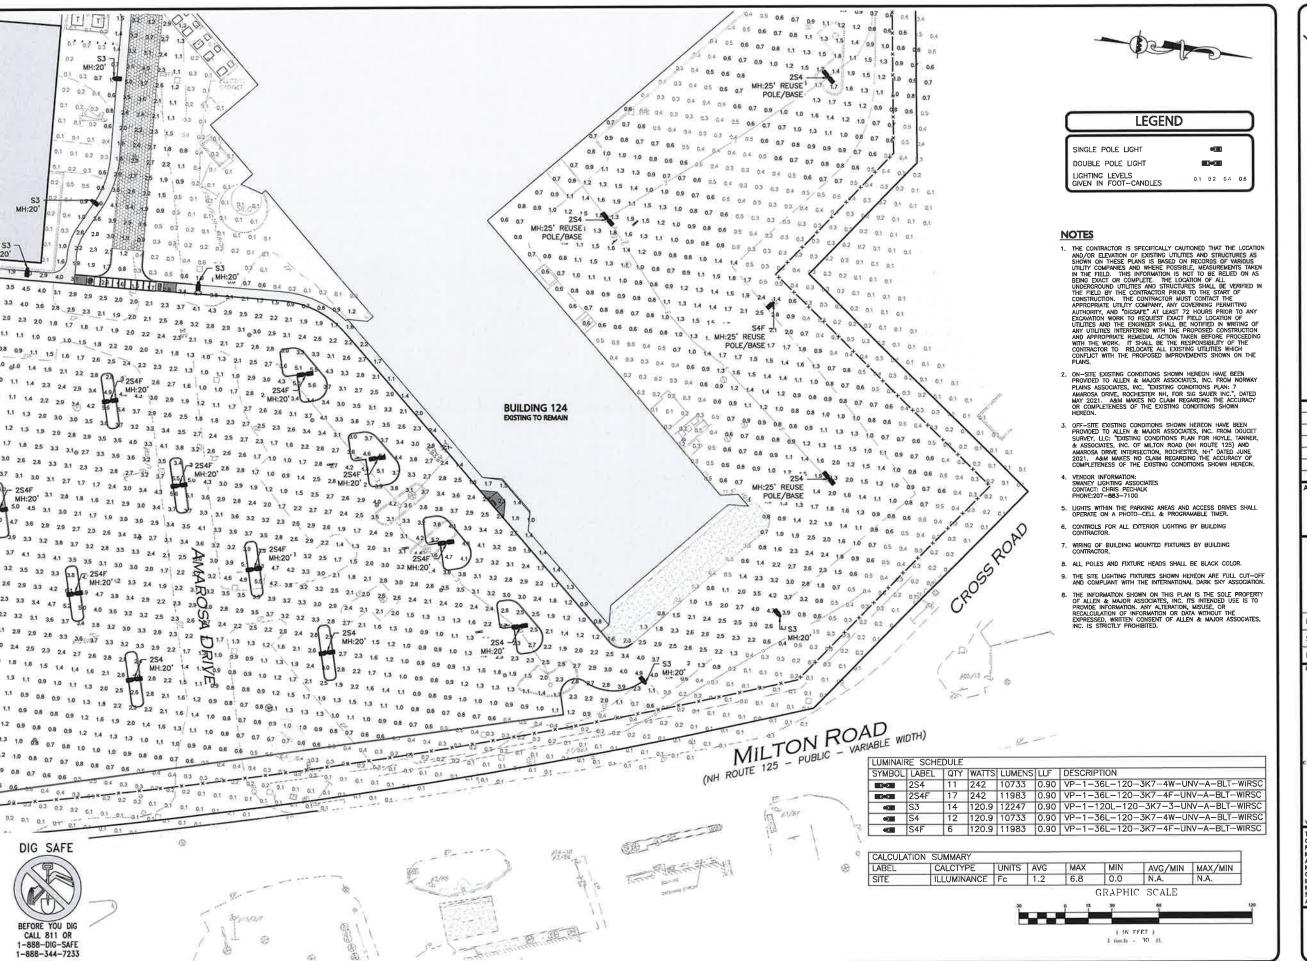
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SIG SAUER
7-8 AMAROSA DRIVE
ROCHESTER, NH 03868

DROJECT

7,8,16 AMAROSA DRIVE 0,124 MILTON ROAD ROCHESTER, NH 03868

PROJECT NO.	2912-01A	DATE:	01-20-23		
SCALE:	1" = 30'	DWG. NAME:	C2912-01A		
DESIGNED BY:	JRG	CHECKED BY:	BD.		

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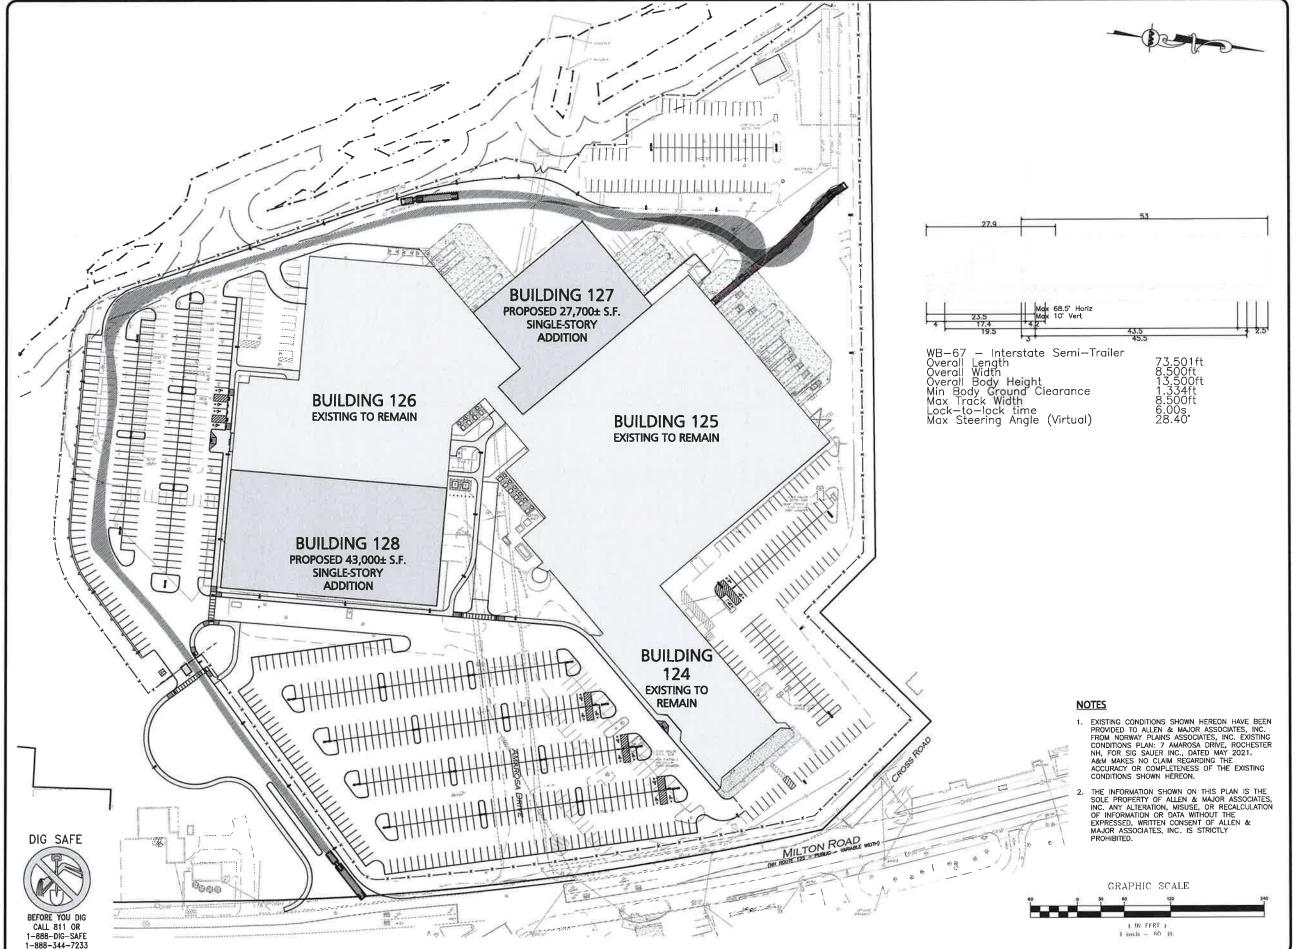
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SITE LIGHTING PLAN

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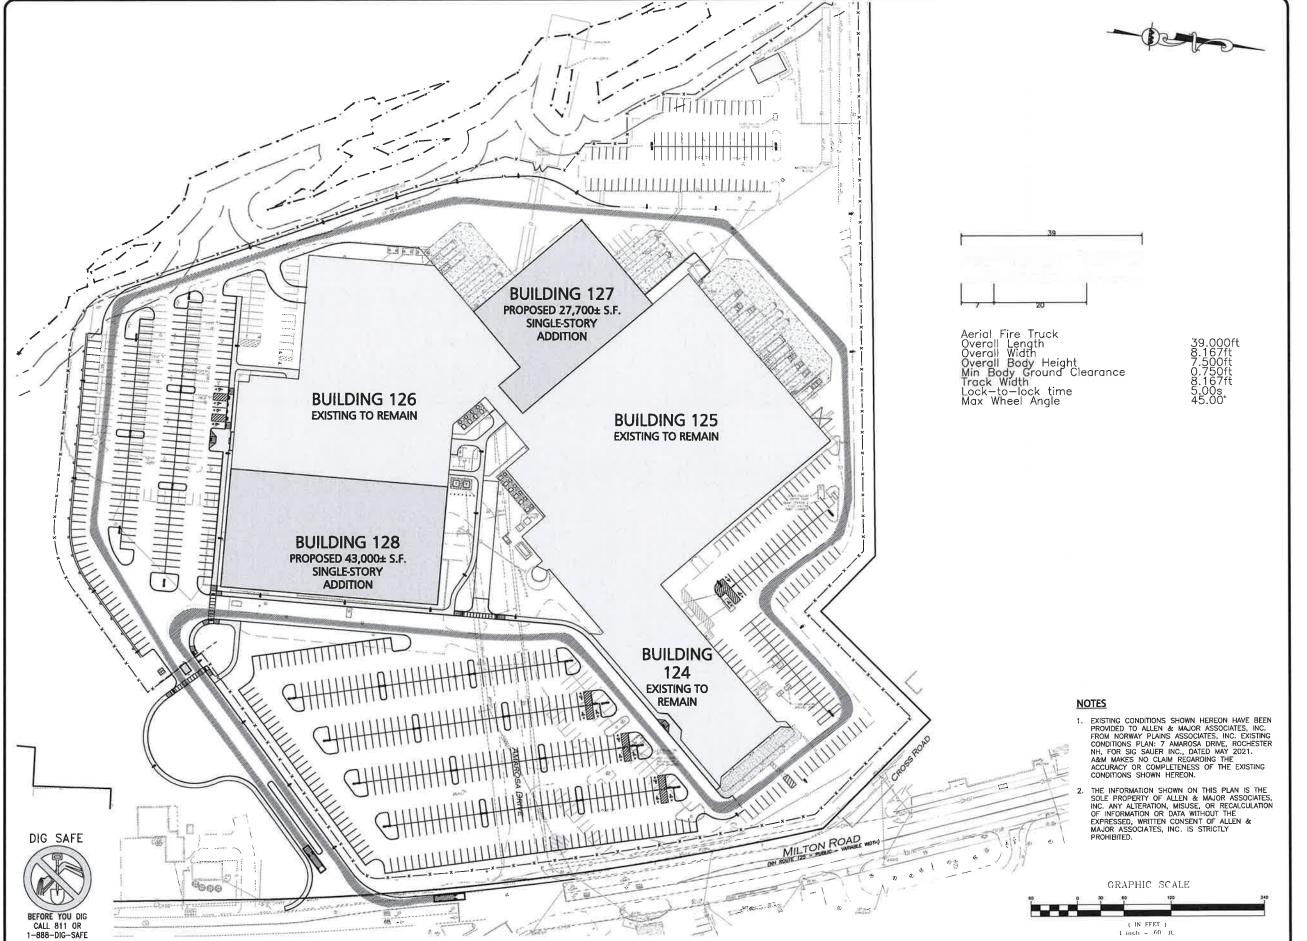


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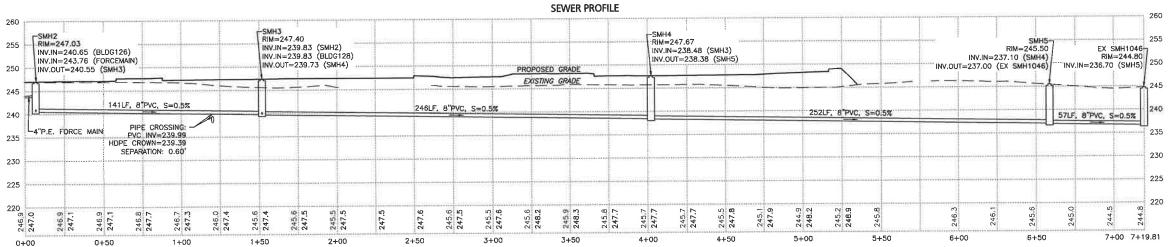
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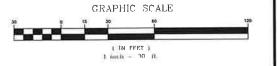
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2007	DATE	DESCRIPTION

APPLICANT

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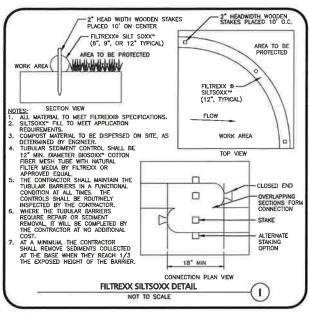
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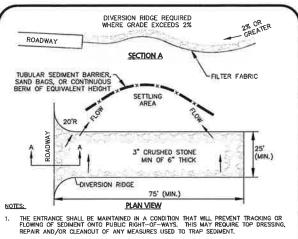
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SEWER PLAN & PROFILE

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STABILIZED CONSTRUCTION ENTRANCE


NOT TO SCALE

 \bigoplus_{Φ} -GRATE Φ^{Φ} AAA 1" REBAR FOR LIFTING AND REMOVAL -DUMP STRAP (2) -SILTSACK CATCH BASIN STRUCTURE NOTES:

1. INSTALL SILTSACK PER

1. INSTALL SILTSACK PER MANUFACTURER'S INSTRUCTIONS AND MANUFACTURER'S INSTRUCTIONS AN RECOMMENDATIONS. EMPTY OR REMOVE SEDIMENT FROM SILTSACK WHEN RESTRAINT CORD IS NO LONGER VISIBLE. CLEAN, RINSE, AND REPLACE AS NEEDED. 2. SILT SACKS TO BE INSTALLED
DURING CONSTRUCTION OPERATIONS
WHEN THE POTENTIAL FOR SEDIMENT
TO ENTER EXISTING & PROPOSED WHEN NECESSARY, WHEELS SHALL BE CLEANED PRIOR TO ENTERING THE PUBLIC RIGHT-OF-WAY. WHEN WASHING IS REQUIRED, IT SHALL BE DONE ON AN AREA STABILIZED WITH CRUSHED STONE THAT DRAINS INTO AN APPROVED SEDIMENT TRAP OR SEDIMENT BASIN. BASINS EXISTS:

(2)

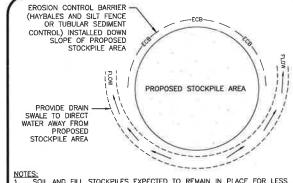

NOTES:

1. SOIL AND FILL STOCKPILES EXPECTED TO REMAIN IN PLACE FOR LESS

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1. SOIL AND MILE FOR LESS

1. S THAN 90 DAYS SHALL BE COVERED WITH HAY AND MULCH (AT 100LBS/1,000 SF), OR WITH AN ANCHORED TARP WITHIN 7 DAYS OR PRIOR TO ANY

2. SOIL AND FILL STOCKPILES EXPECTED TO REMAIN IN PLACE FOR 90 DAYS OR MORE SHALL BE SEEDED WITH WINTER RYE (FOR FALL SEEDING AT 3LB/1,000 SF) OR OATS (FOR SUMMER SEEDING AT 2LB/1,000 SF) AND THEN COVERED WITH HAY MULCH (AT 100LB/1,000 SF) OR AN ANCHORED TARP WITHIN 7 DAYS OR PRIOR TO ANY RAINFALL.

NOT TO SCALE

FABRIC SHALL BE INSTALLED VERTICALL DOWNSLOPE 1.5" 1.5 4" (MIN) STAPLE DETAILS ISOMETRIC VIEW TAMP SOIL OVER FABRIC

RIC SHALL BE NORTH AMERICAN GREEN SC150BN OR AN APPROVED ORGANIC MATERIAL

FABRIC SHALL BE NORTH AMERICAN GREEN SCI50BN OR AN APPROVED ORGANIC MATERIA EQUIAL.
SLOPE SURFACE SHALL BE FREE OF ROCKS, CLODS, STICKS AND GRASS.
APPLY PERMANENT SEEDING BEFORE PLACING FABRIC.
LAY BLANKETS LOOSELY AND STAKE OR STAPLE TO MAINTAIN DIRECT CONTACT WITH THE SOIL. DO NOT STRETCH.
THERE SHALL BE NO PLASTIC, OR MULTI-FILAMENT OR MONOPILAMENT POLYPROPYLENE NETTING OR MESH WITH AN OPENING SIZE OF GREATER THAN 1/8 INCHES MATERIAL UTILIZED.

EROSION CONTROL FABRIC (5) NOT TO SCALE


CREST LENGTH (FT) = 6 X DRAINAGE AREA (ACRES) ISOMETRIC VIEW DIKE, IF NECESSARY, TO DIVERT FLOW INTO TRAP SECTION A-A THE TRAP SHALL BE INSTALLED AS CLOSE TO THE DISTURBED AREA OR SOURCE OF SEDIMENT AS POSSIBLE.

NOT TO SCALE


(3)

- 2. THE MAXIMUM CONTRIBUTING DRAINAGE AREA TO THE TRAP SHALL BE LESS THAN 5 ACRES.
- 3. THE MINIMUM VOLUME OF THE TRAP SHALL BE 3,600 CUBIC FEET OF STORAGE FOR EACH ACRE OF DRAINAGE AREA.
- 4. THE SIDE SLOPES OF THE TRAP SHALL BE 3:1 OR FLATTER, AND SHALL BE STABILIZED IMMEDIATELY AFTER THEIR CONSTRUCTION.
- 5. THE OUTLET OF THE TRAP SHALL BE A MINIMUM OF ONE FOOT BELOW THE CREST OF THE TRAP AND SHALL DISCHARGE TO A STABILIZED AREA.
- 6. THE TRAP SHALL BE CLEANED WHEN 50% OF THE ORIGINAL VOLUME IS FILLED.
- 7. THE MATERIALS REMOVED FROM THE TRAP SHALL BE PROPERLY DISPOSED OF AN STABILIZED.

TEMPORARY EARTH OUTLET SEDIMENT TRAP (6) TACK COAT - PROVIDE EMULSIFIED ASPHALT WHICH CONFORMS TO THE REQUIREMENTS OF THE STATE SPECIFICATIONS, DILLUTED WITH ONE PART WATER TO ONE ONE PART ASPHALT FOLLOWING AASHTO M140/ASTM D997, OR AASHTO M208/ASTM D2397, SS-1H, CSS-1, OR CSS-1H. SAW CUT EDGES

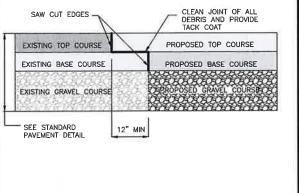

PAVEMENT KEY CUT DETAIL (7)

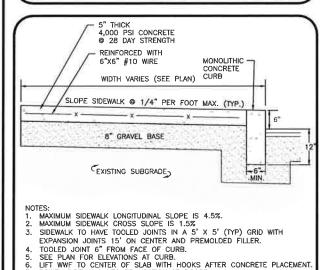

CONCRETE SIDEWALK W/ MONOLITHIC CURB

NOT TO SCALE

(8)

DOWEL SIDEWALK INTO FOUNDATION AT DOORS.

DETECTABLE WARNING PANELS TO CONTRAST VISUALLY WITH ADJOINING SURFACES, SUBMIT SHOP DRAWING AND SAMPLE FOR APPROVAL OF COLOR, SET FLUSH WITH ADJACENT CONCRETE, SEE DETECTABLE WARNING PANEL DETAIL. 7.5% MAX SLOPE 1.5% MAX 4.5% MAX -4.5% MAX SLOPE ALL DIRECTIONS 7.5% MAX 1.5% MAX SLOPE URRING PER CURBING PER -VARIES SEE WIDTH VARIES CURBING PER 7.5% MAX SEE PLAN PLANS PLAIN CEMENT SLOPE CURBING TO -4.5% MAX CONCRETE MATCH GUTTER <u>NOTES:</u> 1. THE DIMENSIONS SHOWN AT ROADWAY EDGE ARE FIXED DISTANCES. SECTION VIEW 2. RAMP CROSS SECTION TO BE THE SAME AS ADJACENT SIDEWALK; I.E. DEPTH DETECTABLE OF SURFACE AND FOUNDATION. WARNING 3. PORTLAND CEMENT CONCRETE RAMPS ARE TO BE TEXTURED BY BROOMING IN A DIRECTION PARALLEL TO THE LENGTH OF THE RAMP. SURFACE 4. IN NO CASE ARE THE RAMPS TO BE PLACED BEHIND THE STOP LINE. 5. THE DIMENSIONS ARE SUBJECT TO CHANGE IN THE FIELD IF EXISTING APPURTENANCES OR CONDITIONS WILL MAKE THE RAMP LOCATIONS IMPRACTICAL OR UNSAFE. CONSULT CIVIL ENGINEER PRIOR TO MAKING ANY - 6" CONCRETE 8" GRAVEL ADA ACCESSIBLE CURB CUT AND TRANSITION
NOT TO SCALE MODIFICATIONS (9)WAY SECTION

REV DATE DESCRIPTION

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7-8 AMAROSA DRIVE ROCHESTER, NH 03868

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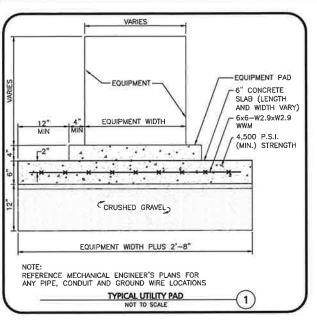
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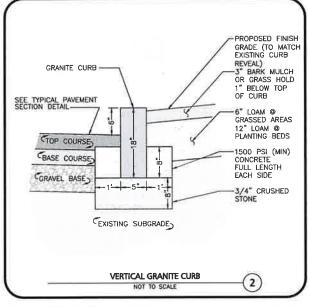
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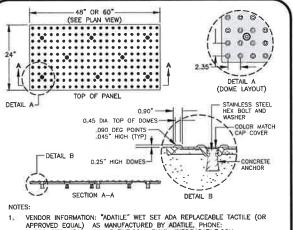
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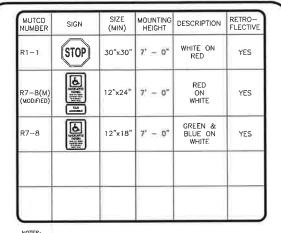






- VENDOR INFORMATION: "ADATILE" WET SET ADA REPLACEABLE TACTILE (OR APPROVED EQUAL) AS MANUFACTURED BY ADATILE, PHONE: 1-800-372-0519, WWW.ADATILE.COM, EMAIL: INFO@ADATILE.COM
- COLOR SHALL BE BLACK.
- 3. INSTALL PER MANUFACTURER'S INSTALLATION GUIDELINES.

WET SET ADA REPLACEABLE TACTILE PANEL
NOT TO SCALE (3)



NOTES:

1. TRAFFIC AND SAFETY SIGNAGE SHALL COMPLY WITH MUTCD STANDARDS,


2. WHERE APPLICABLE THE SIGN SUPPORT SHALL COMPLY WITH THE

BREAKAWAY REQUIREMENTS OF THE LATEST EDITION OF AASHTO'S


"SPECIFICATION FOR STRUCTURAL SUPPORTS FOR HIGHWAY SIGNS,


LUMINAIRIES, AND TRAFFIC SIGNALS".


SIGN TABLE (4)

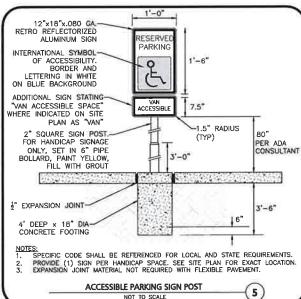



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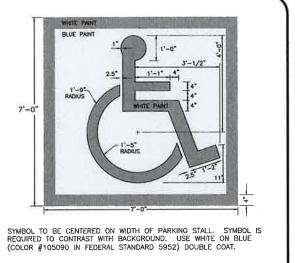


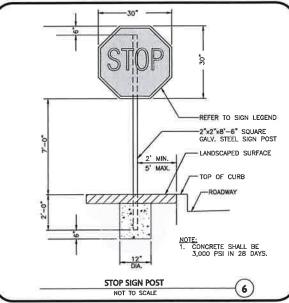

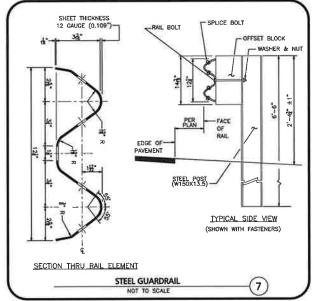

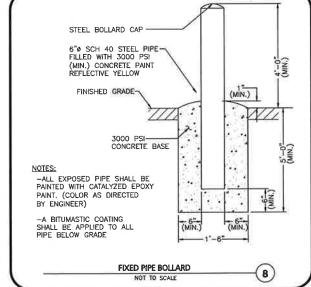


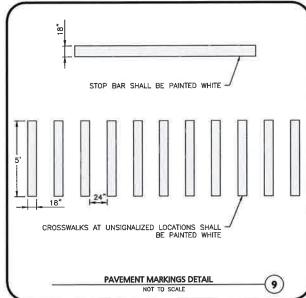

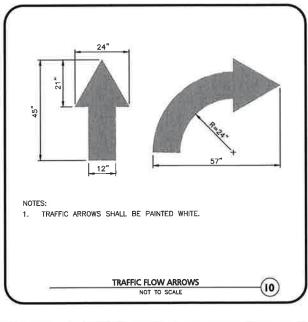

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SHEFT No. C-502

01-20-23

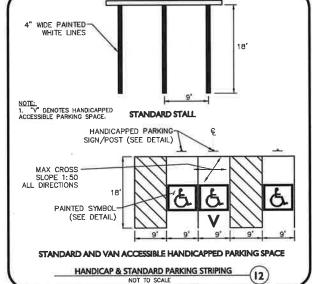	PERCENT	PASSING B	Y WEIGHT
SIEVE. SIZE	CLEAN GRANULAR FILL	BASE COURSE	SELECT GRANULAR FILL
8"	100	100	100
3"	70-100	100	70-100
ž-	40-100	40-80	40-90
No. 4	25-100	30-70	25-80
No. 10	15-95	20-60	15-70
No. 40	10-70	10-30	5-40
No. 200	0-15	3-10	0-12

A SEWER MAIN AND A WATER/DRAIN MAIN:

THE CROSSING.

DIFFERENCE IN ELEVATION BETWEEN THE WATER/DRAIN MAIN AND THE SEWER MAIN SHALL BE AT LEAST 18 INCHES.


3. THE PIPE JOINTS SHALL BE STAGGERED TO PROVIDE THE MAXIMUM

6. WHEN ONE UTILITY IS A SANITARY SEWER. IT IS PREFERABLE TO BE POSITIONED AS SHOWN FOR UTILITY B.


8. PIPE MUST BE BRACED VERTICALLY AND HORIZONTALLY TO PREVENT


5. UTILITIES A AND B CAN BE EITHER NEW OR EXISTING.


FLOATATION DURING PLACEMENT OF CONCRETE.

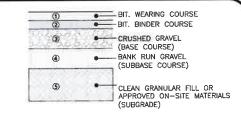



- IF A GEOTECHNICAL REPORT IS PREPARED THE RECOMMENDATIONS WITHIN THAT REPORT SHALL SUPERCEDE RECOMMENDATIONS HEREIN. THE CONTRACTOR SHALL HAVE AND REVIEW A COPY OF THE GEOTECHNICAL REPORT AND COMPLY WITH THE PERCOMMENDATIONS THEOPEN.
- 2. TOPSOIL SHALL BE REMOVED BENEATH ALL PAVEMENT AREAS TO EXPOSE THE TURALLY-OCCURRING SOILS OR ACCEPTABLE ON-SITE FILL MATERIALS.
- THE SUBGRADE SHOULD BE PROOFROLLED UNDER THE SUPERVISION OF A GEOTECHNICAL ENGINEER USING AT LEAST 4 PASSES OF A 10-TON VIBRATORY ROLLER. AREAS OF THE SUBGRADE THAT "WEAVE" OR "ROLL" EXCESSIVELY SHOULD BE 3. OVEREXCAVATED AND REPLACED WITH DRIER CLEAN GRANULAR FILL MATERIAL.
- 4. THE PAVEMENT SUBGRADE CONSISTING OF THE SPECIFIED CLEAN GRANULAR FILL SHALL BE PLACED IN 12" MAXIMUM LIFTS AND COMPACTED TO A DRY DENSITY OF AT LEAST 95 PERCENT OF THE MATERIALS MAXIMUM DRY DENSITY AS DETERMINED BY ASTM DESIGNATION D-1557.

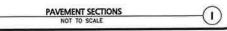


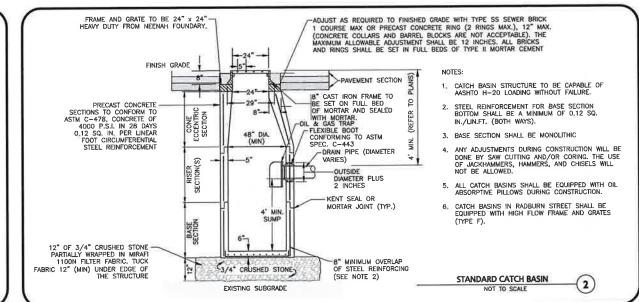


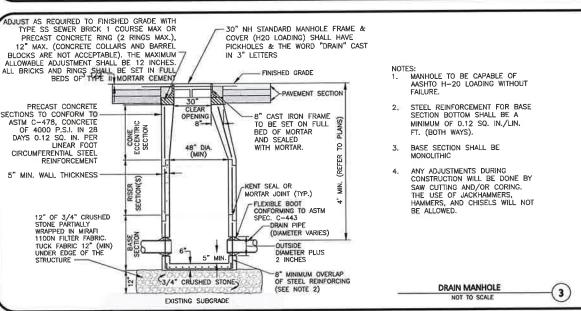

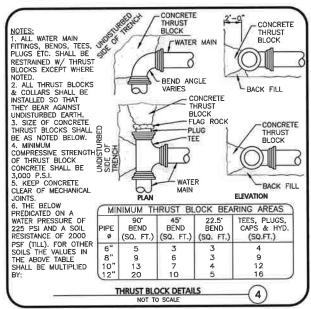

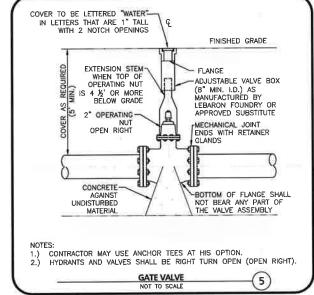

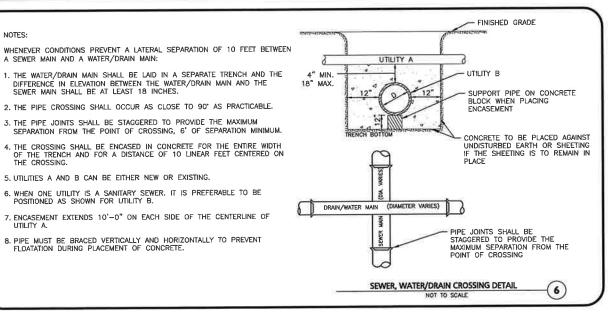

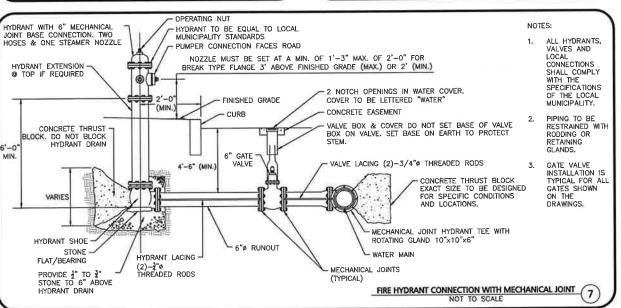



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DETAILS

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SEWER MANHOLE

STANDARD FCCENTRIC PRECAST CONCRETE 5' MIN. COVER REINFORCED CONCRETE PRECAST MANHOLE SECTION PER ASTM C-478 USE "INSIDE -DROP BOWL" BY RELINER 1" X 1 1" STAINLESS STEEL STRAP W/SS (12" O.C. TYP.) REINFORCED CONCRETE MANHOLE SECTION PER ASTM C-478 SDR-35 BRICK INVERT 12" MIN CRUSHED STONE OILS.


1. MANHOLE STRUCTURE TO BE CAPABLE OF SUPPORTING AASHTO H-20
2. SEE ALSO SEWER MANHOLE STANDARD DETAIL. **DROP SEWER MANHOLE**


MIN. TRENCH WIDTH O.D. +2 FT (3 FT MIN)-18" TO 36" BELOW FINISH GRAD FINISHED GRADE PAVEMENT SECTION OR LOAM -AND SEED (SEE DETAILS) 12" MIN-COMPACTED, 8" MAX LIFTS 2" THICK RIGID POLYSTYRENE INSULATION WHERE SHOWN ON PLANS FOR REDUCED COVER (EXCEPT FOR WHE INSULATION IS SHOWN) SAND COMPACTED IN 8" LIFTS-SDR 35 Y CRUSHED STONE -LEDGE COMPACTED IN B" LIFTS (MAINTAIN 12" CLEAR) UNDISTURBED NATIVE MATERIAL MIN (12" IN LEDGE)

. WHERE BACKFILL IS DESIGNATED AS COMPACTED, THIS MEANS 90 TO 95% STANDARD PROCTOR. ASSHID T-99, ALL FILL PLACED BELOW PIPES AND STRUCTURES MUST MEET THIS REQUIREMENT.

CRUSHED STONE SHALL BE CLEAN, HARD, FREE FROM COATINGS AND THOROUGHLY WASHED WITH A GRADATION BY WEIGHT OF 100% PASSING A 1" SQUARE OPENING, AND 0 TO 5% PASSING A | SQUARE OPENING

SEWER TRENCH DETAIL

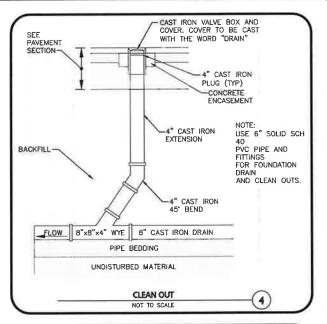

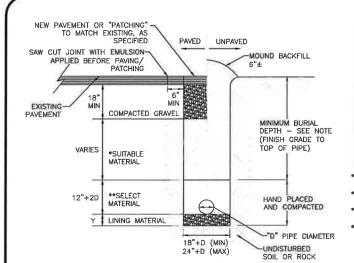



1. MINIMUM BURIAL DEPTH MINIMUM BURIAL DEPTH (FINISH GRADE TO TOP OF PIPE)
GRAVITY PIPE — SEE PLAN OR PROFILE PRESSURE PIPE BENEATH UNPAVED - 3

WHERE BACKFILL IS DESIGNATED AS COMPACTED, THIS MEANS 90 TO 95% STANDARD PROCTOR. AASHTO T-99. ALL FILL PLACED BELOW PIPES AND STRUCTURES MUST MEET THIS REQUIREMENT.

3. FOR ALL TRENCHES WITH A GRADE GREATER THAN 4% AND/OR WHERE GROUNDWATER IS APPARENT, INSTALL CLAY DAMS AROUND THE PIPE AT 100' INTERVALS.

4. BACKFILL AS PER DCED-R100 AND REFERENCED AS STANDARD


* SUITABLE MATERIAL SHALL CONTAIN NO STONE GREATER THAN 4" IN DIAMETER, NO FROZEN LUMPS, AND ONLY MINOR AMOUNTS OF

CLAY OR ORGANIC MATERIAL. ALL MATERIAL TO BE PLACED IN MAX 6" LIFTS AND COMPACTED BEFORE PLACING NEXT LIFT.

*TYPE I MATERIAL SHALL BE EITHER GRAVEL OR EXCAVATED MATERIAL CONTAINING NO STONES GREATER THAN 1.5" DIAMETER, NO FROZEN LUMPS, CLAY OR ORGANIC MATERIAL. **<u>TYPE II MATERIAL</u> SHALL BE CLEAN, HARD, CRUSHED OR NATURAL STONE WITH A GRADATION BY WEIGHT OF 100% PASSING A 1.5" SQUARE OPENING, NOT MORE THAN 25% PASSING A \$\frac{3}{2}\text{" OPENING, AND NOT MORE THAN 5% PASSING A \$\frac{1}{2}\text{" SQUARE OPENING.} \\
**TYPE ||| MATERIAL SHALL BE CLEAN, HARD, CRUSHED STONE FREE FROM COATINGS AND THOROUGHLY WASHED WITH A GRADATION BY WEIGHT OF 100% PASSING A 1" SQUARE OPENING, AND 0 TO 5% PASSING A \$\frac{1}{4}\text{" SQUARE OPENING.} \\

**TYPE || MATERIAL SHALL BE CLEAN, HARD, CRUSHED STONE FREE FROM COATINGS AND THOROUGHLY WASHED WITH A GRADATION BY WEIGHT OF 100% PASSING A 1" SQUARE OPENING.

> TRENCH DETAIL (5)

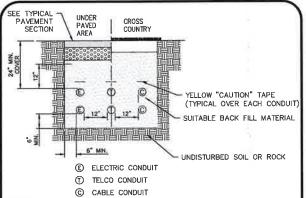


NOTES: SCHEDULE 80 PVC CONDUIT REQUIRED UNDER ROAD AND DRIVEWAY SURFACES.

2. ALL UTILITY INSTALLATION REQUIREMENTS, SEPARATIONS, AND CONDUIT SIZES TO BE VERIFIED WITH EACH UTILITY COMPANY PRIOR TO INSTALLATION OF ANY UNDERGROUND UTILITY CONDUIT.

3. SEE SITE ELECTRICAL PLAN FOR SPECIFIC DETAILS

BURIED CONDUIT DETAIL (6) NOT TO SCALE


PROPOSED PVC DRAIN 10'-0" (MIN.) @ # PER FOOT MIN. RAIN PER Lebaron Cast Iron PVC PLUG MAY DRAIN CLEANOUT RING COVER. COVER TO BE CAST WITH THE WORK SUBSTITUTED II LANDSCAPING AREAS II "DRAIN" AND HAVE FLAT APPROVED BY DIAMOND SURFACE. ENGINEER PROPOSED GRADE FLEXIBLE JOINT (FERNCO CLEANOUT RISER STACK BE STAINLESS STEEL. PIPE PER MASS. BLDG. & PLUMBING CODE (PIPE MAY PENETRATE FOUNDATION WALL OF CONNECT TO EXTERIOR 6" PVC 45" DOWN SPOUT BEND 3/4" CRUSHED -FLOW \$ 6"x6"x6"WYE -SDR-35 PVC G/4" CRUSHED (7)

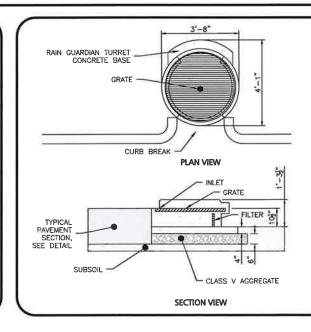


NOTES:

- STEEL REINFORCED, COLD JOINT SECURED MONOLITHIC CONCRETE STRUCTURE (1,030 LBS).
- CONCRETE SHALL HAVE A MINIMUM COMPRESSIVE STRENGTH OF 4,000 PSI AT 28 DAYS. CONCRETE AIR ENTRAINED (4% TO 8% BY VOLUME).
- 3. MANUFACTURED AND DESIGNED TO ASTM C858.
- 4. THREE-POINT PICK USING RECESSED LIFTING POCKETS WITH A STANDARD
- 5. SOIL UNDER BASE TO BE COMPACTED TO 95% STANDARD PROCTOR.
- 6. TWO-PIECE LIGHT DUTY GALVANIZED GRATE (34.5 LBS/PIECE) FOR 541 LB CONCENTRATED LOAD OR 309 LB/SQ FT UNIFORM LOAD
- 7. TWO-PIECE HEAVY DUTY GALVANIZED GRATE (77.5 LBS/PIECE) FOR 2.456 LB CONCENTRATED LOAD OR 1,404 LB/SQ FT UNIFORM LOAD.
- 8. USE EXPANSION JOINT MATERIAL BETWEEN TURRET AND BIORETENTION INLET.

RAIN GUARDIAN - TURRET TYPICAL DETAIL NOT TO SCALE

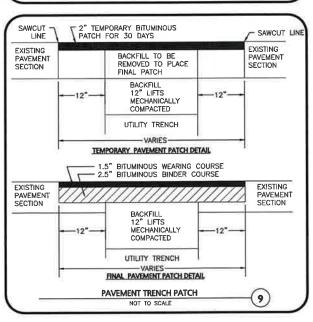

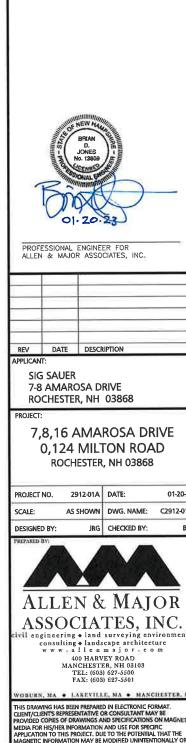


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C2912-01/

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DETAILS

DRAWING TITLE:




SLIDE GATE DETAIL

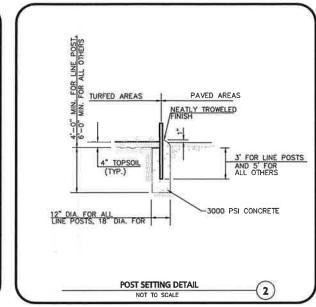NOT TO SCALE


(5)


BIORE	TENTION ELEVATION				
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Α	244.00				
В	243.50				
С	243,25				
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E	241.50				


BIO	RETENTION FILTER MEDIA			
	PERCENT OF MIXTURE	GRADATION OF MATERIAL		
COMPONENT MATERIAL	BY VOLUME	SIEVE NO.	PERCENT BY WEIGHT PASSING STANDARD SIEVE	
F	ILTER MEDIA OPTION A			
ASTM C-22 CONCRETE SAND	50 TO 55	I		
LOAMY SAND TOPSOIL, WITH FINES AS INDICATED	20 TO 30	200	15 TO 25	
MODERATELY FINE SHREDDED BARK OR WOOD FIBER MULCH, WITH FINES AS INDICATED	20 TO 30	200	<5	
F	ILTER MEDIA OPTION B			
MODERATELY FINE SHREDDED BARK OR WOOD FIBER MULCH, WITH FINES AS INDICATED	20 TO 30	200	<5	
		10	85 TO 100	
LOUIN COARCE CAND	70 TO 80	20	70 TO 100	
LOAMY COARSE SAND		60	15 TO 40	
		200	8 TO 15	

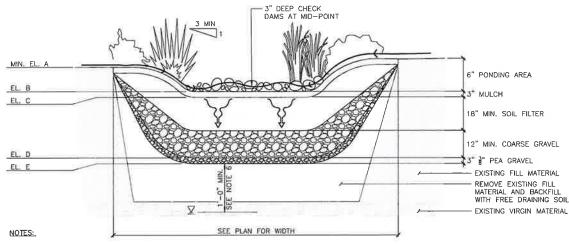

- 1. SEE LANDSCAPE PLAN FOR PLANT TYPES.
- 2. GRADING, AND PLANTING OF BIORETENTION SHALL BE COMPLETED IN EARLY PHASES OF CONSTRUCTION. PLANTS AND SEED ON SLOPES AND BOTTOM OF BASIN MUST BE ESTABLISHED PRIOR TO CONNECTING STORM DRAINAGE SYSTEM OUTLETS TO BIORETENTION AREA. PLANTS AND SEED MIX SHALL HAVE A MINIMUM OF 6 MONTHS GROWING, BE ESTABLISHED AND APPROVED BY LANDSCAPE ARCHITECT PRIOR TO CONNECTING STORM DRAINAGE SYSTEM OUTLETS
- 3. EROSION CONTROL MEASURES AS SHOWN ON THE EROSION CONTROL PLAN, SHALL BE IN PLACE PRIOR TO ANY REGRADING ACTIVITY.
- EXCAVATION, FILLING AND PLANTING SHALL OCCUR IN THE DRY. WATER LEVELS MUST BE LOWERED IN THE BIORETENTION AREA BY RELYING ON DRY SEASON AND OR DRY SPELLS; OR MAY BE ACCOMPLISHED THROUGH THE USE OF DEWATERING METHODS. CONTRACTOR SHALL SUBMIT SHOP DRAWINGS OF ANY DEWATERING METHODS FOR REVIEW AND APPROVAL PRIOR TO CONSTRUCTION.
- WATER FROM ANY DEWATERING OPERATION SHALL BE TREATED TO REDUCE TOTAL SUSPENDED SOLIDS AND BE IN COMPLIANCE WITH STATE AND FEDERAL
- 6. A MINIMUM OF 1 FOOT SEPARATION BETWEEN THE BOTTOM OF THE PRACTICE AND SEASONAL HIGH WATER TABLE SHALL BE PROVIDED, VERIFY IN FIELD. IF SEPARATION CAN NOT BE ACHIEVED, SET UNDERDRAIN AT BOTTOM OF COARSE GRAVEL LAYER, OMIT PEA GRAVEL LAYER, AND PROVIDE IMPERMEABLE LINER AT BOTTOM OF PRACTICE.

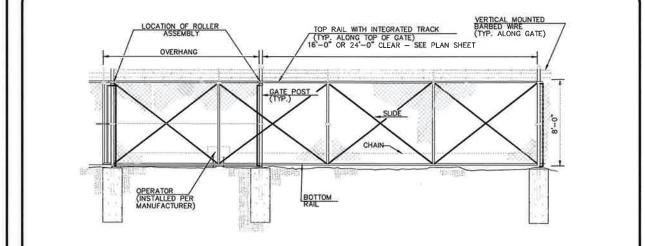

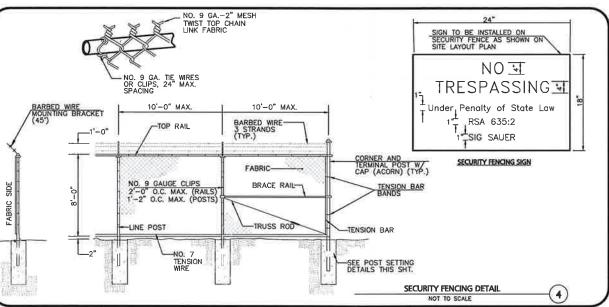

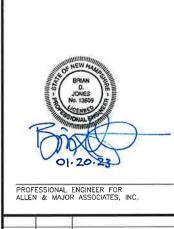

REV DATE DESCRIPTION

SIG SAUER 7-8 AMAROSA DRIVE ROCHESTER, NH 03868

7,8,16 AMAROSA DRIVE 0.124 MILTON ROAD ROCHESTER, NH 03868

PROJECT NO.	2912-01A	DATE:	01-20-23
SCALE:	AS SHOWN	DWG. NAME:	C2912-01A
DESIGNED BY:	JRG	CHECKED BY:	BDJ



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DETAILS

C-505

BIORETENTION SYSTEM DETAIL.

ACCEPTABLE FILL MATERIALS: STORMTECH SC-310 CHAMBER SYSTEMS

	MATERIAL LOCATION	DESCRIPTION	AASHTO MATERIAL CLASSIFICATIONS	COMPACTION / DENSITY REQUIREMENT
D	FINAL FILL: FILL MATERIAL FOR LAYER "D" STARTS FROM THE TOP OF THE "C" LAYER TO THE BOTTOM OF FLEXIBLE PAVEMENT OR UNPAVED FINISHED GRADE ABOVE, NOTE THAT PAVEMENT SUBBASE MAY BE PART OF THE "D" AYER.	ANY SOIL/ROCK MATERIALS, NATIVE SOILS, OR PER ENGINEER'S PLANS, CHECK PLANS FOR PAVEMENT SUBGRADE REQUIREMENTS,	N/A	PREPARE PER SITE DESIGN ENGINEER'S PLANS. PAVED INSTALLATIONS MAY HAVE STRINGENT MATERIAL AND PREPARATION REQUIREMENTS.
С	INITIAL FILL: FILL MATERIAL FOR LAYER 'C' STARTS FROM THE TOP OF THE EMBEDMENT STONE ('B' LAYER) TO 18" (450 mm) ABOVE THE TOP OF THE CHAMBER, NOTE THAT PAVEMENT SUBBASE MAY BE A PART OF THE 'C' LAYER.	GRANULAR WELL—GRADED SOIL/AGGREGATE MIXTURES, <35% FINES OR PROCESSED AGGREGATE, MOST PAVEMENT SUBBASE MATERIALS CAN BE USED IN LIEU OF THIS LAYER.	AASHTO M145¹ A-1, A-2-4, A-3 OR AASHTO M43¹ 3, 357, 4, 467, 5, 56, 57, 6, 67, 68, 7, 78, 8, 89, 9, 10	BEĞİN COMPACTIONS AFTER 12" (300 mm) OF MATERIAL OVER THE CHAMBERS IN REACHED. COMPACT ADDITIONAL LAYERS IN 6" (150 mm) MAX LIFTS TO A MIN. 95% PROCTOR DENSITY FOR WELL GRADEL MATERIAL AND 95% RELATIVE DENSITY FOR PROCESSED AGGREGATE MATERIALS, POLLER GROSS VEHICLE WEIGHT NOT TO EXCEED 12,000 lbs (53 kN). DYNAMIC FORCE NOT TO EXCEED 20,000 lbs (89 kN).
В	EMBEDMENT STONE: FILL SURROUNDING THE CHAMBERS FROM THE FOUNDATION STONE ('A' LAYER) TO THE 'C' LAYER ABOVE.	CLEAN, CRUSHED, ANGULAR STONE	AASHTO M43 ¹ 3, 357, 4, 467, 5, 56, 57	NO COMPACTION REQUIRED,
A	FOUNDATION STONE: FILL BELOW CHAMBERS FROM THE SUBGRADE UP TO THE FOOT (BOTTOM) OF THE CHAMBER.	CLEAN, CRUSHED, ANGULAR STONE	AASHTO M43¹ 3, 357, 4, 467, 5, 56, 57	PLATE COMPACT OR ROLL TO ACHIEVE A FLAT SURFACE, 2,3

- PLEASE NOTE:


 1. THE USTED AASHTO DESIGNATIONS ARE FOR GRADATIONS ONLY, THE STONE MUST ALSO BE CLEAN, CRUSHED, ANGULAR, FOR EXAMPLE, A SPECIFICATION FOR #4 STONE WOULD STATE: "CLEAN, CRUSHED, ANGULAR NO. 4 (AASHTO MA3) STONE".

 2. STORMITCH COMPACTION REQUIREMENTS ARE MET FOR "A' LOCATION MATERIALS WHEN PLACED AND COMPACTED IN 6" (150 mm) (MAX) LIFTS USING TWO FULL COVERAGES WITH A VIBRATORY COMPACTOR.

 3. WHERE INFLITRATION SURFACES MAY BE COMPROMISED BY COMPACTION, FOR STANDARD DESIGN LOAD CONDITIONS, A FLAT SURFACE MAY BE ACHIEVED BY RAKING OR DRAGGING WITHOUT COMPACTION EQUIPMENT, FOR SPECIAL LOAD DESIGNS, CONTACT STORMITCH FOR COMPACTION REQUIREMENTS.


 DESIGNS, CONTACT STORMITCH FOR COMPACTION REQUIREMENTS.

 DESIGNS, CONTACT STORMITCH FOR COMPACTION REQUIREMENTS.
- DESIGNS, CONTACT STORMITECH FOR COMPACTION REQUIREMENTS,
 ONCE LAYER 'C' IS PLACED, ANY SOIL/MATERIAL CAN BE PLACED IN LAYER 'D' UP TO THE FINISHED GRADE, MOST PAVEMENT SUBBASE SOILS CAN BE USED TO REPLACE THE MATERIAL REQUIREMENTS OF LAYER 'C' OR 'D' AT THE SITE DESIGN ENGINEER'S DISCRETION.

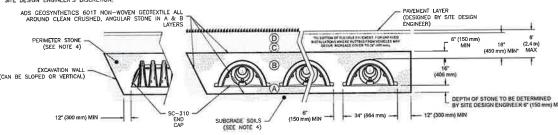



NOTES:

- CHAMBERS SHALL MEET THE REQUIREMENTS OF ASTM F2922 (POLETHYLENE) OR ASTM F2418 (POLYPROPYLENE), "STANDARD SPECIFICATION FOR CORRUGATED WALL STORMWATER COLLECTION CHAMBERS",
- 2. SC-310 CHAMBERS SHALL BE DESIGNED IN ACCORDANCE WITH ASTM F2787 "STANDARD PRACTICE FOR STRUCTURAL DESIGN OF THERMOPLASTIC CORRUGATED WALL
- THE SITE DESIGN ENGINEER IS RESPONSIBLE FOR ASSESSING THE BEARING RESISTANCE (ALLOWABLE BEARING CAPACITY) OF THE SUBGRADE SOILS AND THE DEPTH OF
- FOUNDATION STONE WITH CONSIDERATION FOR THE RANGE OF EXPECTED SOIL MOISTURE CONDITIONS,
 PERIMETER STONE MUST BE EXTENDED HORIZONTALLY TO THE EXCAVATION WALL FOR BOTH VERTICAL AND SLOPED EXCAVATION WALLS,
 REQUIREMENTS FOR HANDLING AND INSTALLATION:
- TO MAINTAIN THE WIDTH OF CHAMBERS DURING SHIPPING AND HANDLING, CHAMBERS SHALL HAVE INTEGRAL, INTERLOCKING STACKING LUGS.
- TO ENSURE THE INTEGRITY OF THE ARCH SHAPE DURING INSTALLATION, O THE ARCH STIFFNESS CONSTANT AS DEFINED IN SECTION 6.2.8 OF ASTM F2922 SHALL BE GREATER THAN OR EQUAL TO 400 LBS/FT/%, AND b) TO RESIST CHAMBER DEFORMATION DURING INSTALLATION AT ELEVATED TEMPERATURES (ABOVE 73' F / 23' C). CHAMBERS SHALL BE PRODUCED FROM REFLECTIVE GOLD OR YELLOW COLORS.

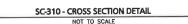

NOT TO SCALE

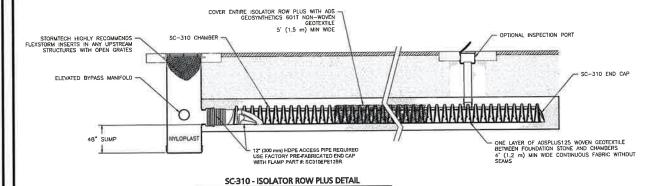

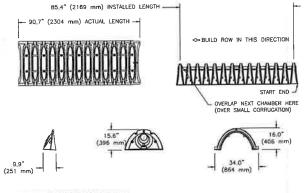

NOMINAL CHAMBER SPECIFICATIONS SIZE (W X H X INSTALLED LENGTH)

34.0" X 16.0" X 85.4" (864 mm X 406 mm X 2169

CHAMBER STORAGE
MINIMUM INSTALLED STORAGE*

14.7 CUBIC FEET 31,0 CUBIC FEET (16.8 kg)

*ASSUMES 6" (152 mm) ABOVE, BELOW, AND BETWEEN CHAMBERS





1 1

PRE-FAB STUB AT BOTTOM OF END CAP WITH FLAMP END WITH "BR" PRE-FAB STUBS AT BOTTOM OF END CAP FOR PART MUMBERS ENDING WITH "B" PRE-FAB STUBS AT TOP OF END CAP FOR PART NUMBERS ENDING WITH "T" PRE CORED END CAPS END WITH "PC"

PART#	STUB	A	В	С
SC310EPE06T / SC310EPE06TPC	6" (150	(150 9.6" (244	5.8" (147 mm)	277
SC310EPE06B / SC310EPE06BPC	mm)	mm)		0,5" (13 mm)
SC310EPE08T / SC310EPE08TPC	8" (200	8" (200 11.9" (302		***
SC310EPE08B / SC310EPE08BPC	mm)	mm)	222	0,6" (15 mm)
SC310EPE10T / SC310EPE10TPC	10" (250	12.7" (323	1.4" (36 mm)	34.44
SC310EPE10B / SC310EPE10BPC	mm)	mm)	-	0.7" (18 mm)
SC310EPE12B	12" (300 mm)	13.5" (343 mm)		0,9" (23 mm)
SC310EPE12BR	12* (300 mm)	13,5" (343 mm)		0,9" (23 mm)

ALL STUBS, EXCEPT FOR THE SC310EPE12B ARE PLACED AT BOTTOM OF END CAP SUCH THAT THE OUTSIDE DIAMETER OF THE STUB IS FLUSH WITH THE BOTTOM OF THE END CAP. FOR ADDITIONAL INFORMATION CONTACT STORMIECH AT 1-888-892-2654.

* FOR THE SC310EPE12B THE 12* (300 mm) STUB LIES BELOW THE BOTTOM OF THE END CAP APPROXIMATELY 0.25* (6 mm). BACKFILL MATERIAL SHOULD BE REMOVED FROM BELOW THE N-12 STUB SO THAT THE FITTING SITS LEVEL.

NOTE: ALL DIMENSIONS ARE NOMINAL

TECHNICAL SPECIFICATIONS NOT TO SCALE

SC-310 STORMTECH CHAMBER SPECIFICATIONS

CHAMBERS SHALL BE STORMTECH SC-310,

INSPECTION PORTS MAY BE CONNECTED THROUGH ANY CHAMBER CORRUGATION CREST,

4" PVC INSPECTION PORT

- 12" (300 mm) MIN WIDTH

CONCRETE COLLAR

CONCRETE SLAB 6" (150 mm) MIN THICKNESS

PAVEMENT

CONCRETE COLLAR NOT REQUIRED FOR UNPAVED APPLICATIONS

BODY (PART# 2708AG4|PKIT) OR TRAFFIC RATED BOX W/SOLID LOCKING COVER

4" (100 mm) SDR 35 PIPE

- 2. CHAMBERS SHALL BE ARCH-SHAPED AND SHALL BE MANUFACTURED FROM VIRGIN, IMPACT-MODIFIED POLYPROPYLENE OR POLYETHYLENE COPOLYMERS
- MBERS SHALL MEET THE REQUIREMENTS OF ASTM F2922 (POLETHYLENE) OR ASTM F2418 (POLYPROPYLENE), "STANDARD SPECIFICATION FOR CORRUGATED WALL STORMWATER
- 4. CHAMBER ROWS SHALL PROVIDE CONTINUOUS, UNOBSTRUCTED INTERNAL SPACE WITH NO INTERNAL SUPPORTS THAT WOULD IMPEDE FLOW OR LIMIT ACCESS FOR INSPECTION,
- THE STRUCTURAL DESIGN OF THE CHAMBERS, THE STRUCTURAL BACKFILL, AND THE INSTALLATION REQUIREMENTS SHALL ENSURE THAT THE LOAD FACTORS SPECIFIED IN THE ASHTO LEFD BRIDGE DESIGN SPECIFICATIONS, SECTION 12.12, ARE MET FOR: 1) LONG-DURATION DEAD LOADS AND 2) SHORT-DURATION LIVE LOADS, BASED ON THE AASHTO DESIGN TRUCK WITH CONSIDERATION FOR IMPACT AND MULTIPLE VEHICLE PRESENCES.
- 6. CHAMBERS SHALL BE DESIGNED, TESTED AND ALLOWABLE LOAD CONFIGURATIONS DETERMINED IN ACCORDANCE WITH ASTM F2787, "STANDARD PRACTICE FOR STRUCTURAL DESIGN OF THERMOPLASTIC CORRUGATED WALL STORMWATER COLLECTION CHAMBERS", LOAD CONFIGURATIONS SHALL INCLUDE: 1) INSTANTANEOUS (<1 MIN) AASHTO DESIGN TRUCK LIVE LOAD ON MINIMUM COVER 2) MAXIMUM PERMANENT (75-YR) COVER LOAD AND 3) ALLOWABLE COVER WITH PARKED (1-WEEK) AASHTO DESIGN TRUCK.

- REQUIREMENTS FOR HANDLING AND INSTALLATION:

 TO MAINTAIN THE WIDTH OF CHAMBERS DURING SHIPPING AND HANDLING, CHAMBERS SHALL HAVE INTEGRAL, INTERLOCKING STACKING LUGS.

 TO ENSURE A SEQUER JOINT DURING INSTALLATION AND BACKFILL, THE HEIGHT OF THE CHAMBER JOINT SHALL NOT BE LESS THAN 2".

 TO ENSURE THE INTEGRITY OF THE ARCH SHAPE DURING INSTALLATION, a) THE ARCH STIFFNESS CONSTANT SHALL BE GREATER THAN OR EQUAL TO 400 LBS/FT/%. THE ASC, IS DEFINED IN SECTION 5.2.8 OF ASTIM F24.8, AND b) TO RESIST CHAMBER DEFORMATION DURING INSTALLATION AT ELEVATED TEMPERATURES (ABOVE 73" F / 23" C), CHAMBER'S SHALL BE PRODUCED FROM REFLECTIVE GOLD OR YELLOW COLORS.

- ONLY CHAMBERS THAT ARE APPROVED BY THE SITE DESIGN ENGINEER WILL BE ALLOWED. UPON REQUEST BY THE SITE DESIGN ENGINEER OR OWNER, THE CHAMBER MANUFACTURER SHALL SUBMIT A STRUCTURAL EVALUATION FOR APPROVAL BEFORE DELIVERING CHAMBERS TO THE PROJECT SITE AS FOLLOWS:

 THE STRUCTURAL EVALUATION SHALL BE SEALED BY A REGISTERED PROFESSIONAL ENGINEER.

 THE STRUCTURAL EVALUATION SHALL DEMONSTRATE THAT THE APPEAR AFETY FACTORS ARE GREATER THAN OR EQUAL TO 1:95 FOR DEAD LOAD AND 1:75 FOR LIVE LOAD, THE MINIMUM REQUIRED BY ASTM F2787 AND BY SECTIONS 3 AND 12:12 OF THE AASHTO LIFT BRIDGE DESIGN SPECIFICATIONS FOR THERMOPLASTIC PIPE.

 THE TEST DERIVED CREEP MODULUS AS SPECIFIED IN ASTM F2922 SHALL BE USED FOR PERMANENT DEAD LOAD DESIGN EXCEPT THAT IT SHALL BE THE 75—YEAR MODULUS USED FOR DESIGN.
- 9. CHAMBERS AND END CAPS SHALL BE PRODUCED AT AN ISO 9001 CERTIFIED MANUFACTURING FACILITY.



STORMTECH SC-310 CHAMBER SYSTEM NOT TO SCALE



PROFESSIONAL ENGINEER FO ALLEN & MAJOR ASSOCIATES, INC.

			_
			-
REV	DATE	DESCRIPTION	

APPLICANT

SIG SAUER 7-8 AMAROSA DRIVE ROCHESTER, NH 03868

7,8,16 AMAROSA DRIVE 0,124 MILTON ROAD ROCHESTER, NH 03868

Р	ROJECT NO.	2912-01A	DATE:	01-20-23
s	CALE:	AS SHOWN	DWG. NAME:	C2912-01A
1	ESIGNED BY:	JRG	CHECKED BY:	BDJ



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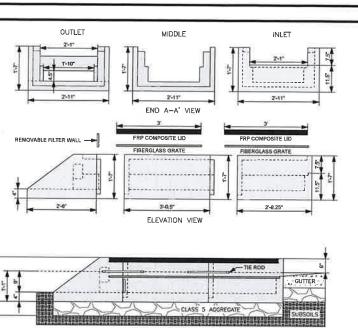
DRAWING TITLE:

DETAILS

C-506

OUTLET

2'-1"



INSTALLED ELEVATION VIEW - INLET/OUTLET ONLY

STELLIFICATIONS:

1, STEEL REINFORCED, COLD JOINT SECURED MONOLITHIC CONCRETE STRUCTURES (INLET 875 LBS, MIDDLE 965 LBS, AND OUTLET 730 LBS). CONCRETE SHALL HAVE A MINIMUM COMPRESSIVE STRENGTH OF 4,500 PSI AT 28 DAYS, CONCRETE AIR ENTRAINED (5% TO 8.5% BY VOLUME). MANUFACTURED AND DESIGNED TO ASTM C858.

2. 2-POINT PICK USING RECESSED LIFTING POCKETS WITH A STANDARD HOOK,

3. FIBERGLASS GRATE (11 LBS/PIECE).

- 4. FRP COMPOSITE LID (38 LBS/PIECE) WITH CONCENTRATED LOAD CAPACITY OF 11,200 LBS.

INSTALLATION NOTES:


INSTALLATION NOTES:

1. INSTALL A CLASS 5 BASE (COMPACTED TO 95% STANDARD PROCTOR). IT IS CRITICAL THAT THE CLASS 5 BASE IS EVEN TO ENSURE THE FOXHOLE PIECES ALIGN VERTICALLY SUCH THAT THE TOP LIDS LAY FLUSH WITH THE TOP OF THE FOXHOLE PIECES AND ADJACENT BOULEVARD, SIDEWALK, OR PATH, THE DISTANCE FROM THE BACK OF THE CURB MAY VARY BASED ON SITE CONDITIONS, EXCAVATE 1'7" BELOW THE GUTTERLINE ELEVATION (LE. THE BIORETENTION OVERFLOW ELEVATION) TO ACCOMMODATE THE 9" PONDING DEPTH, 6" CLASS 5 AGGREGATE, AND 4" RAIN GUARDIAN FOXHOLE BASE (INCLUDED), THEREFORE, THE TOP OF THE CLASS 5 COMPACTED BASE IS PRECISELY 1' DELOW THE GUTTERLINE ELEVATION. THE TOP OF THE RAIN GUARDIAN FOXHOLE INLET POINT WILL BE 7-1/2" ABOVE THE TOP OF THE CONCRETE BASE AND 1-1/2 BELOW THE GUTTERLINE ELEVATION TO ACCOMMODATE A SLOPED INLET FROM THE GUTTER TO THE RAIN

2. SET RAIN GUARDIAN FOXHOLE INLET FIRST, FOLLOWED BY MIDDLE SECTION(S), AND FINALLY THE OUTLET ON THE PREPARED CLASS 5 BASE, POSITION RAIN GUARDIAN GUARDIAN FOXHOLE OUTLET PIECE SO PRIMARY OUTLET AUGNS WITH TOE OF BASIN SIDE SLOPE TO AVOID SOIL INTERFERENCE WITH REMOVABLE FILTER WALL.

- 3. SECURE MODULAR FOXHOLE PIECES AT EACH JOINT USING PROVIDED GALVANIZED TIE RODS.
- 4. INSTALL EXPANSION/CONTRACTION JOINT MATERIAL OR A SHEET OF POLY TO SERVE AS A BOND BREAK BETWEEN RAIN GUARDIAN FOXHOLE AND CONCRETE INLET BEFORE POURING INLET.
- 5. REMOVABLE FILTER WALL SHOULD BE INSTALLED WITH FILTER FABRIC FACING THE RAIN GUARDIAN FOXHOLE INLET:



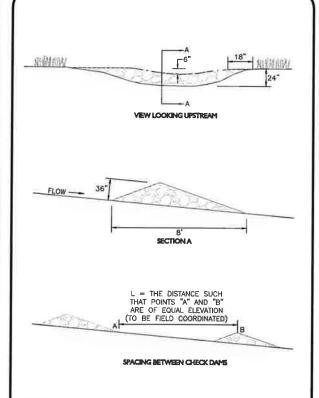


NOTES:

1. THE MAXIMUM CONTRIBUTING DRAINAGE AREA TO THE DAM SHALL BE LESS THAN ONE ACRE.


- 2. THE MAXIMUM HEIGHT OF THE DAM SHALL BE 2 FEET.
- 3. THE CENTER OF THE DAM SHALL BE AT LEAST 6 INCHES LOWER THAN THE OUTER EDGES.
- THE MAXIMUM SPACING BETWEEN THE DAMS SHALL BE SUCH THAT THE TOE OF THE UPSTREAM DAM IS AT THE SAME ELEVATION AS THE OVERFLOW ELEVATION OF THE DOWNSTREAM DAM.
- 5. THE DAMS SHALL BE CHECKED AFTER EACH RAINFALL AND AT LEAST DAILY DURING PROLONGED RAINFALL.
- CHECK DAMS SHALL BE CONSTRUCTED OF A WELL-GRADED ANGULAR 2-INCH TO 3-INCH STONE.




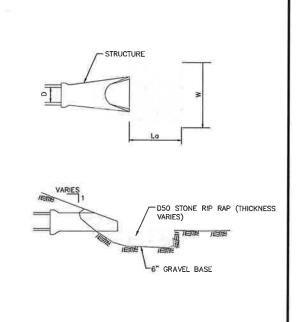



		RIP-RAP SI	ZING CHART		
STRUCTURE	D	La	w	D50	THICKNESS
FES-01	24"	26'	32'	12"	27*
HW-01	18"	20'	25'	7"	16"

RIP-RAP OUTFALL APRON

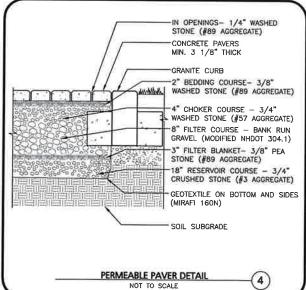

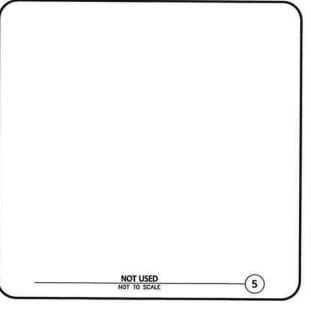

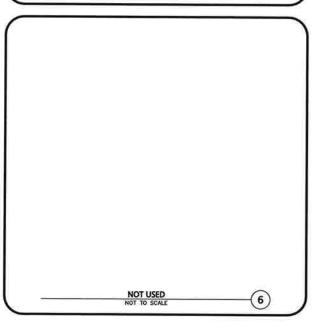

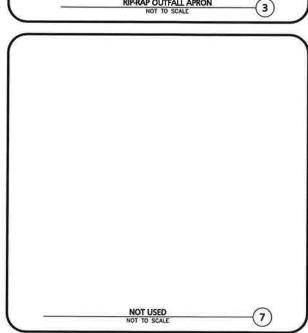



PROFESSIONAL ENGINEER FOR ALLEN & MAJOR ASSOCIATES, INC.

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SIG SAUER 7-8 AMAROSA DRIVE ROCHESTER, NH 03868

7,8,16 AMAROSA DRIVE 0.124 MILTON ROAD **ROCHESTER. NH 03868**

PROJECT NO. 2912-01A DATE: 01-20-23 DWG. NAME: AS SHOWN C2912-01/ DESIGNED BY: JRG CHECKED BY:



il engineering . land surveying environment consulting + landscape architecture www.allenmajor.com

400 HARVEY ROAD MANCHESTER, NH 03103 TEL: (603) 627-5500 FAX: (603) 627-5501

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DRAWING TITLE: DETAILS

C-507

SHEET No