CONTO MM 100x0 100.00 100.00 99.50 x 100.00 99.50 WELL TEST PIT FAILED TEST PIT MONITORING WELL PERC TEST PHOTO LOCATION \$\$ TOTAL HER THOO SOUTH TOTAL THOO SOUTH THE THOU SOUTH THE THOO SOUTH THE THOU SOUTH THE THOO S TREES AND BUSHES SEMER MANHOLE. HYDRANT WATER GATE WATER SHUT OFF REDUCER SINGLE GRATE CATCH BASIN DOUBLE GRATE CATCH BASIN TRANSFORMER CULYERT WANNOWALLS CULYERT WANNOWALLS CULYERT WATLAGED BUD SECTION CULYERT WATLAGED BUD SECTION STIMP CHECK DAM

XXXXX

0.000

V + 250

4K SEPTIC AREA

OPEN WATER

CONCRETE


SNOW STORAGE

GRAVEL

TIDAL WETLANDS

VEGETATED FILTER STRIP

PROPOSED SITE PLAN "BAYBERRY COMMONS" TAX MAP 131, LOT 10 19 OLD GONIC ROAD, ROCHESTER, NH

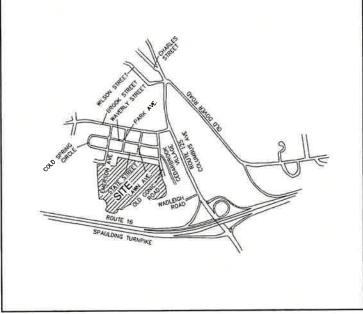

LOCUS MAP SCALE 1" = 2000'

CIVIL ENGINEER / SURVEYOR JONES & BEACH ENGINEERS, INC. 85 PORTSMOUTH AVENUE PO BOX 219 STRATHAM, NH 03885 (603) 772-4746 CONTACT: JOSEPH CORONATI EMAIL: JCORONATI@JONESANDBEACH.COM

TRAFFIC ENGINEER STEPHEN G. PERNAW & COMPANY, INC. P.O. BOX 1821 CONCORD, NH 03302 (603) 731-8500 CONTACT: STEPHEN G. PERNAW EMAIL: SGP@PERNAW.COM

WETLAND CONSULTANT GOVE ENVIRONMENTAL SERVICES, INC. 8 CONTINENTAL DR., BUILDING 2, UNIT H EXETER, NH 03833-7526 (603) 778-0644 CONTACT: JAMES GOVE EMAIL: JGOVE@GESINC.BIZ

LANDSCAPE DESIGNER LM LAND DESIGN, LLC

11 SOUTH ROAD BRENTWOOD, NH 03833 (603) 770-7728 CONTACT: LISE McNAUGHTON LMLANDDESIGN@GMAIL.COM

WATER AND SEWER ROCHESTER DEPARTMENT OF PUBLIC WORKS 45 OLD DOVER ROAD ROCHESTER, NH 03867 (603) 332-4096 CONTACT: MICHAEL BEZANSON, P.E.

ELECTRIC EVERSOURCE ENERGY 74 OLD DOVER ROAD ROCHESTER, NH 03867 (603) 555-5334 CONTACT: MARK BOUCHER **TELEPHONE** CONSOLIDATED COMMUNICATIONS 1575 GREENLAND ROAD GREENLAND, NH 03840 (603) 427-5525

CONTACT: JOE CONSIDINE

COMCAST COMMUNICATION CORPORATION 334-B CALEF HIGHWAY EPPING, NH 03042-2325

NATURAL GAS UNITIL SERVICE CORP. 325 WEST ROAD PORTSMOUTH, NH 03801 (603) 294-5261 MACLEAND@UNITIL.COM

(603) 679-5695

SHEET IND	EX
CS	COVER SHEET
A1	BOUNDARY PLAN
OVR	EXISTING CONDITIONS OVERVIEW PLAN
C1-C4	EXISTING CONDITIONS PLAN
DM-1	DEMOLITION PLAN
OVRS	OVERVIEW SITE PLAN
C5-C8	SITE PLAN
OVRG	OVERVIEW GRADING PLAN
C9-C12	GRADING AND DRAINAGE PLAN
OVRU	OVERVIEW UTILITY PLAN
U1- U 2	UTILITY PLAN
L1-L2	LANDSCAPE PLAN
L3-L4	LIGHTING PLAN
P1-P5	PLAN AND PROFILE
P6-P10	SEWER PLAN AND PROFILE
OFF1	OFFSITE EXISTING CONDITIONS PLAN
OFF2-OFF3	OFFSITE SITE PLAN
OFF4-OFF5	OFFSITE GRADING AND UTILITY PLAN
OFF6	OFFSITE GRADING DETAIL PLAN

OLD GONIC ROAD SIDEWALK DETAIL PLAN OFF 7 OLD GOINIC ROAD SIDEWALK PLAN

DETAIL SHEET D1-D5

EROSION AND SEDIMENT CONTROL DETAILS E1

PHASING PLAN

CURRENT USE PLAN CU

TRUCK TURNING PLAN

CUT AND FILL PLAN

TAX MAP 131, LOT 10

APPLICANT GREEN AND COMPAN 11 LAFAYETTE BOAD

TOTAL LOT AREA 1,302,030 SQ. FT. ±

APPROVED - ROCHESTER, NH PLANNING BOARD ShannaB Saunders 12.5.23 Per March 4,2023 PB Meeting

DATE:	
	 DRAWING

Design: JAC		Date: 04/29/21
Checked: JAC	Scale: AS NOTED	Project No.: 21090
Drawing Name:	21090-PLAN.dwg	
	NOT BE MODIFIED WIT	
	S, AUTHORIZED OR OTI	
AT THE USER'S S	OLE RISK AND WITHOU	LIABILITY TO JBE.




WILDLIFE PROTECTION NOTES:

19	10/31/23	ISSUED FINAL PLANS	LAZ
18	9/12/23	REVISED PER TOWN COMMENTS	LAZ
17	8/24/23	REVISED PER TOWN COMMENTS	LAZ
16	6/14/23	REVISED OFFSITE PLANS	LAZ
15	5/23/23	REVISED PER CONDITIONS OF APPROVAL	LAZ
REV.	DATE	REVISION	BY

T /		De	signed and Proc	duced in NH		
JB Jo	nes	&	Beach	Engin	eers,	Inc.
85 Portsmouth Ave. PO Box 219 Stratham, NH 03885	Civil	Eng	ineering	Services	FAX: 603	3-772-4746 3-772-0227

Plan Name:	COVER SHEET	
Project:	BAYBERRY COMMONS 19 OLD GONIC ROAD, ROCHESTER, NH	
Owner of Record:	LEO P. LACOUTURE REV. TRUST & WILLIAM B. LACOUTURE 19 OLD GONIC RD., ROCHESTER, NH 03867 BK 4093 PG 148	J

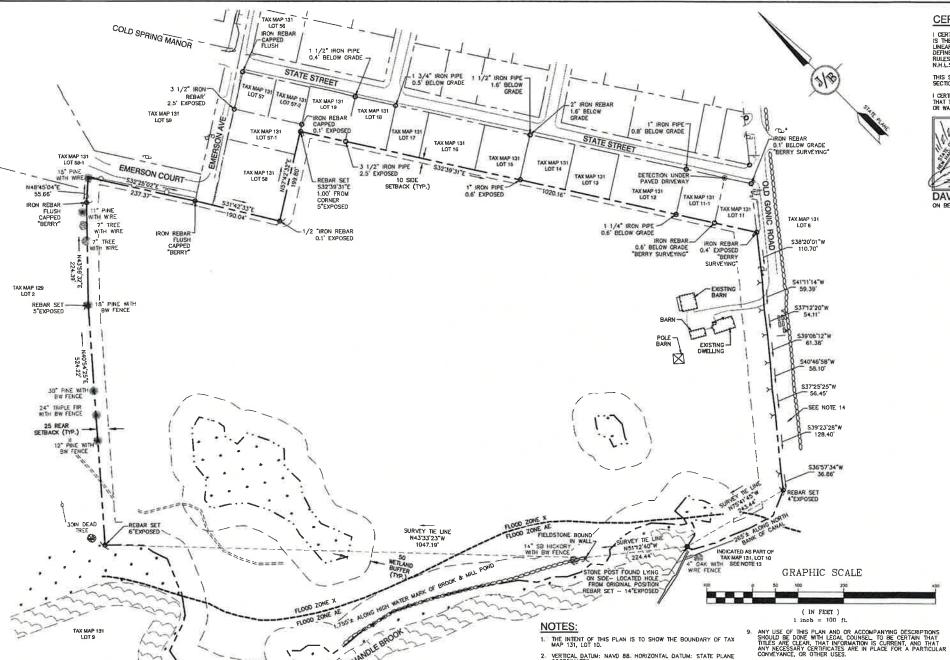

2. VERTICAL DATUM: NAVD 88. HORIZONTAL DATUM: STATE PLANE COORDINATES.

THE SUBJECT PARCEL IS PARTIALLY LOCATED WITHIN AN AREA HAVING A ZONE AE DESIGNATION BY THE FEBRER MERCENCY MANAGEMENT AGENCY (FEMA). OH FLOOD INSURANCE RATE MAP COMMUNITY PANEL NO. 211 OF 405. IN ROCKINGHAM COUNTY STATE OF NEW HAMPSHIRE, WHICH IS THE CURRENT FLOOD INSURANCE RATE MAP FOR COMMUNITY IN WHICH SAID PREMISES IS SITUATED.

CERTAIN DATA HEREON MAY VARY FROM RECORDED DATA DUE TO DIFFERENCES IN DECLINATION, ORIENTATION, AND METHODS OF MEASUREMENT.

ALL BOOK AND PAGE NUMBERS REFER TO THE STRAFFORD COUNTY REGISTRY OF DEEDS.

THE TAX MAP AND LOT NUMBERS ARE BASED ON THE CITY OF ROCHESTER TAX RECORDS AND ARE SUBJECT TO CHANGE.

RESEARCH WAS PERFORMED AT THE CITY OF ROCHESTER ASSESSOR'S OFFICE, THE STRAFFORD COUNTY REGISTRY OF DEEDS. THE NEW HAMPSHIRE DEPARTMENT OF TRANSPORTATION, AND THE NEW HAMPSHIRE STATE ARCHIVES.

THIS SURVEY IS NOT A CERTIFICATION TO OWNERSHIP OR TITLE OF LANDS SHOWN, OWNERSHIP AND ENCUMERANCES ARE MATTERS OF TITLE EXAMINATION NOT OF A BOUNDARY SURVEY. SOF DEEDS REFERENCED HEREON, OWNERSHIP OF ADJOINING PROPERTIES IS ACCORDING TO ASSESSOR'S RECORDS. THIS PLAN MAY OR MAY NOT INDICATE ALL ENCUMBRANCES EXPRESSED, HIMPLED OR PRESCRIPTIVE.

10. THIS PLAN IS THE RESULT OF A CLOSED TRAVERSE WITH A RAW, UNADJUSTED LINEAR ERROR OF CLOSURE GREATER THAN 1 IN 46,000.

. LAND ABUTTING THE DAM IS INDICATED AS BEING A PART OF LOT 10 AS SHOWN ON TAX MAP 131, BUT NO RECORD HAS YET BEEN FOUND AS BEING A PART OF THIS TRACT. REFERENCE DEED BK 607 PG 283, BK 250 PG 71 AND BK 250 PG 103.

15. THE PLAN SET CONSISTS OF 54 TOTAL SHEETS, SHEETS NOT RECORDED HEREWITH ARE ON FILE AT THE CITY OF ROCHESTER

CERTIFICATION:


This survey conforms to a category 1 condition 1 survey as defined in section 4.1 of the n.H.L.s.a. ethics and standards.

I CERTIFY THAT THIS SURVEY PLAT IS NOT A SUBDIVISION PURSUANT TO THIS TITLE AND THAT THE LINES OF STREETS AND WAYS SHOWN ARE THOSE OF PUBLIC OR PROVATE STREETS OR WAYS LARGADY ESTABLISHED AND THAT NO NEW WAYS ARE SHOWN.

11/2/2023



DAVID M. COLLIER, LLS 892 ON BEHALF OF JONES & BEACH ENGINEERS INC.

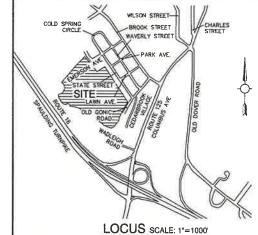

			LO	CUS SCALE: 1"=	1000'
ABUTTERS: 129/02 ROMAN CATHOLIC BINANCE AND REAL	131/08-2 KATHRYN SOUSA 1B CEDARBROOK AVE ROCHESTER, NH 03867 2965/618 (3/30/2004)	131/8-19 JESSICA STENERI 3E CEDARBROOK AVE. ROCHESTER, NH 03867 4487/437 (6/22/17)	131/8-36 JOSHUA SWONGER 60 CEDARBROOK AVE ROCHESTER, NH 03867 4956/1035 (9/21/21)	131/8-53 HOMER WOODBURY 9C CEDARBROOK AVE ROCHESTER, NH 03867 3165/820 (3/31/05)	131/8-67 LISA KIMBALL 11E CEDARBROOK AVE ROCHESTER, NH 03867 4589/936 (6/2/18)
BISHOUT TINANCE AND REAL ESTATE OFFICE 153 ASH ST WANCHESTER, NH 03104	ROCHESTER, NH 03867	131/8-20 SEAN CONNORS 3F CEDARBROOK AVE ROCHESTER, NH 03867 4598/273 (8/27/18)	131/8-37 LINDSEY NICKLESS 6E CEDARBROOK AVE ROCHESTER, NH 03867 4814/926 (10/1/20)	131/8-54 JAMES SAULNIER 9D CEDARBROOK AVE ROCHESTER, NH 03867 4579/933 (6/28/18)	131/8-68 CHARLENE WHITEHOUSE 11F CEDARBROOK AVE ROCHESTER, NH 0.3867 2417/55 (11/25/01)
131/58 TOWNSEND RICHARD 119 HALL ROAD BARRINGTON, NH 03825 4379/86 (5/5/16) - .OT 57-1	4546/299 (1/31/18) 131/08-4 AMY SCHAEFFER 10 CEDARBROOK AVE ROCHESTER, NH 03867 4387/484 (5/26/16)	131/8-21 SRARH GLAMBRONE 4A CEDARBROOK AVE ROCHESTER, NH 03867 3018/408 (6/20/04)	131/8-38 LOURSE BOUCHER 6F CEDARBROOK AVE ROCHESTER, NH 03867 1977/283 (1/11/1998)	131/8-55 ALISON JESSEMAN 9E CEDARBROOK AVE ROCHESTER, NH 03867 4363/989 (3/6/16)	131/8-69 CHRISTINE SENECHAL 12A CEDARBROOK AVE ROCHESTER, NH 03867 4428/130 (10/25/16)
2717/452 (3/31/03) - 1.0T 58 131/59-1 RHA CSM II LIMITED PARTNERSHIP PARTNERSHIP 10 COLE FARM LANE 10 COLESTER, NH 03867 2488/92 (4/4/02)	131/8-5 NATHANEL PRIEBE 1E CEDARBROOK AVE ROCHESTER, NH 03867 4655/795 (5/19/19)	131/8-22 BRIAN NCOUADE 274 CEDAR ST SEBASTIAN, FL 32958 3911/711 (1/13/11)	131/8-39 ERIN FERLAND 7a CEDARBROOK AVE ROCHESTER, NH 03867 4963/870 (10/5/21)	131/8-56 CHEN YIRU 9F CEDARBROOK AVE ROCHESTER, NH 03867 131/8-57	131/8-70 STEHPEN SMALL 12 B CEDARBROOK AVE ROCHESTER, NH 03867 2543/142 (7/11/02)
I31/11	131/8-6 DAVID PETTIS 1F CEDARBROOK AVE ROCHESTER, NH 03867 4658/411 (5/30/19)	131/8-23 KERRY DESAUTEL 4C CEDARBROOK AVE ROCHESTER, NH 03867 3935/932 (6/27/11)	131/8-40 ROBIN GARY 78 CEDARBROOK AVE ROCHESTER, NH 03887 4541/660 (1/4/18)	131/8-57 UWAMBYEYI ESPERANCE 10A CEDARBROOK AVE ROCHESTER, NH 03867 4960/191 (9/23/21) 131/8-58	131/8-71 SARAH BENTON 12C CEDARBROOK AVE ROCHESTER, NH 03867 4573/310 (6/3/18)
15 OLD GONIC ROAD ROCHESTER, NH 03867 3375/947 (5/21/06) 131/11-1 BAGNON CHRISTOPHER BAGNON NAOMI 25 STATE STREET	131/8-7 AMANDA LAMBERT 1G CEDARBROOK AVE ROCHESTER, NH 03867 3631/316 (3/27/08)	131/8-24 PATRICK RILEY 4D CEDARBROOK AVE ROCHESTER, NH 03867 2400/678 (10/30/01)	131/8-41 BRANDON MAINS 7C CEDARBROOK AVE ROCHESTER, NH 03867 4629/242 (1/10/19)	131/8-58 DANIEL DEGRANDPRE 108 CEDARBROOK AVE ROCHESTER, NH 03867 4658/850 (5/29/19)	131/6-72 ROBERT THOMAS 12D CEDARBROOK AVE ROCHESTER, NH 03867 4680/675 (8/14/19)
1477/218 (5/18/17)	131/8-8 CAROLINE LEWS 1H CEDARBROOK AVE ROCHESTER, NH 0,3867 4597/717 (8/30/18)	131/8-25 PAULE PRATT 4E CEDARBROOK AVE ROCHESTER, NH 03867 2916/46 (12/11/03)	131/8-42 10LA FOREMAN 7D CEDARBROOK AVE ROCHESTER, NH 03867 4598/155 (8/30/18)	131/8-59 RALPH STILLINGS 10C CEDARGROOK AVE ROCHESTER, NH 03867 4525/479 (10/26/17)	131/8-73 SUSAN WELSH 12E CEDARBROOK AVE
31/12 CODLING COREY 21 STATE ST ROCHESTER, NH 03867 1927/624 (6/29/21) 31/13	131/6-9 STEPHEN & PATRICIA TALOR 2A CEDARBROOK AVE ROCHESTER, NH 03867 2392/538 (10/15/01)	131/8-26 TIMUR GAMIROV 4F CEDARBROOK AVE ROCHESTER, NH 03867 4296/903 (5/28/15)	131/8-43 MELANIE HOLT 7E CEDARBROOK AVE ROCHESTER, NH 03857 4798/961 (8/17/20)	131/8-60 DENISE SELFE 100 CEDARBROOK AVE ROCHESTER, NH 03867 2215/260 (4/16/2000) 131/8-61	131/8-74 MELINDA RIGGER REV. TRUST 12F CEDARBROOK AVE ROCHESTER, NH 03867 4304/153 (6/25/15)
31/13 ABRIE FAMILY TRUST 7 STATE ST ROCHESTER, NH 03867 R627/285 (11/14/18) 31/14 3 STATE STREET LLC	131/8-10 BRIAN HEBERT 2B CEDARBROOK AVE ROCHESTER, NH 03867	131/8-27 HAYDEN GRACE KRISTY 5A CEDARBROOK AVE ROCHESTER, NH 03867 4864/777 (6/19/19)	131/8-44 ALEXANDRA MICKMAN JOSEPH WARREN 7F CEDARBROOK AVE ROCHESTER, NH 03867	RICHARD DUSETT 33 ALEXANDRA LANE ROCHESTER NH 03867 1304/258 (4/15/1987)	131/09 CITY OF ROCHESTER 31 WAKEFIELD ST ROCHESTER, NH 03867
	3567/428 (8/23/07) 131/8-11 BUDI TANUDIHARTA 2C CEDARBROOK AVE ROCHESTER, NH 03887 429/512 (5/7/15)	131/8-28 LINDA LACHANCE 59 CEDARBROOK AVE ROCHESTER, NH 03867 3477/108 (12/21/06)	4765/958 (5/28/20) 131/8-45 KAREN BAILEY BA CEDARBROOK AVE ROCHESTER, NH 03867 3876/380 (10/27/10)	10 F CEDARBROOK AVE ROCHESTER, NH 03867 4792/125 (5/7/20)	3371/144 (4/10/06) 137/35-1 SSG LLC 120 WASHINGTON ST SUITE 302 ROCHESTER, NH 03867
1 STATE STREET ROCHESTER, NH 03867 1702/788 (10/23/19) 31/16 RISBEE TRACEY	429/512 (5/7/15) 131/8-12 GEORGE GATCOMB 2D CEDARBROOK AVE ROCHESTER, NH 03867 3328/679 (1/26/06)	131/8-29 MICHAEL WALSH 5C CEDARBROOK AVE ROCHESTER, NH 03867 4705/193 (10/30/19)	131/8-46 MICHAEL CROVETTI BB CEDARBROOK AVE BDCVESTER NH 03867	131/8-63 TARA CANFIELD 11A CEDARGROOK AVE ROCHESTER, NH 03867 2443/74 (1/10/02) 131/8-64	4605/408 (9/27/18)
64 BROCK ST ROCHESTER, NH 03867 847/802 (12/13/20)	131/8-13 RAYMOND KING 2E CEDARBROOK AVE ROCHESTER, NH 03867	131/8-30 SANDRA FOURNIER 50 CEDARBROOK AVE ROCHESTER, NH 03867 2942/181 (2/11/04)	4715/120 (12/2/19) 131/8-47 PHILIP LANG 8C CEDARBROOK AVE ROCHESTER, NH 03867 4581/977 (6/28/18)	131/8-64 MOORE FAMILY REV. TRUST 21 RIDGEWOOD ROAD ELIOT, MAINE 03903 131/8-65	
31/17 NUCHESNEAU MICHELLE V STATE ST COCHESTER, NH 03867 1158/178 (2/14/05) 31/18	3474/0028 (12/18/06) 131/8-14 0AK BLUFF REALTY LLC 242 CENTRAL AVE DOVER NH 03820 3953/549 (9/8/11)	131/8-31 OLD DOG PROPERTIES LLC 24 MORRISSON LANE DOVER NH 03820 4027/158 (5/29/12)	131/8-48 ROBIN LORD 8D CEDARBROOK AVE ROCHESTER, NH 03867	131/8-65 LYNNE PARADIS 11C CEDAMEROOK AVE ROCHESTER, NH 03867 3120/280 (12/21/04) 131/8-66	
0 WSTATE STREET OCHESTER, NH 03867 769/475 (6/2/20)	3953/549 (9/8/11) 131/8-15 SEAN JACKSON 3A CEDARBROOK AVE ROCHESTER, NH 03867	4027/158 (5/29/12) 131/8-32 ELIZABETH RANKS 235 LONG POND ROAD DANVILLE NH 03819	4923/182 (6/22/21) 131/8-49 MARISSA CORBIN BE CEDARBROOK AVE ROCHESTER, NH 03867	131/8-66 GRANT REALTY TRUST ATTN: DAMD PAOLINI 242 CENTRAL AVE DOVER NH 03820 4178/531 (11/5/13)	
ELINAS BRYAN Erinas paufia	4581 /644 (R /2R /1R)	3719/769 (3/10/09) 131/8-33 DEBRA WELCH 6A CEDARBROOK AVE ROCHESTER, NH 03867	4545/275 (4/3/19) 131/8-50 JUSTIN MANTEUFFEL BF CEDARBROOK AVE ROCHESTER, NH 03867	CITY OF I	OT PARCEL, ROCHESTER 131, LOT 10
ONDO ASSOCIATION 4A CEDARBROOK VILL OCHESTER, NH 03867	131/8-17 ALICIA MANSON 3C CEDARBROOK AVE ROCHESTER, NH 03867	131/8-34 JOSEPH ZUROMSKIS 6B CEDARBROOK AVE ROCHESTER, NH 03867 2110/732 (5/26/1999)	131/8-51 JEFFREY BOOMER 9A CEDARBROOK AVE ROCHESTER, NH 03867	GREEN AI 11 LAFA'	LICANT ND COMPANY YETTE ROAD
31/08-1	4623/411 (11/27/18)	131/8-35 ONGCOWARS/TO	4576/729 (6/17/18)	NORTH HAM	PTON, NH 03862

TOTAL LOT AREA 29.9 ± ACRES

Design: JAC	Draft: LAZ	Date: 04/29/21				
Checked: JAC	Scale: AS NOTED	Project No.: 21090				
Drawing Name: 21090-PLAN.dwg						
PERMISSION FRO	NOT BE MODIFIED WITH M JONES & BEACH ENG	INEERS, INC. (JBE).				
ANY ALTERATIONS, AUTHORIZED OR OTHERWISE, SHALL BE						
AT THE USER'S SI	OLE RISK AND WITHOUT	LIABILITY TO JBE.				

FRESHWATER WETLANDS

PROPERTY LINES
FRESHWATER WETLANDS LINE

FRESHWATER WETLANDS LINE STONEWALL FENCE PLOOD PLAIN LINE EDGE OF PAWEMENT IRON PREPAREND FOR THE PROPERTY PROVIDED TO BE SET STONE PROMISED BENCHMARK (TBM)

GENERAL LEGEND

DESCRIPTION

OPEN WATER

EXISTING

4 9 9



PLAN REFERENCES:

"CEDARBROOK VILLAGE CONDOMINIUM DEVELOPMENT BOUNDARY SURVEY FOR ROUNDHOUSE REALTY TRUST ROCHESTER, NH", PREPARED BY BERRY CONST. CO., INC.; DATED APRIL 23, 1989: RECORDED AT THE STRAFFORD COUNTY REGISTRY OF DEEDS AS PLAN P23—059.

PLAN OF LAND PARCEL NO. 5 TAX ASSESSOR'S MAP 59 AND PARCEL NO. 2 TAX ASSESSOR'S MAP NO 8 NEW HAMPSHIRE ROULD 125 PREPARED FOR JEN-SCOT REALTY, INC.; PREPARED BY CIVILWORKS ENGREERS AND SURVEYORS, DATED NOVEMBER 8, 1989 RECORDED AT THE STRAFFORD COUNTY REGISTRY OF DEEDS AS PLAN P374-028.

3. "PROPOSED SUBDIVISION AND LOT LINE REVISION FOR ROCHESTER HOUSING AUTHORITY COLD SPRING MANOR BROOK STREET ROCHESTER, NH"; PREPARED BY BERRY SURVEYING & ENGINEERING: DATED FEBRUARY 13, 2001; RECORDED AT THE STRAFFORD COUNTY REGISTRY OF DEEDS AS PLAN P61–056.

REV.	DATE	REVISION	BY
15	5/23/23	REVISED PER CONDITIONS OF APPROVAL	LAZ
16	6/14/23	REVISED OFFSITE PLANS	LAZ
17	8/24/23	REVISED PER TOWN COMMENTS	LÁZ
16	9/12/23	REVISED PER TOWN COMMENTS	LAZ
19	10/31/23	ISSUED FINAL PLANS	LAZ

"PROPOSED SUBDIVISION LAND OF THOMAS & JODI
REMINISTON 15 OLD CONIC ROAD ROCHESTER, NIST,
PREPARED BY SERRY SLIVEVINIG & ENGERERING;
DATED AUGUST 17, 2005; RECORDED AT THE
STRAFFORD COUNTY REGISTRY OF DEEDS AS PLAN
PBI-0036.

. "SUBDIVISION PLAN TAX MAP 131, LOT 26 WAVERLY ST./ CLD GONIC RD. ROCHESTER NH FOR BAYONNE CONSTRUCTION COMPANY, INC.; PREPARED BY NORWAY PLANS ASSOCIATES, INC. DATED JULY 25, 2006; RECORDED AT THE STRAFFORD COUNTY REGISTRY OF DEEDS AS PLAN P86-0100.

"SUBDIMSION PLAN TAX MAP 131, LOT 57 STATE STREET & EMERSON COURT ROCHESTER NH FOR RUNNING WITH HAMMERS, LLC": PREPARED BY NORWAY PLANS ASSOCIATES, INC: DATED OCTOBER 17, 2007: RECORDED AT THE STRAFFORD COUNTY REGISTRY OF DEEDS AS PLAN P82-014.


"ROCHESTER HEIGHTS ROCHESTER, NH A.H. CHAPMAN LAND CO"; PREPARED BY E.H. SHEFFIELD; DATED JULY 1920; RECORDED AT THE STRAFFORD COUNTY REGISTRY OF DEEDS AS PLAN #10 POCKET #10 FOLDER #3.

Designed and Produced in NH B Jones & Beach Engineers, Inc. 85 Portsmouth Ave. Civil Engineering Services FAX: 603-772-0227 PO Box 219 Stratham, NH 03885 E-MAIL: JBE@JONESANDBEACH.COM

BOUNDARY PLAN TAX MAP 131, LOT 10 Plan Name BAYBERRY COMMONS 19 OLD GONIC ROAD, ROCHESTER, NH Project: LEO P. LACOUTURE REV. TRUST & WILLIAM B. LACOUTURE 19 OLD GONIC RD., ROCHESTER, NH 03867 BK 4093 PG 148

A1 SHEET 2 OF 54 JBE PROJECT NO: 21090



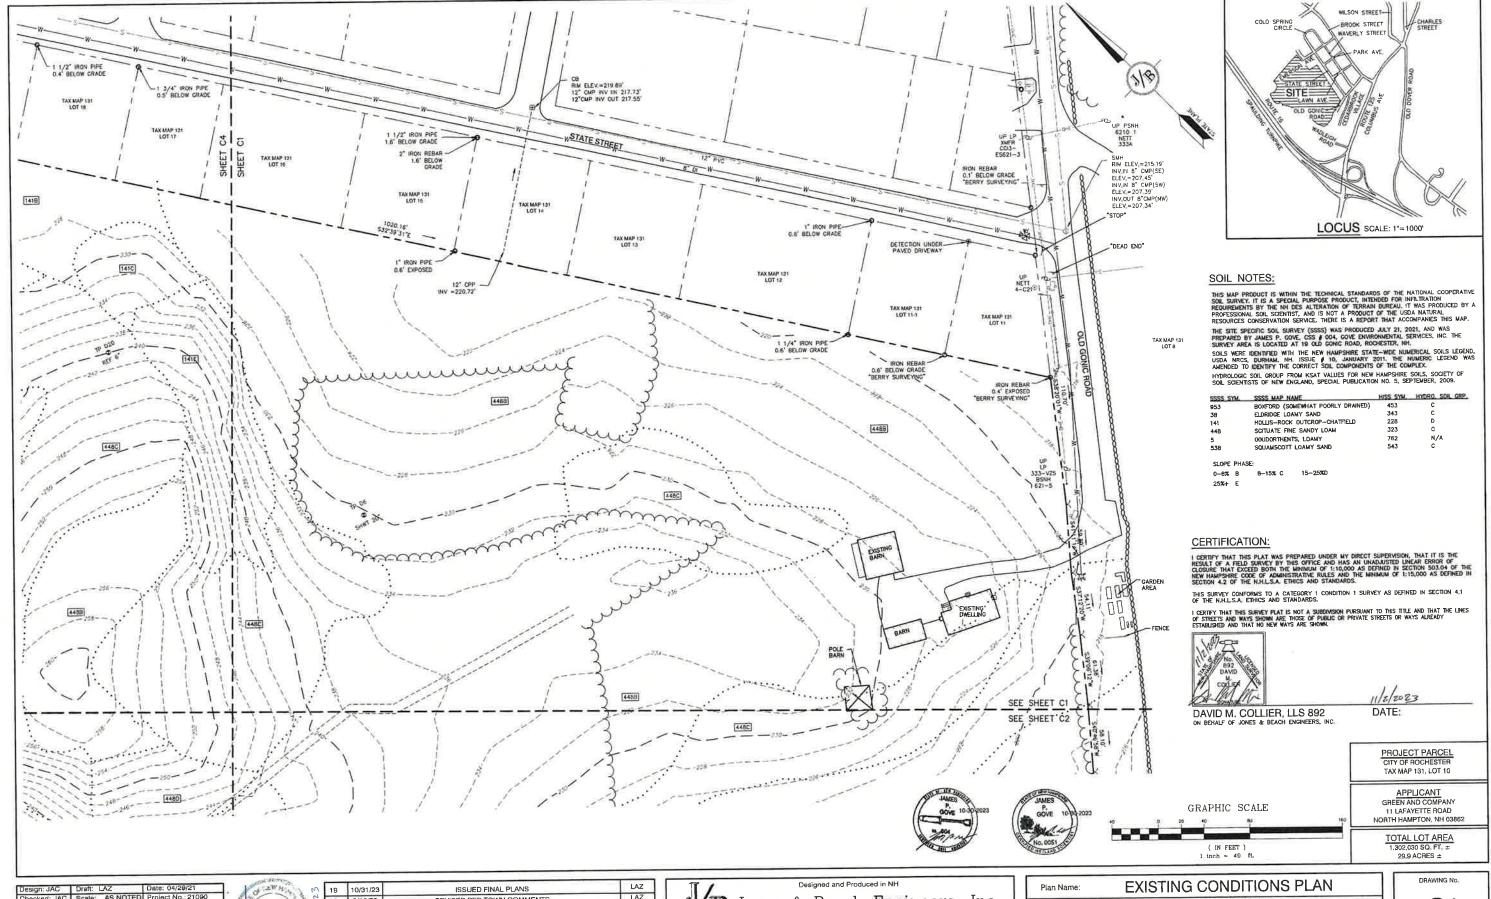

Checked: JAC Scale: AS NOTED Project No.: 21090
Drawing Name: 21090-PLAN.dwg THIS PLAN SHALL NOT BE MODIFIED WITHOUT WRITTEN ERMISSION FROM JONES & BEACH ENGINEERS, INC. (JBE).

ANY ALTERATIONS, AUTHORIZED OR OTHERWISE, SHALL BE AT THE USER'S SOLE RISK AND WITHOUT LIABILITY TO JBE.

19	10/31/23	ISSUED FINAL PLANS	LAZ
18	9/12/23	REVISED PER TOWN COMMENTS	LAZ
17	B/24/23	REVISED PER TOWN COMMENTS	LAZ
16	6/14/23	REVISED OFFSITE PLANS	LAZ
15	5/23/23	REVISED PER CONDITIONS OF APPROVAL	LAZ
REV.	DATE	REVISION	BY
	17 16 15	18 9/12/23 17 8/24/23 16 6/14/23 15 5/23/23	18 9/12/23 REVISED PER TOWN COMMENTS 17 8/24/23 REVISED PER TOWN COMMENTS 16 6/14/23 REVISED OFFSITE PLANS 15 5/23/23 REVISED PER CONDITIONS OF APPROVAL

B Jones & Beach Engineers, Inc.


603-772-4746 85 Portsmouth Ave Civil Engineering Services Services FAX: 603-772-0227 E-MAIL: JBE@JONESANDBEACH.COM

BAYBERRY COMMONS 19 OLD GONIC ROAD, ROCHESTER, NH Project:

LEO P. LACOUTURE REV. TRUST & WILLIAM B. LACOUTURE 19 OLD GONIC RD., ROCHESTER, NH 03867 BK 4093 PG 148

C1


SHEET 4 OF 55

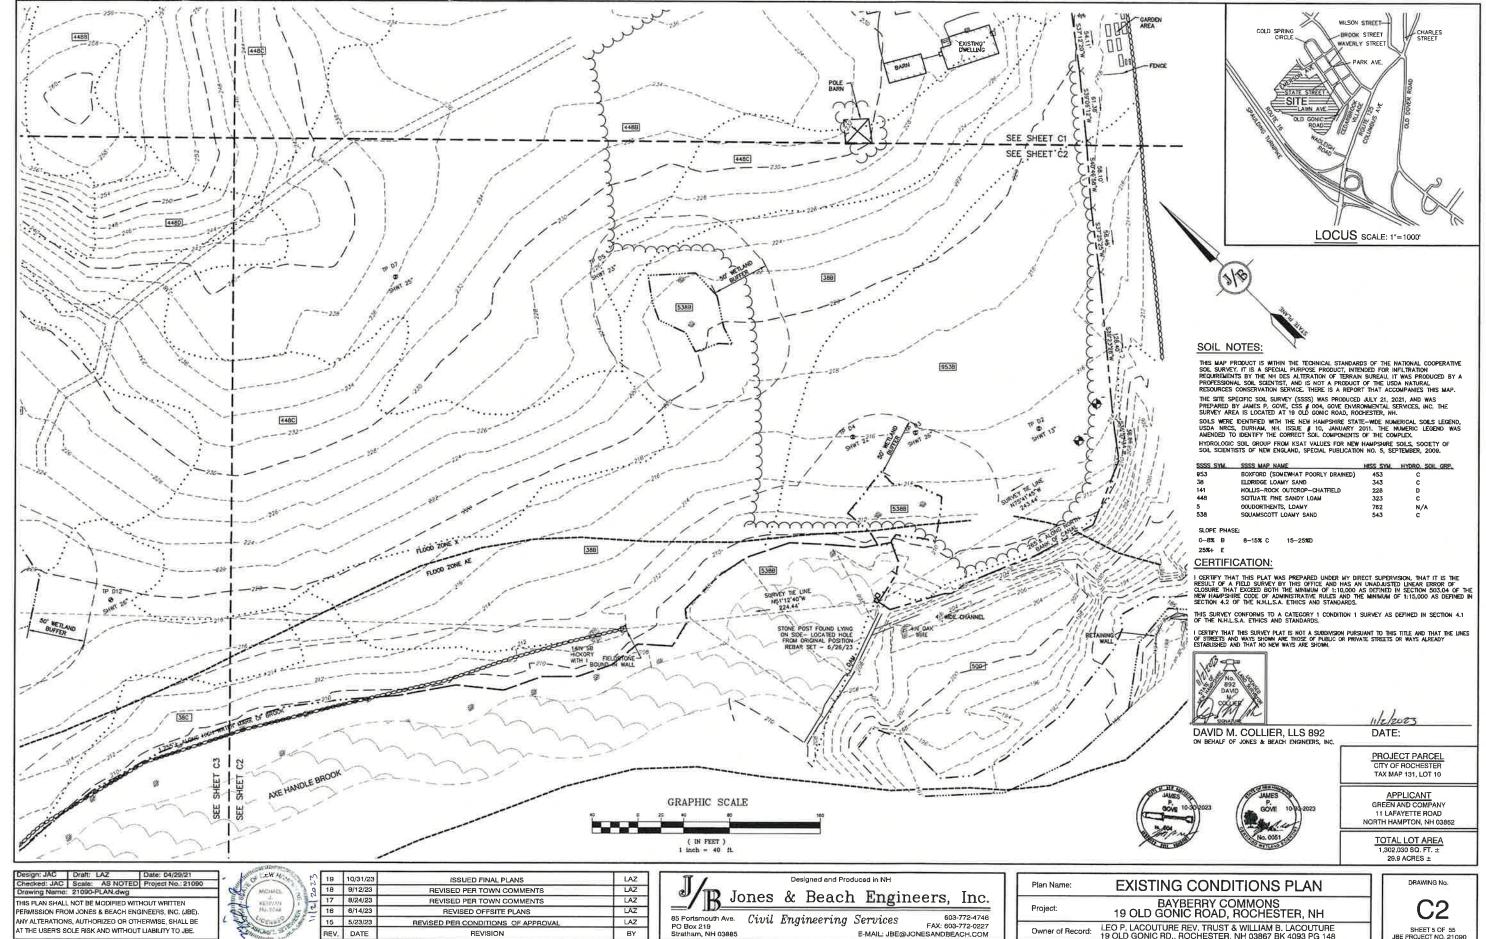


E-MAIL: JBE@JONESANDBEACH.COM

LEO P. LACOUTURE REV. TRUST & WILLIAM B. LACOUTURE 19 OLD GONIC RD., ROCHESTER, NH 03867 BK 4093 PG 148

SHEET 5 OF 55 JBE PROJECT NO. 21090

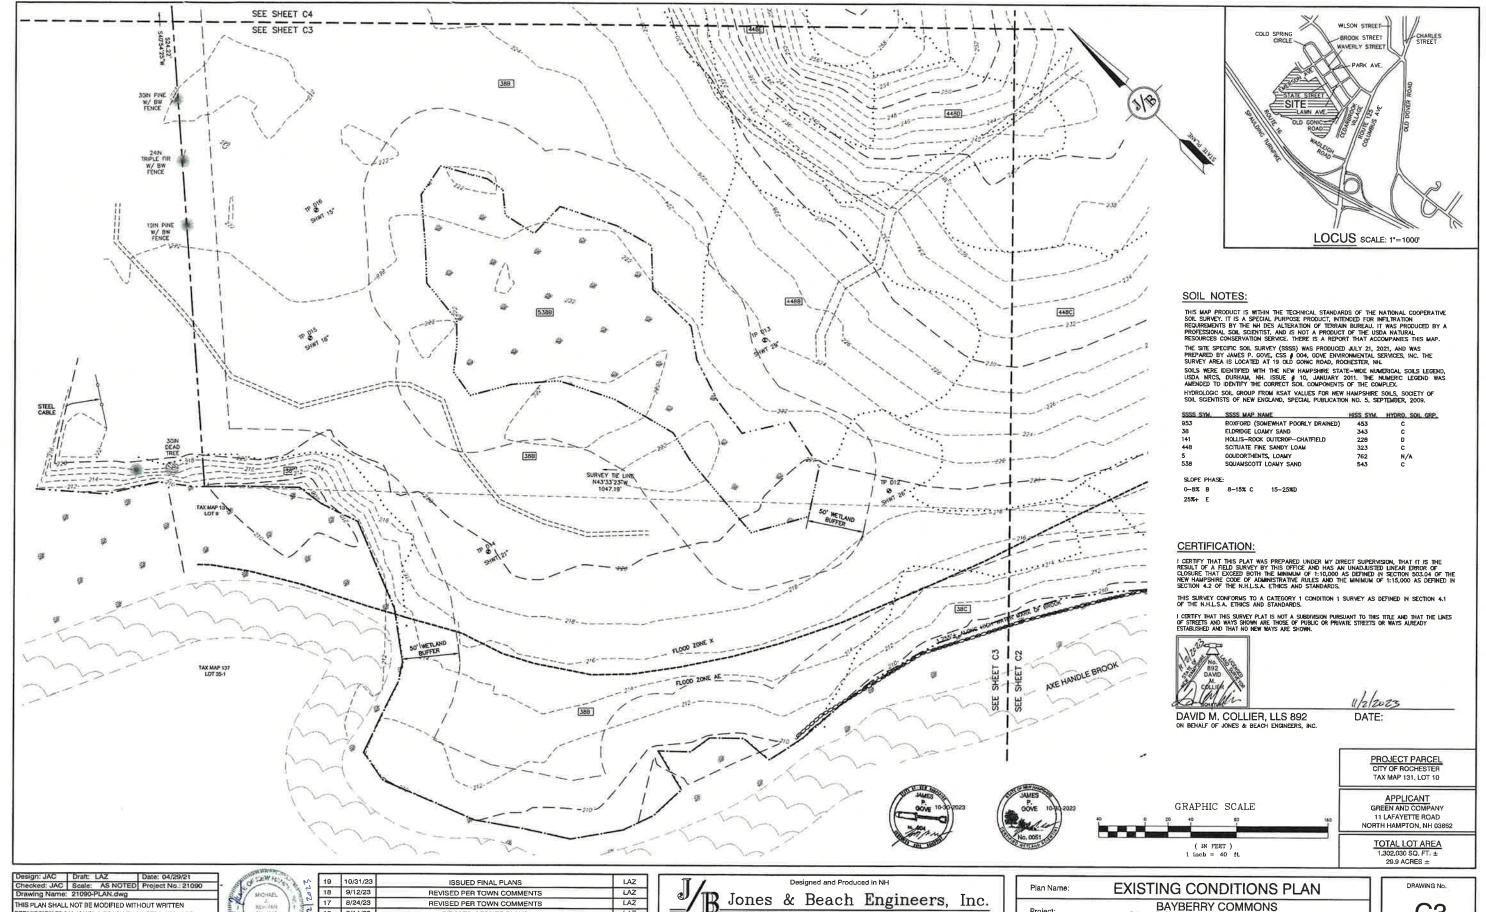

			Project No.: 21090	7-
Drawing Name:	21090-P	LAN.dwg		7
THIS PLAN SHALL	NOT BE N	ODIFIED WITH	HOUT WRITTEN	7
PERMISSION FRO	M JONES	& BEACH ENG	INEERS, INC. (JBE).	-
ANY ALTERATIONS	S, AUTHOI	RIZED OR OTH	IERWISE, SHALL BE	1
AT THE USER'S SO	LE RISK A	TUOHTIW DIV	LIABILITY TO JBE.	

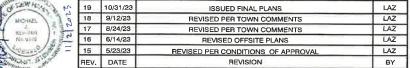

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Portsmouth Ave Box 219 tham, NH 03885	Civil	Engineering	603-772-4746 FAX: 603-772-0227 ONESANDBEAGH_COM


	Plan Name:	EXISTING CONDITIONS PLAN
	Project:	BAYBERRY COMMONS

Owner of Record:

LEO P. LACOUTURE REV. TRUST & WILLIAM B. LACOUTURE 19 OLD GONIC RD., ROCHESTER, NH 03867 BK 4093 PG 148

C3

SHEET 6 OF 55 JBE PROJECT NO. 21090

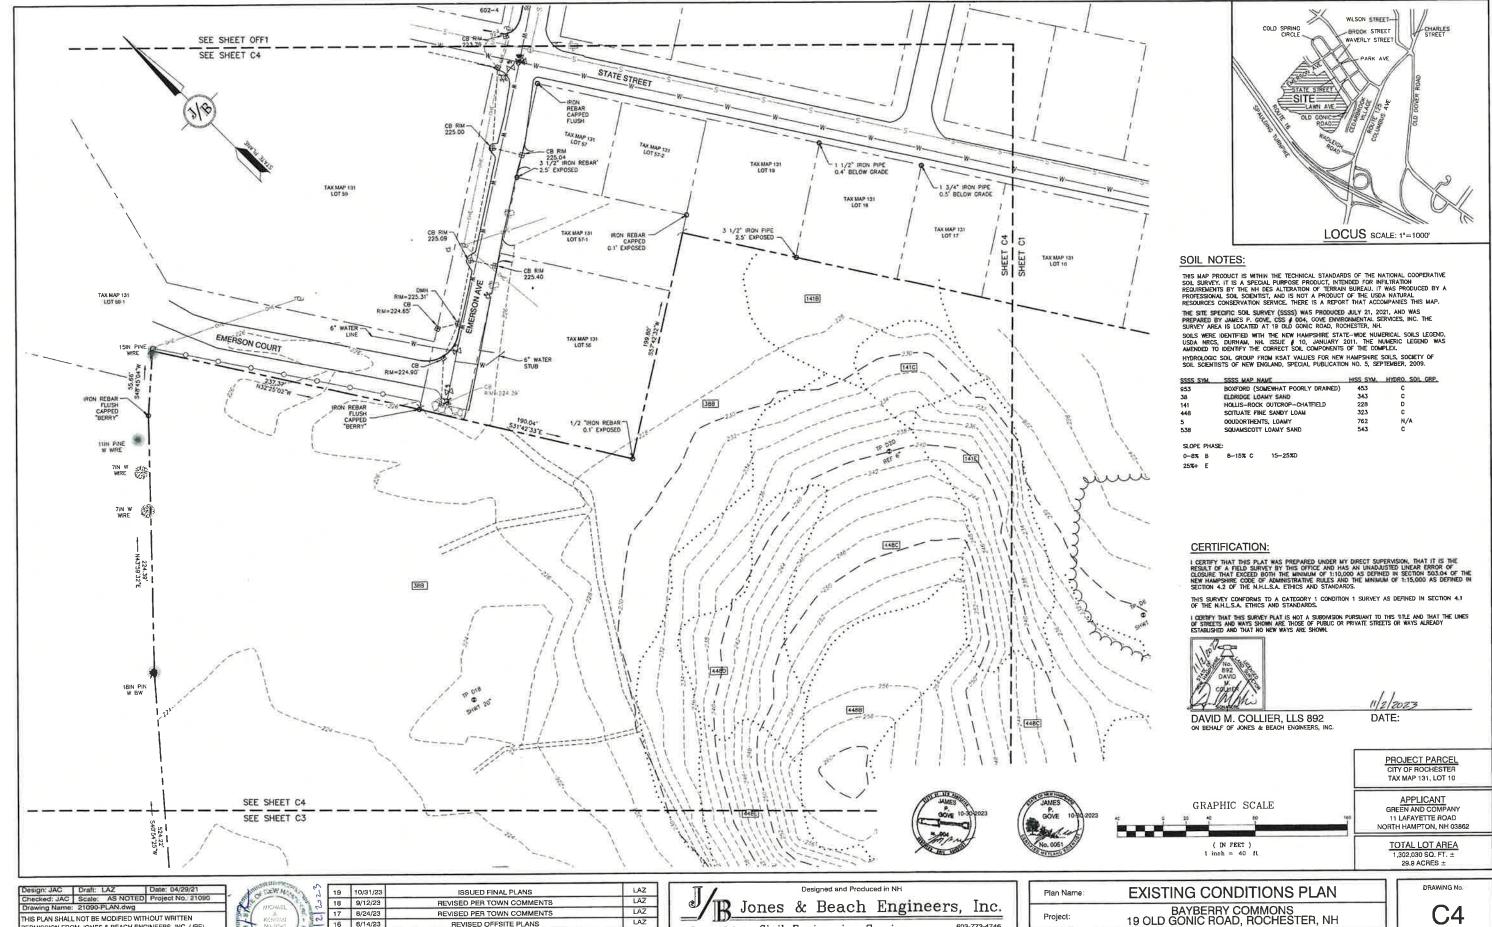

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18	9/12/23	REVISED PER TOWN COMMENTS	LAZ
17	B/24/23	REVISED PER TOWN COMMENTS	LAZ
16	6/14/23	REVISED OFFSITE PLANS	LAZ
15	5/23/23	REVISED PER CONDITIONS OF APPROVAL	LAZ
REV.	DATE	REVISION	BY

B Jones & Beach Engineers, Inc. 85 Portsmouth Ave. Civil Engineering Services FAX: 603-772-0227 E-MAIL: JBE@JONESANDBEACH.COM PO Box 219 Stratham, NH 03885

	Tidil Name.	EXISTING CONDITIONS I LAN
	Project:	BAYBERRY COMMONS 19 OLD GONIC ROAD, ROCHESTER, NH
	Owner of Record:	LEO P. LACOUTURE REV. TRUST & WILLIAM B. LACOUTURE 19 OLD GONIC RD., ROCHESTER, NH 03867 BK 4093 PG 148

C4



DEMOLITION NOTES:

- 1. THIS PLAN IS INTENDED TO PROVIDE MINIMUM CUIDELINES FOR SITE DEMOLITION. IT SHOULD BE NOTED THAT ALL MANMADE FEATURES, PAYEMENT, SIGNS, POLES, CURBING, CONCRETE WALKS, UTILITIES, ETC., SHALL BE REJUNZD AS MECESSARY TO CONSTRUCT WORK, UNLESS OTHERWISE NOTED TO REJAIN. THROUGHOUT THE CONSTRUCTION PROCESS, THE CONTRACTOR SHALL INFORM THE ENGINEER INCLUDES ANY FIELD DISCREPANCES FROM DATA AS SHOWN ON DESIGN PLANS. THIS INCLUDES ANY FIELD DISCREPANCES FROM DATA AS SHOWN ON DESIGN PLANS. THIS INCLUDES ANY UNFORESEEN CONDITIONS, SUBSURFACE OR OTHERWISE FOR EVALUATION AND RECOMMENDATIONS. ANY CONTRADICTION RETWENT THESE OF THE DATA OF A LETT. ON PROCESS. RECOMMENDATIONS. ANY CONTRADICTION SETMEN ITEMS OF THIS PLAN/PLAN SET, OR BETWEEN THE PLANS AND ON-SITE CONDITIONS MUST BE RESOLVED BEFORE RELATED CONSTRUCTION HAS BEEN INTRATED.
- A TEMPORARY CULVERT AND ROADBED SHALL BE IN PLACE PRIOR TO ANY USE OF A WETLAND CROSSING.
- WETLAND IMPACTS SHALL NOT OCCUR UNTIL ALL PERMITS HAVE BEEN ACQUIRED AND IMPACT MITIGATION REQUIREMENTS HAVE BEEN SATISFIED.
- PRIOR TO THE START OF CONSTRUCTION, THE CONTRACTOR IS REQUIRED TO HAVE THE PROJECT LAND SURVEYOR STAKE OR FLAG CLEARING LIMITS. A MINIMUM OF 48 HOURS NOTICE IS REQUIRED, CLEARING LIMITS ARE THE EDGE OF THE PROPERTY AND THE LIMITS OF WORK.
- ALL EXISTING STRUCTURES WITHIN THE CONSTRUCTION AREA, UNLESS OTHERWISE NOTED TO REMAIN, SHALL BE REMOVED AND DISPOSED OF OFF-SITE IN ACCORDANCE WITH ALL LOCAL, STATE AND FEDERAL GUIDELINES. ANY BURNING ON-SITE SHALL BE SUBJECT TO LOCAL ORDINANCES.
- 6. ALL EXISTING PAVED SURFACES WITHIN THE LIMITS OF WORK THAT ARE TO REMAIN SHALL BE RECLAIMED TO MINIMUM DEPTH OF 12" AND REGRADED AS SHOWN ON THE GRADING AND DRAINAGE PLAN. RECLAIMED ASPHALT SHALL CONFORM TO STATE SPECIFICATIONS. PRIOR TO REMOVAL, PAYEMENT SHALL BE SAWCUT AT ALL ENTRANCES AND LIMITS OF REMOVAL.
- ALL EXISTING GRANITE CURBING TO BE REMOVED SHALL BE STOCKPILED IN AN AREA TO BE
 DESIGNATED BY THE OWNER OR DWINEY'S REPRESENTATIVE. THE OWNER SHALL INSPECT GRANITE
 CURBING TO BE RESET AND APPROVE LOCATION OF RESET CURBING. THE CONTRACTOR SHALL NOT
 INSTALL USED CURBING AT ANY ENTRANCE LOCATIONS.
- ALL EXISTING UTILITIES SHALL BE TERMINATED AT THE PROPERTY LINE, UNLESS OTHERWISE NOTED ON THE PLANS, IN CONFORMANCE WITH LOCAL, STATE AND UTILITY COMPANY STANDARDS, SPECIFICATIONS AND DETAILS. THE CONTRACTOR SHALL COORDINATE UTILITY SERVICE DISCONNECTS WITH THE UTILITY REPRESENTATIVES PRIOR TO THE START OF WORK.
- 9. EXISTING WATERLINES AND HYDRANTS TO BE REMOVED SHALL BE CAPPED AT EXISTING WATERMAIN.
- 10, EXISTING GAS SERVICE LINES ARE TO BE REMOVED ON-SITE UP TO EXISTING GASMAIN LINES OR VALVES.
- 11. THE CONTRACTOR SHALL REMOVE AND PROPERLY DISPOSE OF ALL CONTAMINATED MATERIAL LOCATED IN THE AREA OF EXISTING LEACHFIELDS IN ACCORDANCE WITH LOCAL AND STATE REGULATIONS.
- ALL CURBING, CONCRETE, PAVEMENT, BUILDINGS AND SUBBASE MATERIALS LOCATED WITHIN PROPOSED LANDSCAPED AREAS SHALL BE REMOVED AND REPLACED WITH LOAM MATERIALS SUITABLE FOR LANDSCAPING IN ACCORDANCE WITH TECHNICAL SPECIFICATIONS. (SEE ALSO LANDSCAPE PLAN).
- SEE LANDSCAPE PLAN FOR "TREES TO BE SAVED" AND DETAILS ASSOCIATED WITH LANDSCAPED AREAS.
- 14. THE CONTRACTOR SHALL OBTAIN TREE CLEARING PERMIT FROM LOCAL AND STATE AUTHORITIES PRIOR TO START OF CONSTRUCTION (IF REQUIRED).
- CONTRACTOR SHALL HAVE THE OPTION TO REMOVE DRAINAGE/SEWER STRUCTURES, OR REMOVE MANHOLE FRAME AND GRATE/COVER TO A MINIMUM OF 36" BELOW FINISH GRADE, FRACTURE BOTTOM AND FILL WITH COMPACTED BIORROW.
- 16. IN AREAS WHERE CONSTRUCTION IS PROPOSED ADJACENT TO ABUTTING PROPERTIES, THE CONTRACTOR SHALL INSTALL ORANGE CONSTRUCTION FENCING ALONG PROPERTY LINES IN ALL AREAS WHERE SLIT FENCING IS NOT REQUIRED.
- EXISTING SANITARY SEWER LINE AND STRUCTURES LOCATED WITHIN THE EXISTING SEWER EASEMENTS SHALL BE MAINTAINED OR MODIFIED AS NOTED ON PLANS. SEWER LINES SHALL BE DISCONNECTED IN ACCORDANCE WITH LOCAL STANDARDS AND REGULATIONS.
- 18. EROSION AND SEDIMENTATION CONTROL MEASURES SHALL BE INSTALLED PRIOR TO CONSTRUCTION AND ANY EARTH MOVING OFFERATIONS, SILT FENCE SHALL BE INSTALLED AT THE LIMITS OF IMPACT AREAS ACCORDING TO THE DETAILS SHOWN ON SHEET EL.
- EXCAVATED MATERIALS WILL BE PLACED WITHIN UPLAND AREAS AS FILL MATERIAL OR HAULED OFF—SITE FOR DISPOSAL IN AN APPROPRIATE UPLAND LOCATION.

PROJECT PARCEL TAX MAP 131, LOT 10

APPLICANT GREEN AND COMPANY 11 LAFAYETTE ROAD

TOTAL LOT AREA 1.302,030 SQ. FT. ± 29.9 ACRES ±

Design: JAC Draft: LAZ Date: 04/29/21
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Drawing Name: 21090-PLAN.dwg THIS PLAN SHALL NOT BE MODIFIED WITHOUT WRITTEN PERMISSION FROM JONES & BEACH ENGINEERS, INC. (JBE). NY ALTERATIONS, AUTHORIZED OR OTHERWISE, SHALL BE AT THE USER'S SOLE RISK AND WITHOUT LIABILITY TO JBE.




19	10/31/23	ISSUED FINAL PLANS	LAZ
18	9/12/23	REVISED PER TOWN COMMENTS	LAZ
17	8/24/23	REVISED PER TOWN COMMENTS	LAZ
16	6/14/23	REVISED OFFSITE PLANS	LAZ
15	5/23/23	REVISED PER CONDITIONS OF APPROVAL	LAZ
REV.	DATE	REVISION	BY

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Plan Name:	DEMOLITION PLAN
Project:	BAYBERRY COMMONS 19 OLD GONIC ROAD, ROCHESTER, NH
Owner of Record:	LEO P. LACOUTURE REV. TRUST & WILLIAM B. LACOUTURE 19 OLD GONIC RD., ROCHESTER, NH 03867 BK 4093 PG 148

DRAWING No. DM-1



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16	6/14/23	REVISED OFFSITE PLANS	LAZ
15	5/23/23	REVISED PER CONDITIONS OF APPROVAL	LAZ
REV.	DATE	REVISION	BY

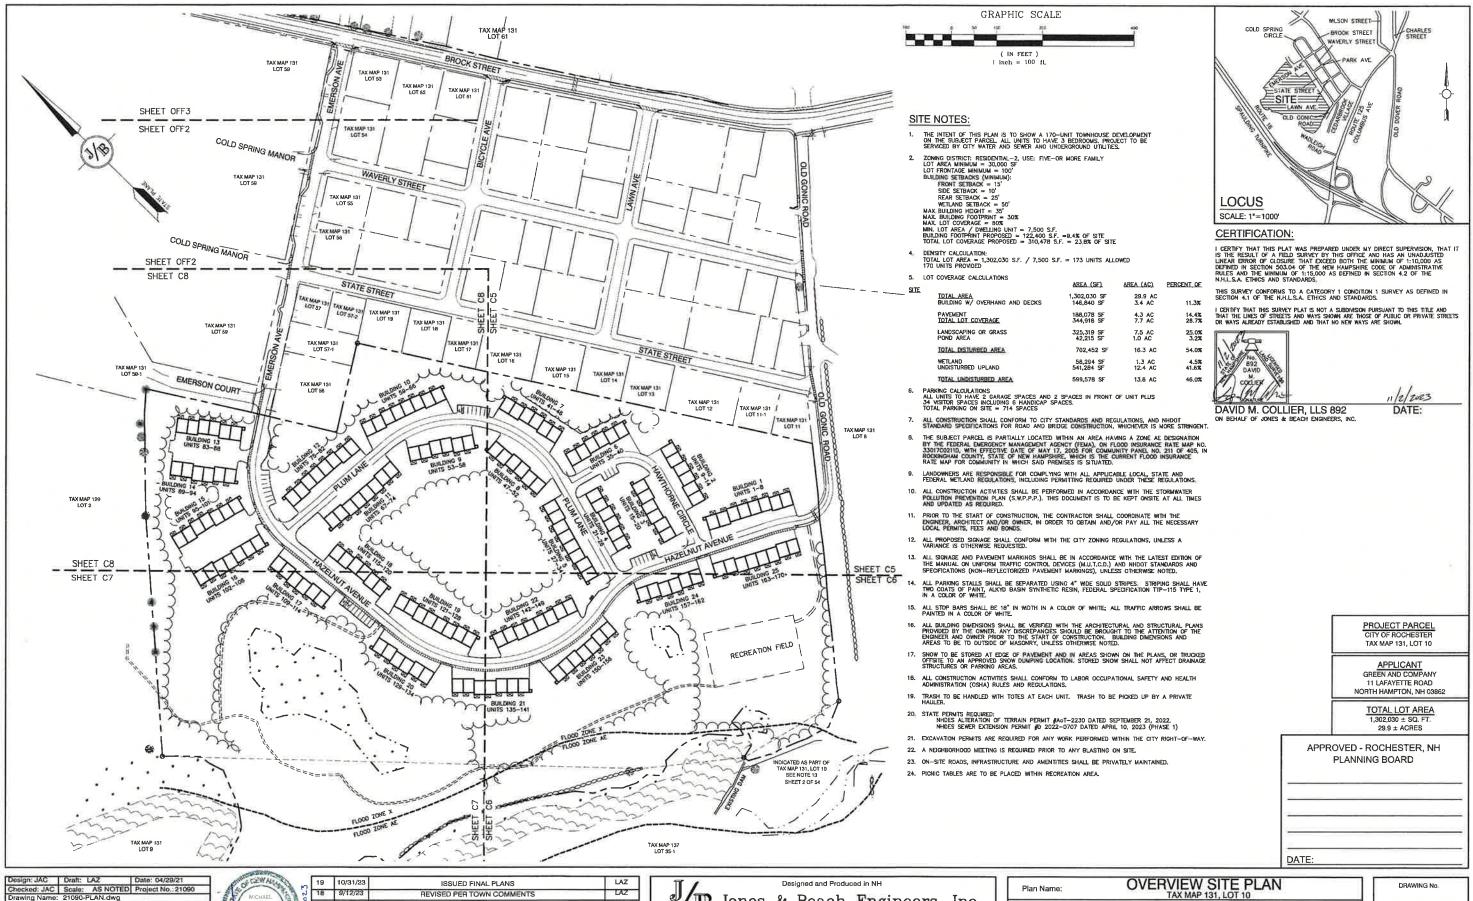
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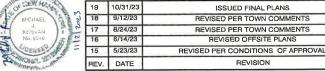
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Plan Name:	OVERVIEW SITE PLAN	
Project:	BAYBERRY COMMONS 19 OLD GONIC ROAD, ROCHESTER, NH	
Owner of Record:	LEO P. LACOUTURE REV. TRUST & WILLIAM B. LACOUTURE	

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SHEET 9 OF 54
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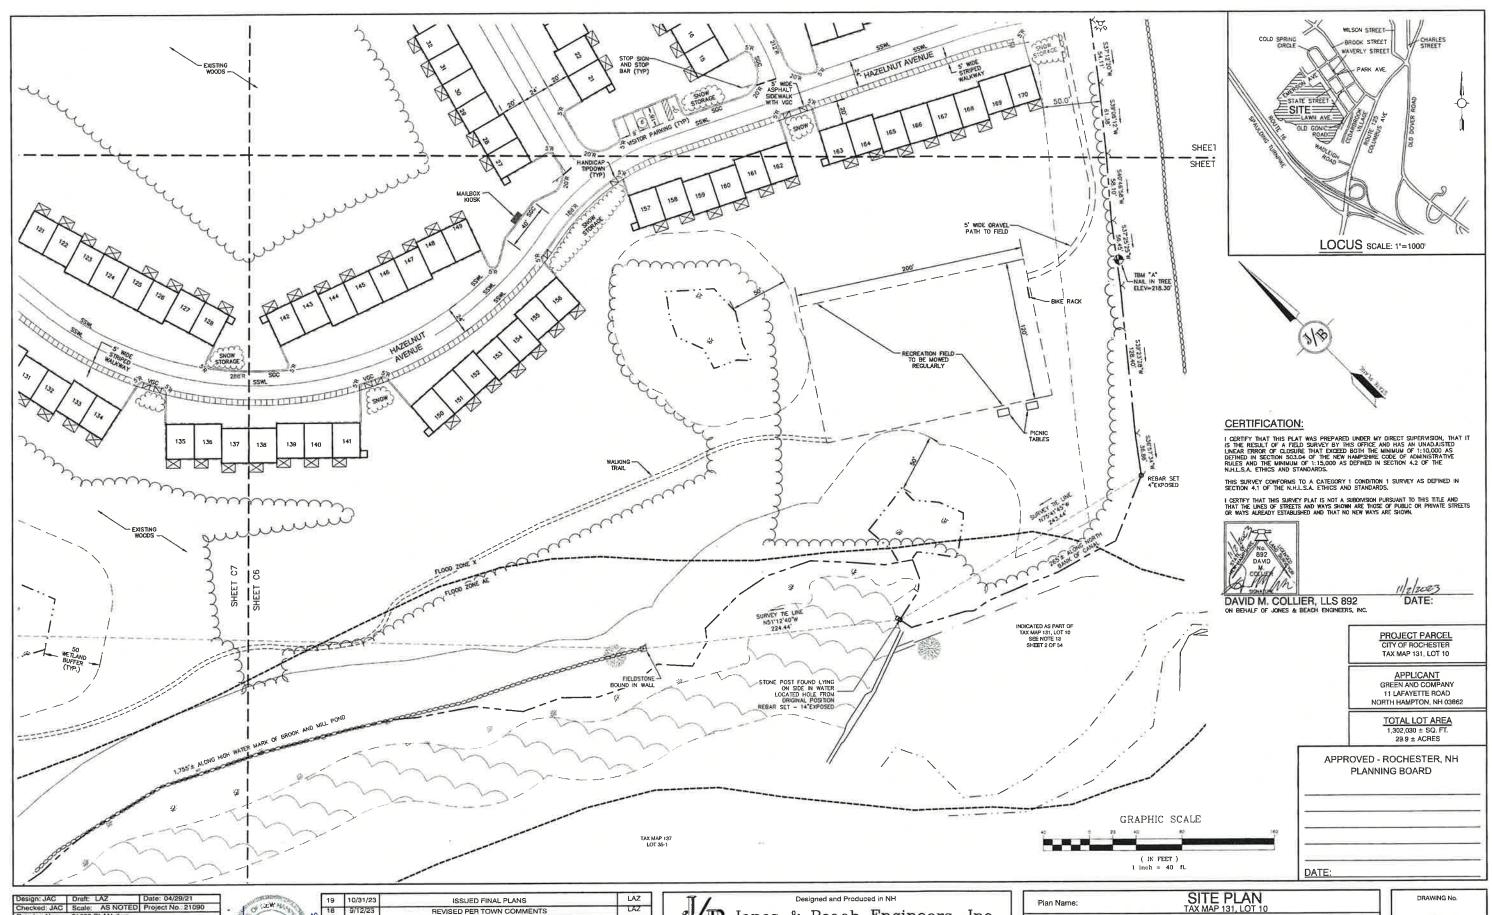
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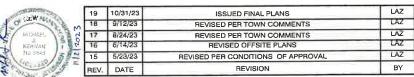
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	Plan Name:	TAX MAP 131, LOT 10	
	Project:	BAYBERRY COMMONS 19 OLD GONIC ROAD, ROCHESTER, NH	
	Owner of Record:	LEO P. LACOUTURE REV. TRUST & WILLIAM B. LACOUTURE 19 OLD GONIC RD., ROCHESTER, NH 03867 BK 4093 PG 148	

C5 SHEET 10 OF 54 JBE PROJECT NO. 21090



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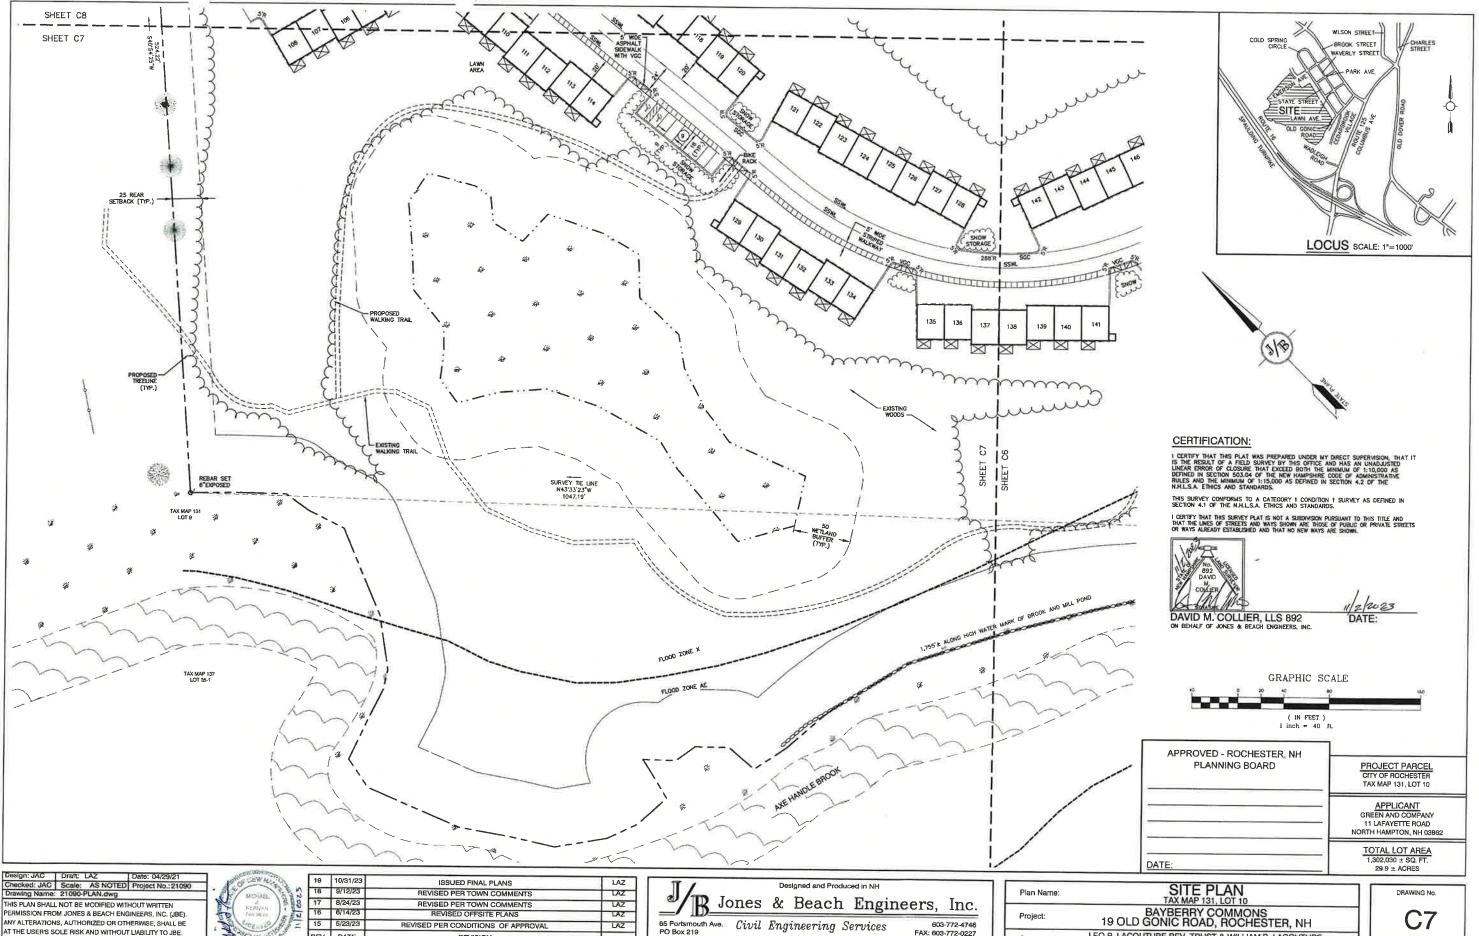

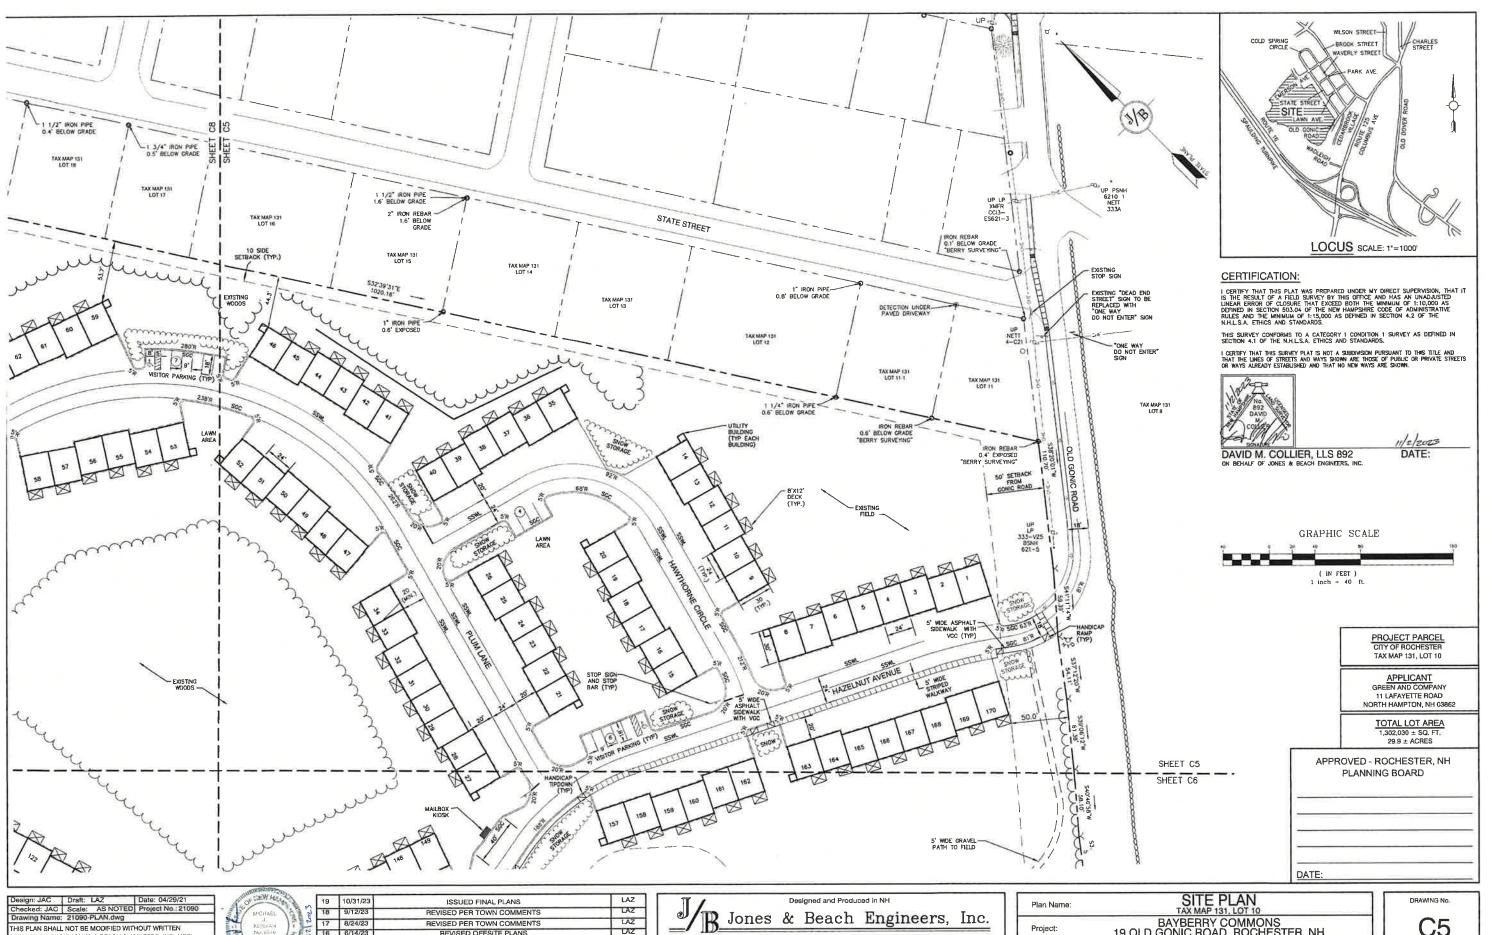
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E-MAIL: JBE@JONESANDBEACH.COM

ı	Plan Name:	TAX MAP 131, LOT 10	
	Project:	BAYBERRY COMMONS 19 OLD GONIC ROAD, ROCHESTER, NH	
١	Owner of Record:	LEO P. LACOUTURE REV. TRUST & WILLIAM B. LACOUTURE	

C6 SHEET 11 OF 54 JBE PROJECT NO. 21090



15 5/23/23 REVISED PER CONDITIONS OF APPROVAL REV. DATE


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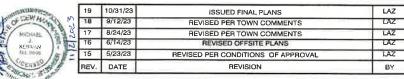
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Owner of Record: LEO P. LACOUTURE REV. TRUST & WILLIAM B. LACOUTURE 19 OLD GONIC RD., ROCHESTER, NH 03867 BK 4093 PG 148

SHEET 12 OF 54 JBE PROJECT NO. 21090



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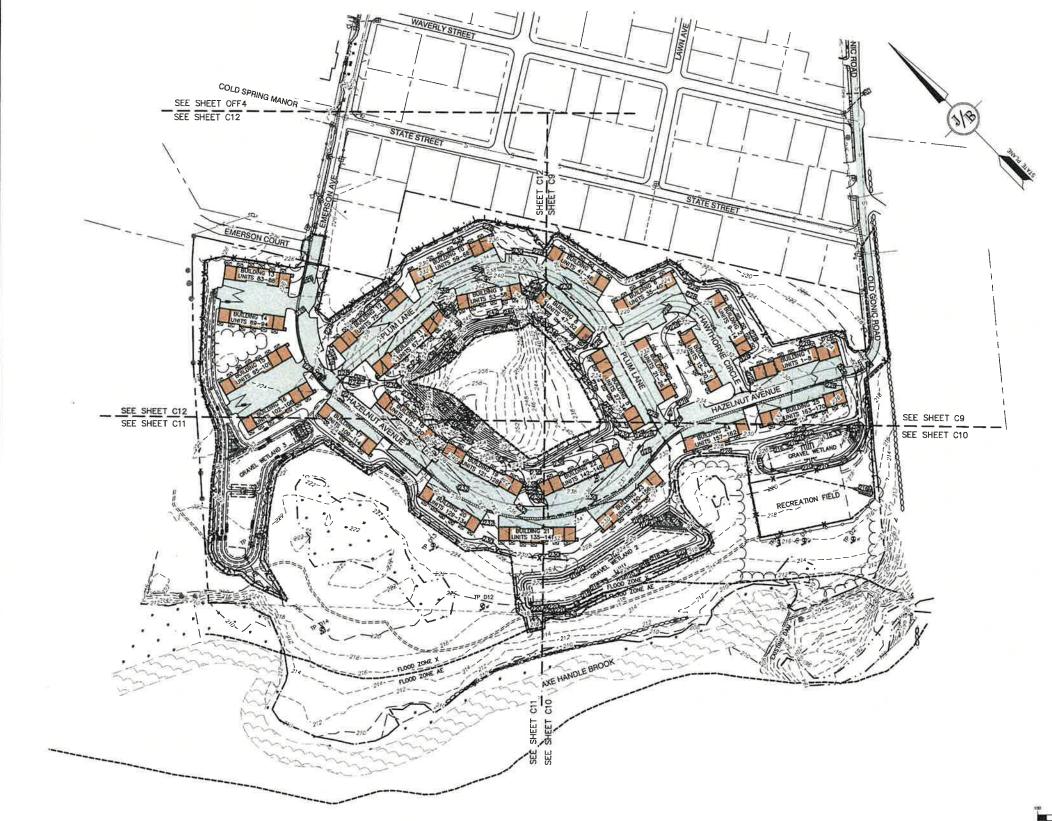


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BAYBERRY COMMONS 19 OLD GONIC ROAD, ROCHESTER, NH LEO P. LACOUTURE REV. TRUST & WILLIAM B, LACOUTURE 19 OLD GONIC RD., ROCHESTER, NH 03867 BK 4093 PG 148

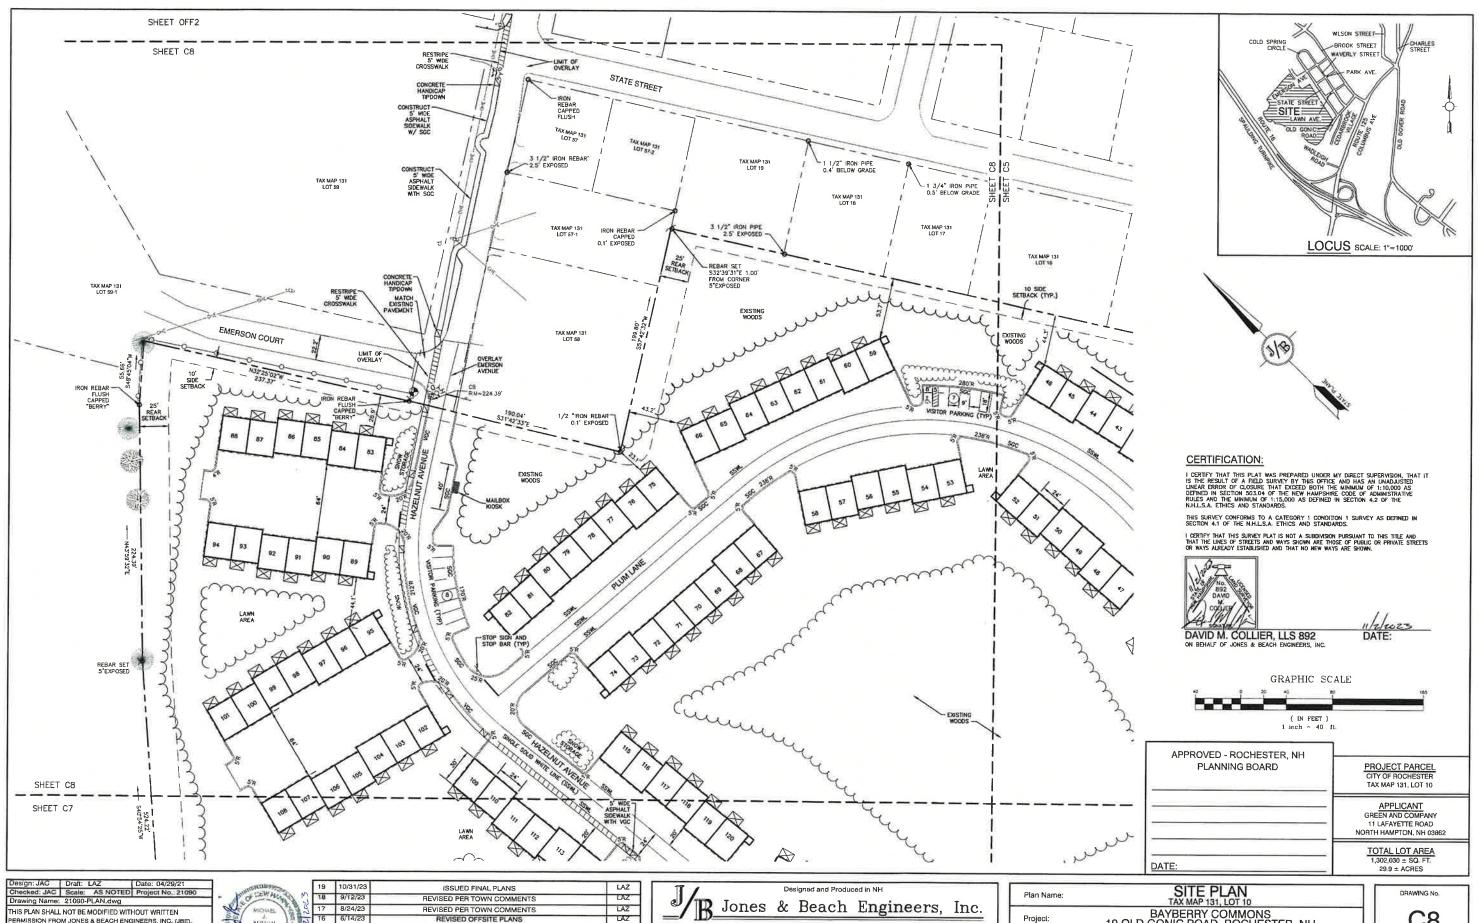Owner of Record:

C8 SHEET 13 OF 54 JBE PROJECT NO. 21090



GRADING AND DRAINAGE NOTES:

- THIS STE WILL REQUIRE A USEPA NPDES PERMIT FOR STORMWATER DISCHARGE FOR THE CONSTRUCTION SITE. THE CONSTRUCTION SITE OPERATOR SHALL DEVELOP AND IMPLEMENT A CONSTRUCTION SITE OF MATER POLIUTION PREVENTION PLAN (SWEPP), WHICH SHALL REMAIN ON SITE AND BE MADE ACCESSIBLE TO THE PUBLIC. THE CONSTRUCTION SITE OPERATOR SHALL SUBMIT A NOTICE OF INTENT (NO) TO THE EPA REGIONAL OFFICE SEVEN DAYS PRIOR TO COMMENCEMENT OF ANY WORK ON SITE EPA WILL POST THE NOT AN ATTEMPT OF THE NOTICE OF TERMINATION SITE AND ANY SHORT HE NOTICE OF TERMINATION SHALL BE SUBMITTED TO THE NOTICE STATUS OF THIS WESTELL A COMPLETED NOTICE OF TERMINATION SHALL BE SUBMITTED TO THE NOTICE STATUS OF THIS WESTELL A COMPLETED NOTICE OF TERMINATION SHALL BE SUBMITTED TO THE NOTICE STATUS OF THIS WESTELL A COMPLETED NOTICE OF TERMINATION SHALL BE SUBMITTED TO THE NOTICE STATUS OF THIS WESTELL A COMPLETED NOTICE OF TERMINATION SHALL BE SUBMITTED TO THE NOTICE STATUS OF THIS WESTELL A COMPLETED NOTICE OF TERMINATION SHALL BE SUBMITTED TO THE NOTICE STATUS OF THE SITE FOR WHICH THE PERMITTEE IS RESPONSED. FOR THE STATUS OF THE SITE FOR WHICH THE PERMITTEE IS BEEN ACCHIEVED AND ALL PORTIONS OF THE SITE FOR WHICH THE PERMITTEE IS BEEN ACCHIEVED AND ALL PORTIONS OF THE SITE FOR WHICH THE PERMITTEE IS

 - B. ANOTHER OPERATOR/PERMITTEE HAS ASSUMED CONTROL OVER ALL AREAS OF THE SITE THAT HAVE NOT BEEN FINALLY STABILIZED, PROVIDE DPW WITH A COPY OF THE NOTICE OF
- IF THIS CONSTRUCTION SITE IS NOT STABILIZED WITH PAVEMENT, A ROAD GRAVEL BASE, 85 % MATURE VECETATION COVER, OR RIPRAP BY OCTOBER 15, THEN THE SITE MUST BE PROTECTED WITH OVER-WINTER STABILIZATION. THE WINTER CONSTRUCTION PERIOD IS FROM OCTOBER 15 THROUGH MAY 15. WINTER EXCAVATION AND EARTHWORK ACTIVITIES SHALL BE LIMITED IN EXTENT AND DURATION, TO MINIMIZE POTENTIAL EROSION AND SEDIMENTATION IMPACTS.
- UNDERGROUND FACILITIES, UTILITIES AND STRUCTURES HAVE BEEN PLOTTED FROM FIELD OBSERVATION AND THEIR LOCATION MUST BE CONSIDERED APPROXIMATE ONLY, NEITHER JONES & BEACH ENGINEERS, NC., NOR ANY OF THEIR EMPLOYEES TAKE RESPONSIBILITY OF THE LOCATION OF ANY UNDERGROUND STRUCTURES AND/OR UTILITIES NOT SHOWN THAT MAY EXCEL IT IS THE RESPONSIBILITY OF THE CONTRACTOR TO HAVE ALL UNDERGROUND STRUCTURES AND/OR UTILITIES LOCATED PRIOR TO EXCAVATION WORK BY CALLING 508-010-5-385.
- 4. ALL BENCHMARKS AND TOPOGRAPHY SHOULD BE FIELD VERIFIED BY THE CONTRACTOR.
- 5 SITE GRADING SHALL NOT PROCEED UNTIL EROSION CONTROL MEASURES HAVE BEEN INSTALLED, SEE CONSTRUCTION SEQUENCE ON SHEET E1.
- PRIOR TO THE START OF CONSTRUCTION, THE CONTRACTOR IS REQUIRED TO HAVE THE PROJECT'S LAND SURVEYOR STAKE OR FLAG CLEARING LIMITS. A MINIMUM OF 48 HOURS NOTICE IS REQUIRED.
- 7. ALL SWALES AND DETENTION PONDS ARE TO BE STABILIZED PRIOR TO DIRECTING RUNOFF TO THEM.
- PROPOSED RIM ELEVATIONS OF DRAINAGE STRUCTURES ARE APPROXIMATE. FINAL ELEVATIONS ARE TO BE SET FLUSH WITH FINISH GRADES.
- ALL SWALES AND ANY SLOPES GREATER THAN 3:1 SHALL BE STABILIZED WITH NORTH AMERICAN GREEN 575
 EROSION CONTROL BLANKETS (OR AN EQUIVALENT APPROVED IN WRITING BY THE ENGINEER), UNLESS OTHERWISE
 SPECIFICIA.
- ALL DRAINAGE AND SANITARY STRUCTURE INTERIOR DIAMETERS (4" MIN) SHALL BE DETERMINED BY THE MANUFACTURER BASED ON THE PIPE CONFIGURATIONS SHOWN ON THESE PLANS. CATCH BASINS SHALL HAVE 3" DEEP SUMPS WITH GREASE HOODS, UNLESS OTHERWISE NOTED.
- 11. ALL DRAINAGE STRUCTURES SHALL BE PRECAST, UNLESS OTHERWISE SPECIFIED.
- 12. ALL DRAINAGE STRUCTURES AND STORM SEWER PIPES SHALL MEET HEAVY DUTY TRAFFIC H20 LOADING AND SHALL BE INSTALLED ACCORDINGLY.
- 13. THE CONTRACTOR SHALL INSTALL ORANGE CONSTRUCTION FENCING AND SNOW FENCE ALONG LIMIT OF WORK.
- 14. ALL DRAINAGE PIPE SHALL BE NON-PERFORATED ADS N-12 OR APPROVED EQUAL
- 15. STONE INLET PROTECTION SHALL BE PLACED AT ALL CATCH BASINS. SEE DETAIL WITHIN THE DETAIL SHEETS.
- 16. LAND DISTURBING ACTIVITIES SHALL NOT COMMENCE UNTIL APPROVAL TO DO SO HAS BEEN RECEIVED BY ALL GOVERNING AUTHORITIES. THE GENERAL CONTRACTOR SHALL STRICTLY ADHERE TO THE EPA SWPPP DURING CONSTRUCTION OPERATIONS.
- ALL EXPOSED AREAS SHALL BE SEEDED AS SPECIFIED WITHIN 3 DAYS OF FINAL GRADING AND ANYTIME CONSTRUCTION STOPS FOR LONGER THAN 3 DAYS.
- MAINTAIN EROSION CONTROL MEASURES AFTER EACH RAIN EVENT OF 0.5" OR GREATER IN A 24 HOUR PERIOD AND AT LEAST ONCE A WEEK.
- 19. THIS PLAN SHALL NOT BE CONSIDERED ALL INCLUSIVE, AS THE GENERAL CONTRACTOR SHALL TAKE ALL NECESSARY PRECAUTIONS TO PREVENT SEDIMENT FROM LEAVING THE SITE.
- 20. CONSTRUCTION VEHICLES SHALL UTILIZE THE STABILIZED CONSTRUCTION ENTRANCE TO THE EXTENT POSSIBLE THROUGHOUT CONSTRUCTION
- IF INSTALLATION OF STORM DRAINAGE SYSTEM SHOULD BE INTERRUPTED BY WEATHER OR NIGHTFALL, THE PIPE ENDS SHALL BE COVERED WITH FILTER FABRIC.
- 22. THE GENERAL CONTRACTOR SHALL BE RESPONSIBLE TO TAKE WHATEVER MEANS NECESSARY TO ESTABLISH PERMANENT SOIL STABILIZATION.
- 23. SEDIMENT SHALL BE REMOVED FROM ALL SEDIMENT BASINS BEFORE THEY ARE 25% FULL
- 24. ALL WORK SHALL BE DONE IN STRICT ACCORDANCE WITH PROJECT SPECIFICATIONS.
- Additional erosion and sediment control measures shall be installed, if deemed necessary by on—site inspection by engineer and/or regulatory officials.
- 26. SEE ALSO EROSION AND SEDIMENT CONTROL SPECIFICATIONS ON SHEET E1.
- 27. PRIOR TO CLEARING OR GRADING DISTURBANCE, THE CONTRACTOR SHALL IDENTIFY ALL AREAS OF TYPE 2 INVASIVE SPECIES AS DEFINED BY INHOIT AND ADHERE TO THE PRACTICES OUTLINED IN BEST MANAGEMENT PRACTICES FOR THE CONTROL OF INVASIVE AND MORGOUS PLANT SPECIES. INHOIT 2018. THESE PRACTICES SHALL BE FOLLOWED FOR THE ENTIRE CONSTRUCTION TERM INCLUDING ESTABLISHMENT OF LANDSCAPING. AS THE STEER EXPECTATES AFTER CONSTRUCTION TERM INCLUDING ESTABLISHMENT OF LANDSCAPING IN THE STEER EXPECTATES AFTER CONSTRUCTION, LANDSCAPING CONTRACTOR TO INFORM THE ATM INVASIVE SPECIES START TO, GROW. OWNER SHALL CONTACT A QUALIFIED REMOVAL COMPANY AND FOLLOW INDESSETS MANAGEMENT PRACTICES.
- 28. WETLAND BUFFERS SHALL BE MARKED WITH CONSTRUCTION TAPE MARKERS PLACED ON TREES OR ON WOODEN STAKES PRIOR TO ANY ONSITE ACTIVITY AND SHALL BE MAINTAINTED THOROUGHOUT CONSTRUCTION, WETLAND BUFFERS SHALL BE MARKED WITH CONSERVATION OVERLAY DISTRICT TAGES PRIOR TO ISSUANCE OF CERTIFICATE OF OCCUPANCY.

TAX MAP 131, LOT 10

GREEN AND COMPANY 11 LAFAYETTE ROAD NORTH HAMPTON, NH 03862

> TOTAL LOT AREA 29.9 ACRES ±

(IN FEET) 1 inch = 100 ft Design: JAC | Draft: LAZ | Date: 04/29/21 Checked: JAC | Scale: AS NOTED | Project No.: 21090

	Drawing Name: 21090-PLAN.dwg
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19	10/31/23	ISSUED FINAL PLANS	LAZ
18	9/12/23	REVISED PER TOWN COMMENTS	LAZ
17	8/24/23	REVISED PER TOWN COMMENTS	LAZ
16	6/14/23	REVISED OFFSITE PLANS	LAZ
15	5/23/23	REVISED PER CONDITIONS OF APPROVAL	LAZ
REV.	DATE	REVISION	BY


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FAX: 603-772-0227 E-MAIL: JBE@JONESANDBEACH.COM


П	Plan Name:	OVERVIEW GRADING PLAN	
П	Project:	BAYBERRY COMMONS 19 OLD GONIC ROAD, ROCHESTER, NH	
	Owner of Record:	LEO P. LACOUTURE REV. TRUST & WILLIAM B. LACOUTURE 19 OLD GONIC RD., ROCHESTER, NH 03867 BK 4093 PG 148	

GRAPHIC SCALE



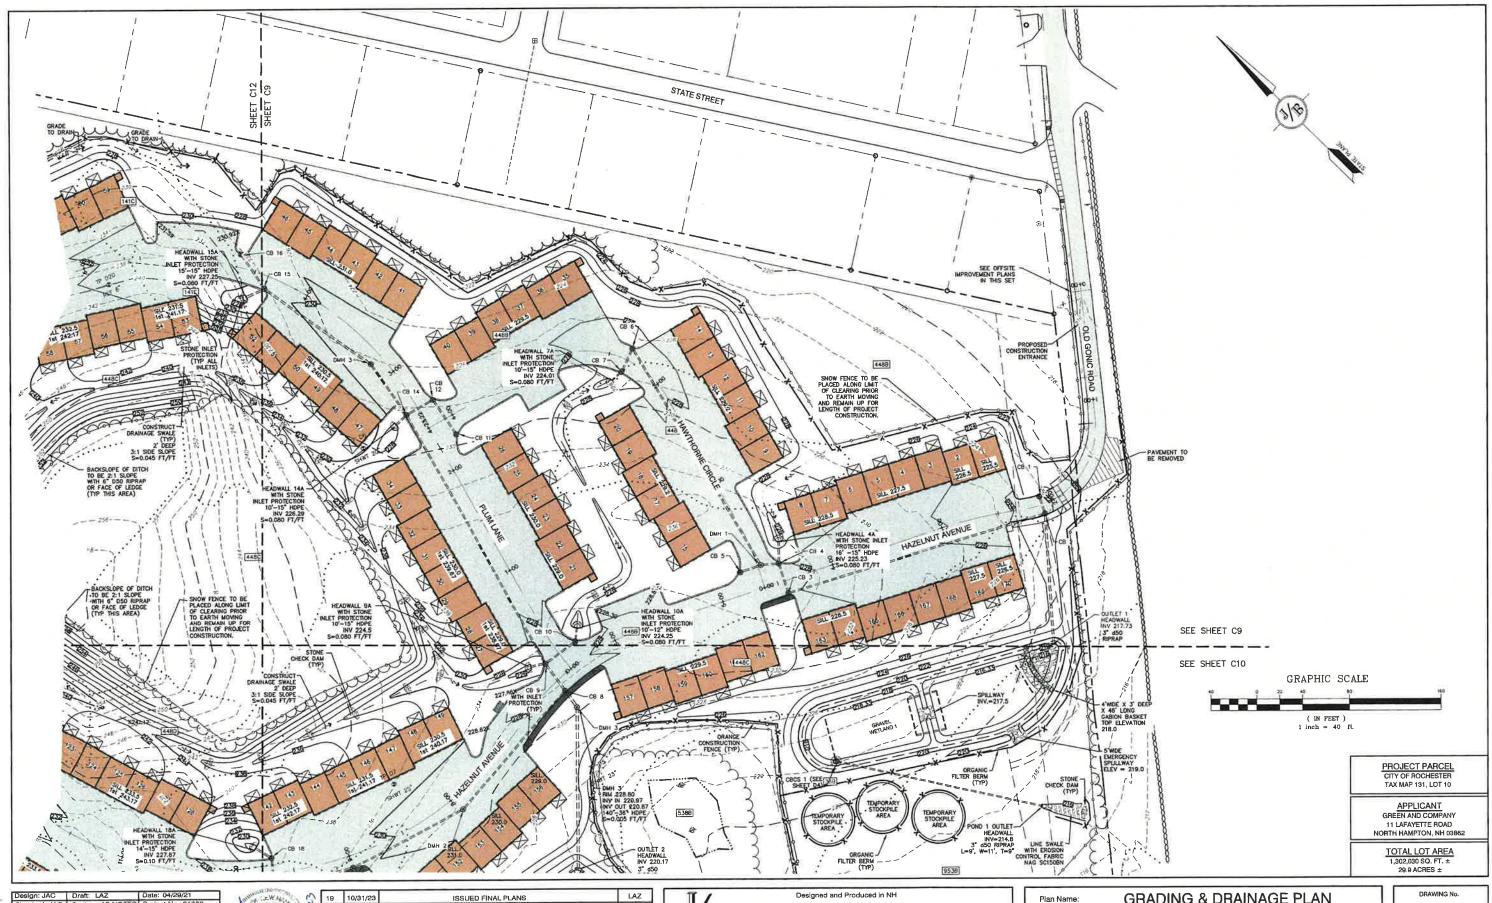

Design: JAC Draft: LAZ Date: 04/29/21
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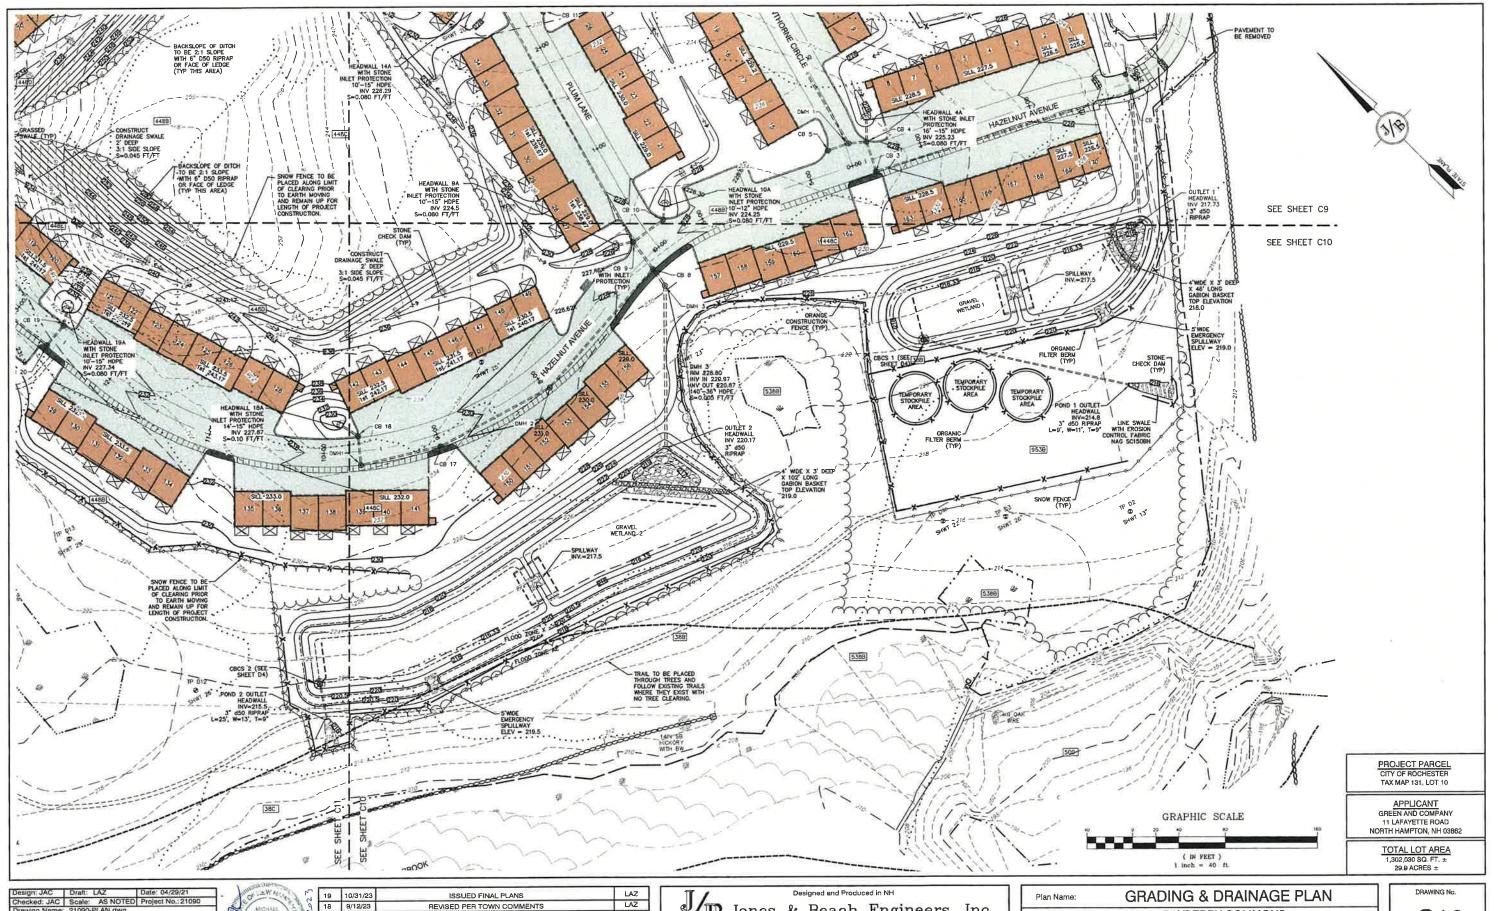

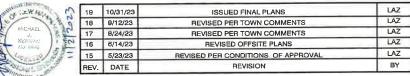
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Plan Name:	GRADING & DRAINAGE PLAN
Project:	BAYBERRY COMMONS 19 OLD GONIC ROAD, ROCHESTER, NH
Owner of Record:	LEO P. LACOUTURE REV. TRUST & WILLIAM B. LACOUTURE 19 OLD GONIC RD., ROCHESTER, NH 03867 BK 4093 PG 148

DRAWING No.

C9
SHEET 15 OF 55
JBE PROJECT NO. 21090



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P PE June	18	9/12/23	REVISED PER TOWN COMMENTS	LAZ
13 10	17	8/24/23	REVISED PER TOWN COMMENTS	LAZ
	16	6/14/23	REVISED OFFSITE PLANS	LAZ
En 18 / 18 =	15	5/23/23	REVISED PER CONDITIONS OF APPROVAL	LAZ
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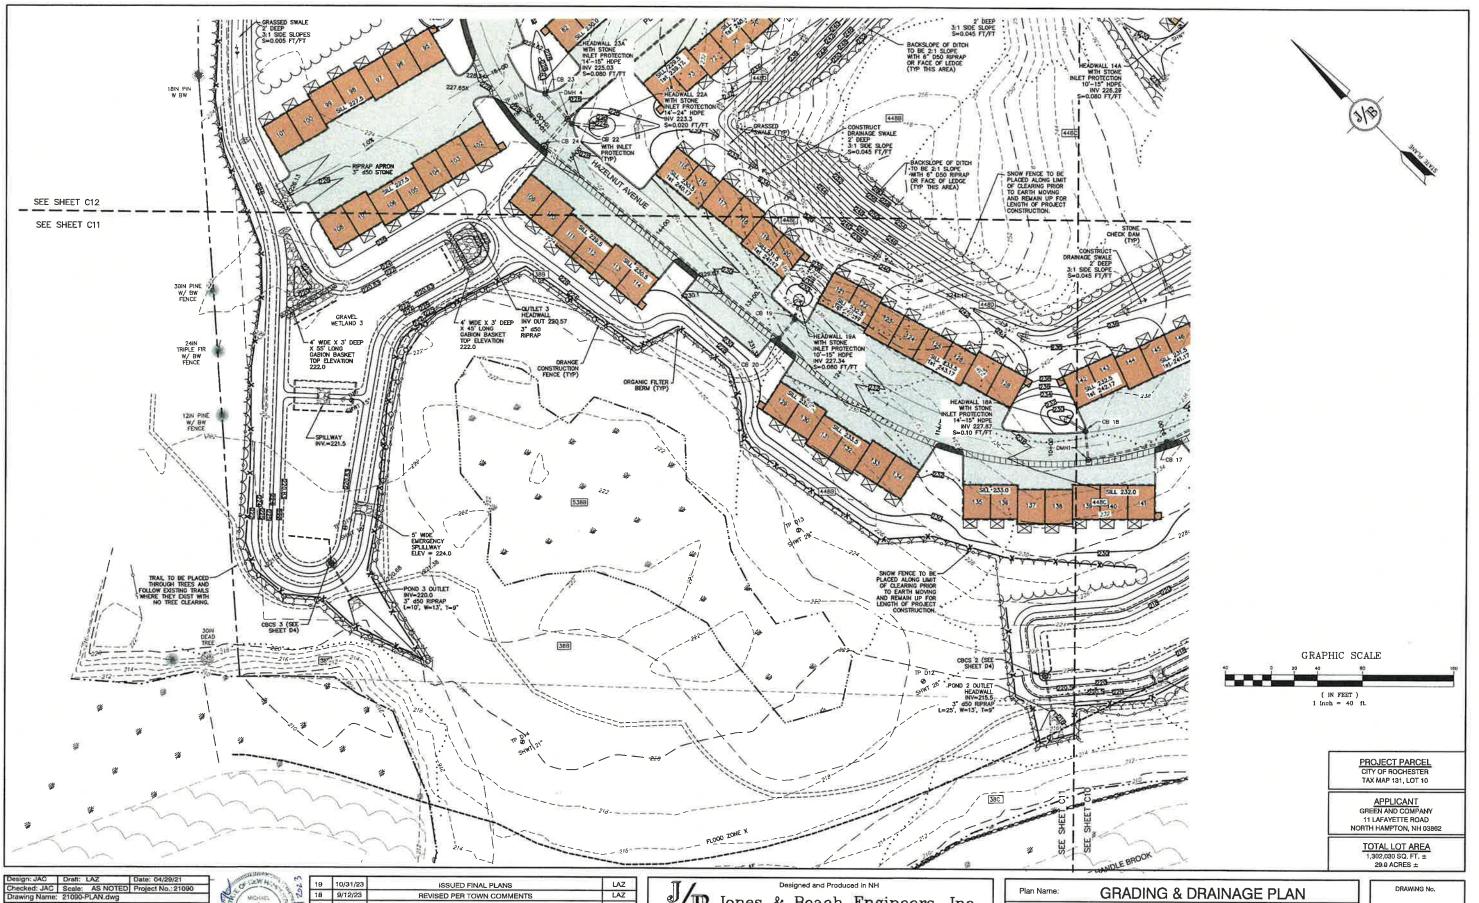
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Strathem, NH 03885

Civil Engineering Services

E-MAIL: JBE@JOI

BAYBERRY COMMONS 19 OLD GONIC ROAD, ROCHESTER, NH Project: LEO P. LACOUTURE REV. TRUST & WILLIAM B. LACOUTURE 19 OLD GONIC RD., ROCHESTER, NH 03867 BK 4093 PG 148

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17	8/24/23	REVISED PER TOWN COMMENTS	LAZ
16	6/14/23	REVISED OFFSITE PLANS	LÁZ
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REV.	DATE	REVISION	BY

Book and Produced in NH

Book Beach Engineers, Inc.

Book Engineers, Engineer

Plan Name: GRADING & DRAINAGE PLAN

Project: BAYBERRY COMMONS
19 OLD GONIC ROAD, ROCHESTER, NH


Owner of Record: LEO P. LACOUTURE REV. TRUST & WILLIAM B. LACOUTURE
19 OLD GONIC RD., ROCHESTER, NH 03867 BK 4093 PG 148

DRAWING No.


C11

SHEET 17 OF 55

JBE PROJECT NO. 21090

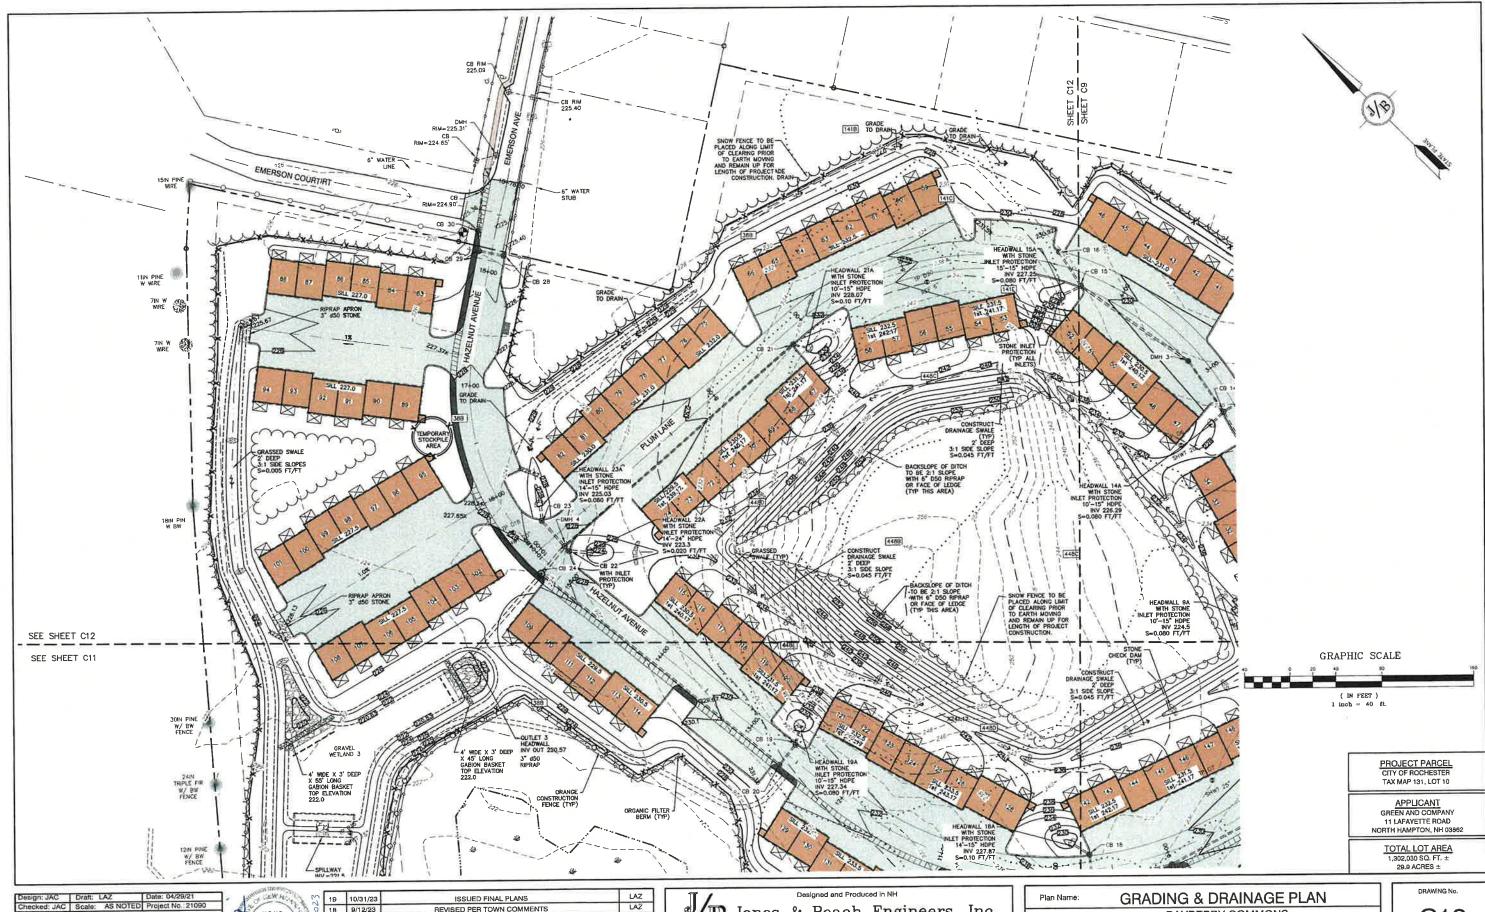


Design: JAC Draft: LAZ Date: 04/29/21 Checked: JAC Scale: AS NOTED Project No. 21090 Drawing Name: 21090-PLAN.dwg THIS PLAN SHALL NOT BE MODIFIED WITHOUT WRITTEN PERMISSION FROM JONES & BEACH ENGINEERS, INC. (JBE). ANY ALTERATIONS, AUTHORIZED OR OTHERWISE, SHALL BE AT THE USER'S SOLE RISK AND WITHOUT LIABILITY TO JBE.

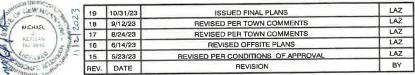


B Jones & Beach Engineers, Inc. Services 603-772-4746 FAX: 603-772-0227 E-MAIL: JBE@JONESANDBEACH.COM B5 Portsmouth Ave. Civil Engineering Services
PO Box 219
Stratham, NH 03885

BAYBERRY COMMONS 19 OLD GONIC ROAD, ROCHESTER, NH Project: Owner of Record: LEO P. LACOUTURE REV. TRUST & WILLIAM B. LACOUTURE 19 OLD GONIC RD., ROCHESTER, NH 03867 BK 4093 PG 148

C12 SHEET 18 OF 55 JBE PROJECT NO: 21090

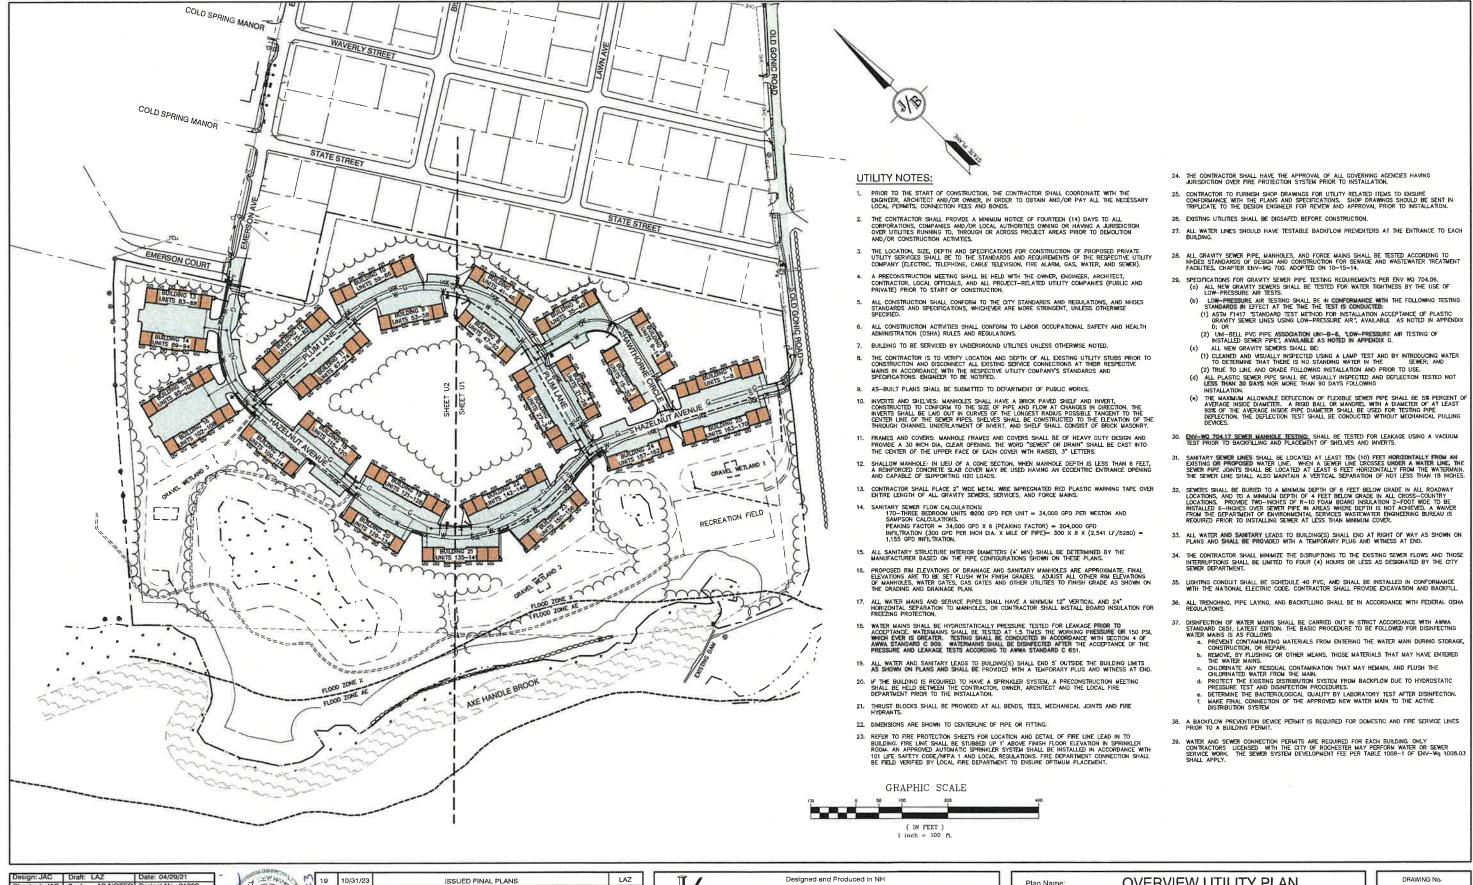

Design: JAC Draft: LAZ Date: 04/29/21
Chocked: JAC Scale: AS NOTED Project No.: 21090
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FAX: 603-772-0227
E-MAIL: JBE@JONESANDBEACH.COM

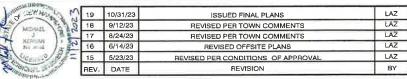Plan Name: OVERVIEW UTILITY PLAN

Project: BAYBERRY COMMONS
19 OLD GONIC ROAD, ROCHESTER, NH

Owner of Record: LEO P. LACOUTURE REV. TRUST & WILLIAM B. LACOUTURE
19 OLD GONIC RD., ROCHESTER, NH 03867 BK 4093 PG 148

OVRU
SHEET 19 OF 55
JBE PROJECT NO. 21090



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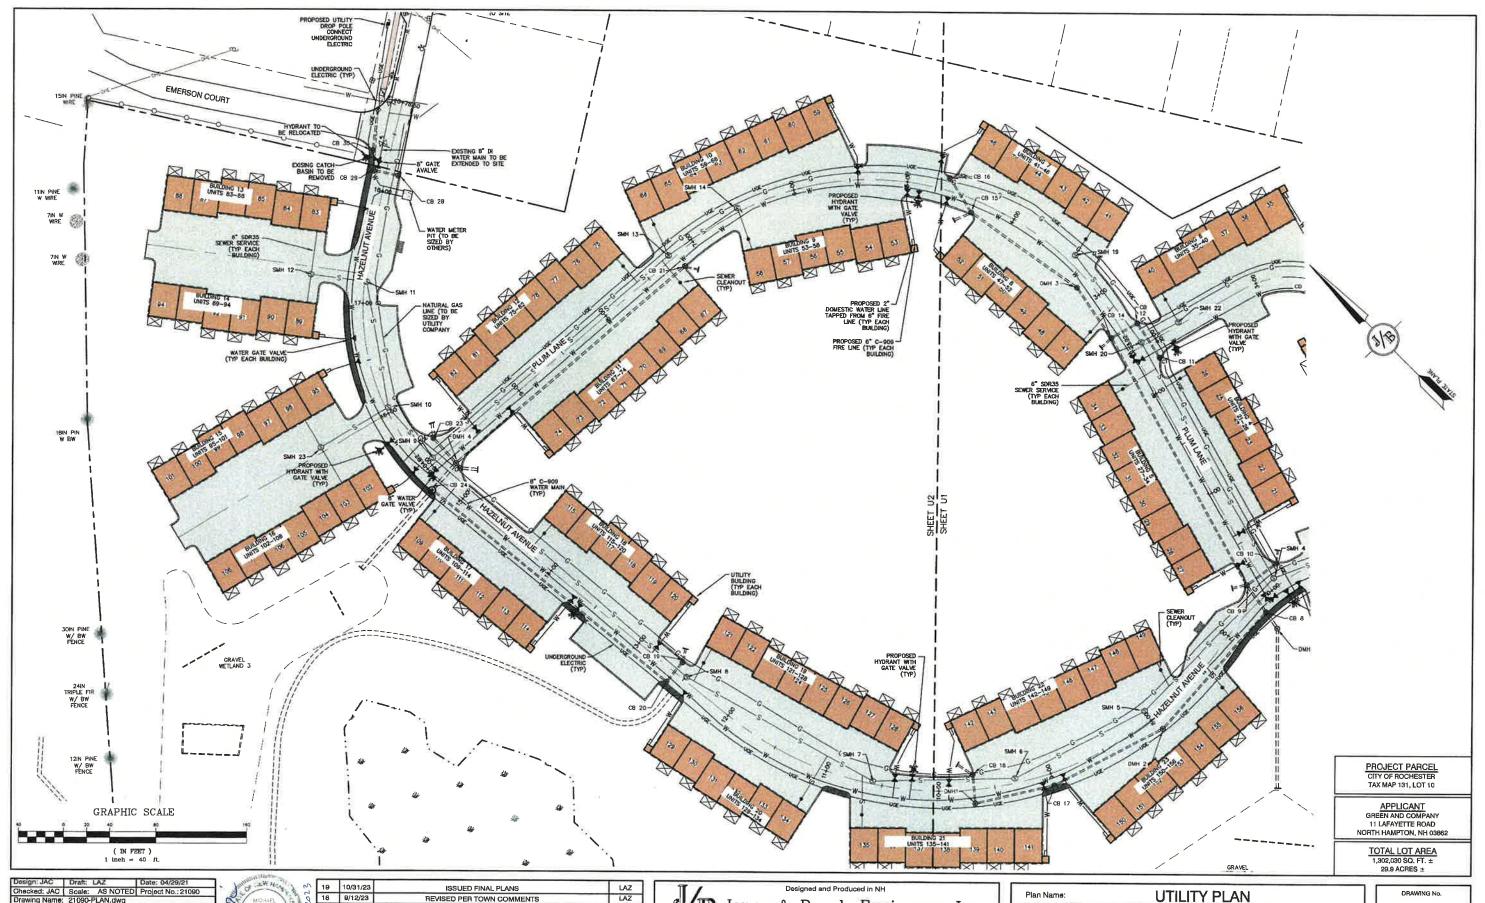


19	10/31/23	ISSUED FINAL PLANS	LAZ
18	9/12/23	REVISED PER TOWN COMMENTS	LAZ
17	8/24/23	REVISED PER TOWN COMMENTS	LAZ
16	6/14/23	REVISED OFFSITE PLANS	LAZ
15	5/23/23	REVISED PER CONDITIONS OF APPROVAL	LAZ
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PO Box 218
Stratham, NH 03885
E-MAIL: JBE@.

Plan Name:	UTILITY PLAN
Project:	BAYBERRY COMMONS 19 OLD GONIC ROAD, ROCHESTER, NH
Owner of Record:	LEO P. LACOUTURE REV. TRUST & WILLIAM B. LACOUTURE 19 OLD GONIC RD., ROCHESTER, NH 03867 BK 4093 PG 148



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PO Box 219
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FAX: 603-772-0227
E-MAIL: JBE@JONESANDBEACH.COM

Plan Name:	UTILITY PLAN
Project:	BAYBERRY COMMONS 19 OLD GONIC ROAD, ROCHESTER, NH
Owner of Record:	LEO P. LACOUTURE REV. TRUST & WILLIAM B. LACOUTURE 19 OLD GONIC RD., ROCHESTER, NH 03867 BK 4093 PG 148

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Strathem, NH 03885

E-MAIL: JBE@JONESANDBEACH.COM


	Plan Name:	LANDSCAPE PLAN
	Project:	BAYBERRY COMMONS 19 OLD GONIC ROAD, ROCHESTER, NH
ı	Owner of Record:	LEO P. LACOUTURE REV. TRUST & WILLIAM B. LACOUTURE

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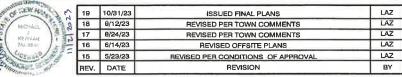
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SHEET 22 OF 55

JBE PROJECT NO. 21080



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Beach Engineers, Inc.

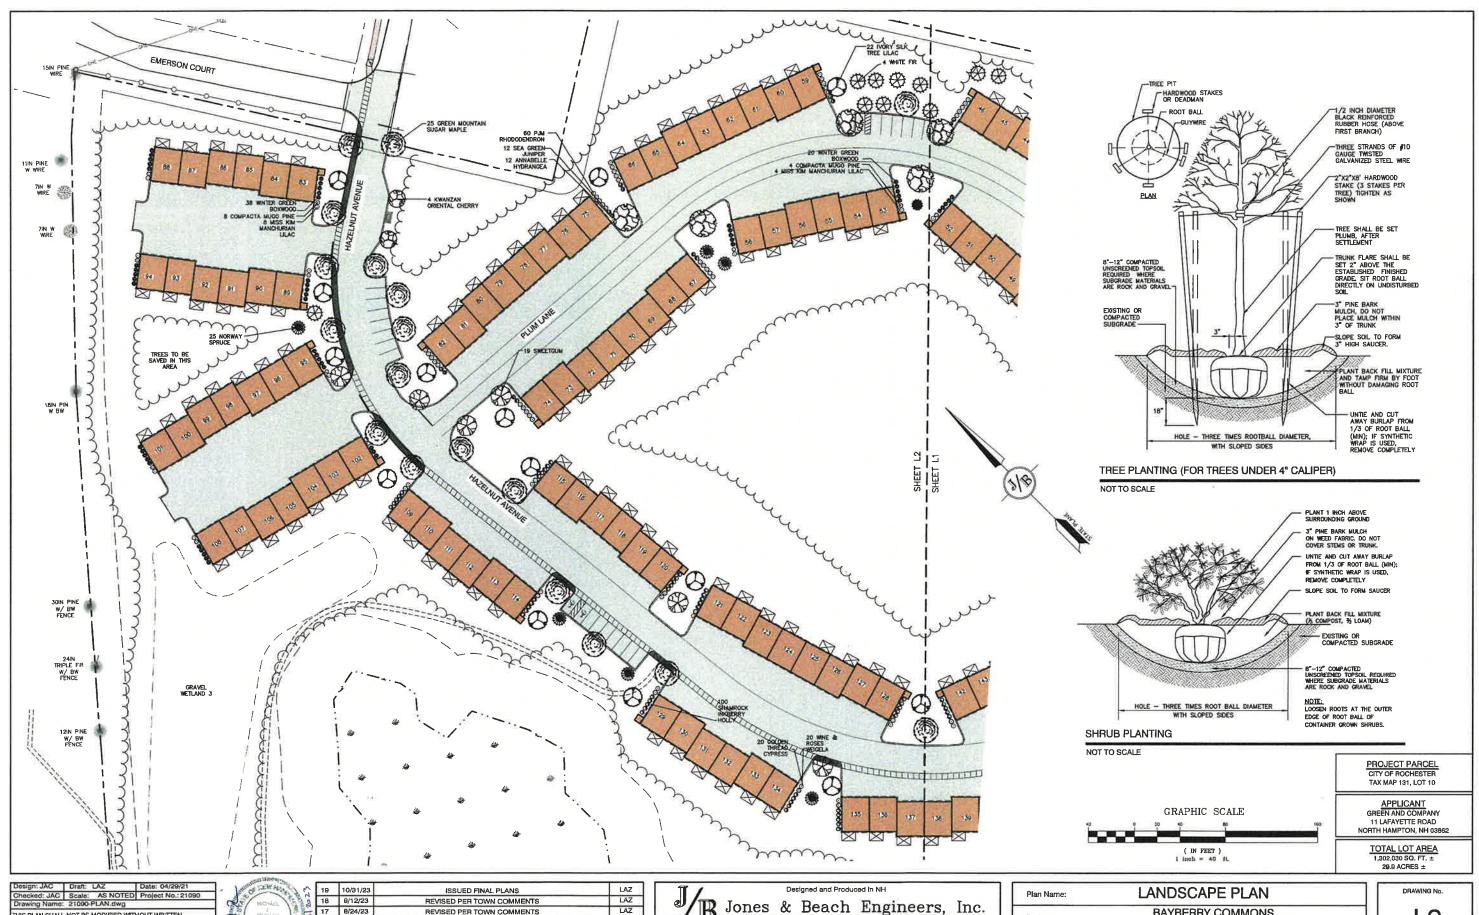SS Portsmouth Ave. PO Box 219 Stratham, NH 03885

Designed and Produced in NH

Reach Engineers, Inc.

Services FAX: 603-772-4748

E-MAIL: JBE@JONESANDBEACH.COM

	Plan Name:	LANDSCAPE PLAN
l	Project:	BAYBERRY COMMONS 19 OLD GONIC ROAD, ROCHESTER, NH
	Owner of Record:	LEO P. LACOUTURE REV. TRUST & WILLIAM B. LACOUTURE 19 OLD GONIC RD., ROCHESTER, NH 03867 BK 4093 PG 148

DRAWING No.

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SHEET 23 OF 55

JBE PROJECT NO. 21090



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15	5/23/23	REVISED PER CONDITIONS OF APPROVAL	LAZ
REV.	DATE	REVISION	BY


B Jones & Beach Engineers, Inc.

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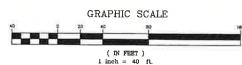
Plan Name:	LIGHTING PLAN
Project:	BAYBERRY COMMONS 19 OLD GONIC ROAD, ROCHESTER, NH
Owner of Record:	LEO P. LACOUTURE REV. TRUST & WILLIAM B. LACOUTURE 19 OLD GONIC RD., ROCHESTER, NH 03867 BK 4093 PG 148

L3 SHEET 24 OF 55 JBE PROJECT NO. 21090





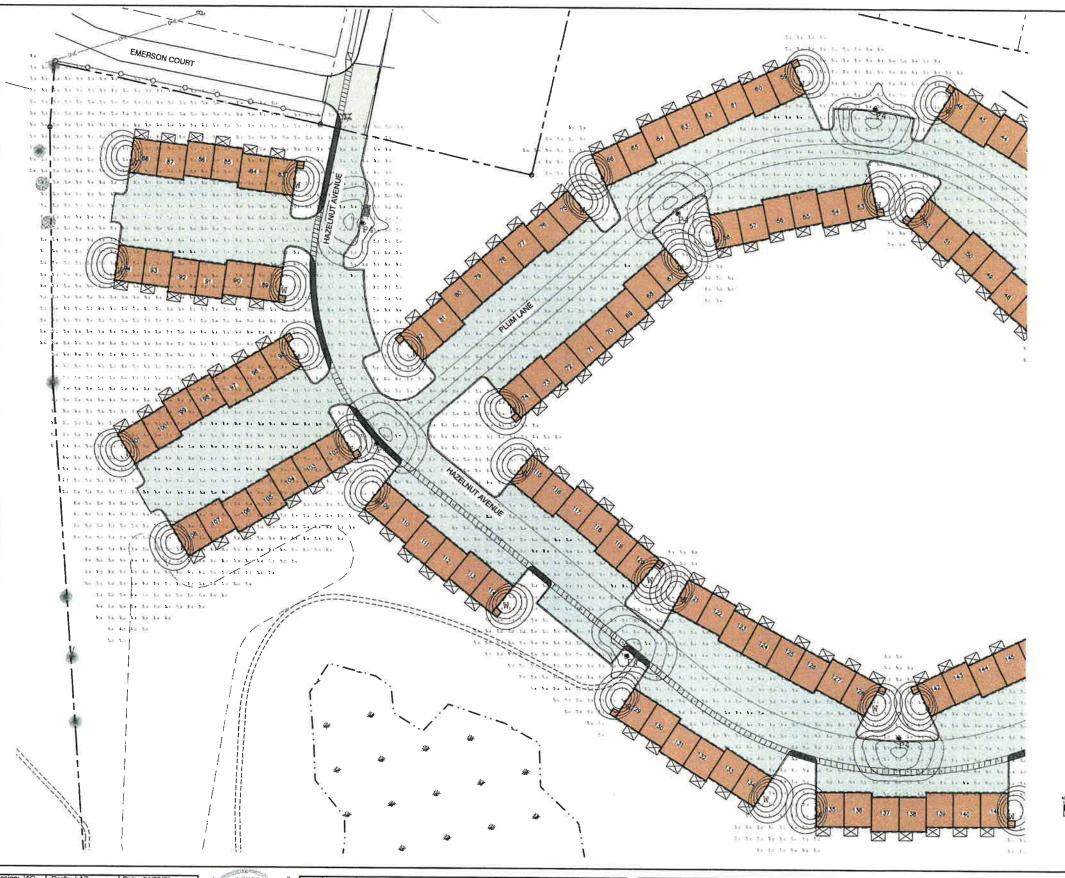



PROJECT PARCEL CITY OF ROCHESTER TAX MAP 131, LOT 10

APPLICANT GREEN AND COMPANY 11 LAFAYETTE ROAD NORTH HAMPTON, NH 03862

> TOTAL LOT AREA 1,302,030 SQ. FT. ± 29.9 ACRES ±

Design: JAC		Date: 04/29/21
Checked: JAC	Scale: AS NOTED	Project No.: 21090
Drawing Name:	21090-PLAN.dwg	

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16	6/14/23	REVISED OFFSITE PLANS	LAZ
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REV.	DATE	REVISION	BY


Plan Name:	LIGHTING PLAN	
	Project:	BAYBERRY COMMONS 19 OLD GONIC ROAD, ROCHESTER, NH

Owner of Record: LEO P. LACOUTURE REV. TRUST & WILLIAM B. LACOUTURE 19 OLD GONIC RD., ROCHESTER, NH 03867 BK 4093 PG 148

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SHEET 25 OF 55

JBE PROJECT NO. 21090

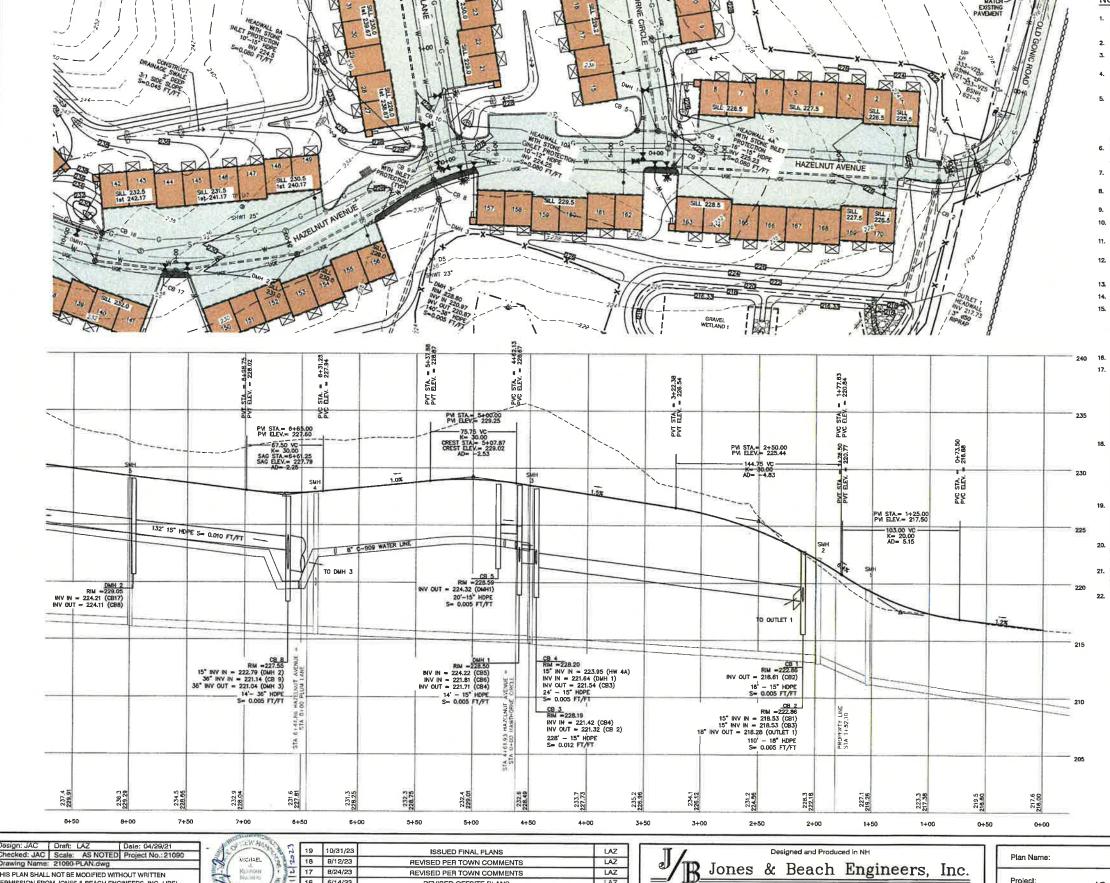

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LAZ

BY

PO Box 219 Stratham, NH 03885

85 Portsmouth Ave. Civil Engineering Services

FAX: 603-772-0227

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REVISED PER TOWN COMMENTS

REVISED OFFSITE PLANS

REVISED PER CONDITIONS OF APPROVA

REVISION

16 6/14/23

15 5/23/23

REV. DATE

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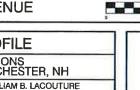
NY ALTERATIONS, AUTHORIZED OR OTHERWISE, SHALL BE

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NOTES:

- ALL ROAD AND DRAINAGE WORK SHALL BE CONSTRUCTED IN ACCORDANCE WITH THE STANDARD SPECIFICATION FOR THE CITY, AND NHDOT SPECIFICATIONS FOR ROAD AND BRIDGE CONSTRUCTION, WHICHEVER IS MORE
- 2. AS-BUILT PLANS TO BE SUBMITTED TO THE CITY PRIOR TO ACCEPTANCE OF THE ROADWAY
- DEVELOPER IS RESPONSIBLE FOR COMPLYING WITH ALL APPLICABLE LOCAL, STATE AND FEDERAL WETLAND REGULATIONS, INCLUDING ANY PERMITTING AND SETBACK REQUIREMENTS REQUIRED UNDER THESE REGULATIONS
- THIS PLAN HAS BEEN PREPARED BY JONES & BEACH ENGINEERS, INC. FOR MUNICIPAL AND STATE APPROVALS AND FOR CONSTRUCTION BASED ON DATA OBTAINED FROM ON-SITE FIELD SURVEY AND EXISTING MUNICIPAL RECORDS. THROUGHOUT THE CONSTRUCTION PROCESS, THE CONTRACTOR SHALL BIFORM THE BIGHER MANEDIATELY OF ANY FIELD DISCREPANCY FROM DATA SHOWN ON THE DESIGN PLANS. THIS INCLIDES ANY UNFORESEE OHORITORS, SUBSIGREACE OF OTHERWISE, FOR EVALUATION AND RECOMMENDATIONS. ANY CONTRADICTION BETWEEN ITEMS OF THIS PLAN/PLAN SET, OR BETWEEN THE PLANS AND ON-SITE CONDITIONS MUST BE RESOLVED BEFORE RELATED CONSTRUCTION HAS BEEN INITIATED.
- SITATION AND EROSION CONTROLS SHALL BE INSTALLED PRIOR TO CONSTRUCTION, SHALL BE MAINTAINED DURNOS CONSTRUCTION, AND SHALL REMAIN UNTIL SITE HAS BEEN STABILIZED WITH PERMANENT VEGETATION SEE DETAIL SHEET ET FOR ADDITIONAL NOTES ON PROSON CONTROL.
- ALL DISTURBED AREAS NOT STABILIZED BY NOVEMBER 1st SHALL BE COVERED WITH AN EROSION CONTROL BLANKET. PRODUCT TO BE SPECIFIED BY THE ENGINEER.
- FINAL DRAINAGE, GRADING AND EROSION PROTECTION MEASURES SHALL CONFORM TO REGULATIONS OF THE PUBLIC WORKS DEPARTMENT.
- 9. CONTRACTOR TO VERIFY EXISTING UTILITIES AND TO NOTIFY ENGINEER OF ANY DISCREPANCY IMMEDIATELY.
- ROADWAY INTERSECTIONS WITH SLOPE GRANITE CURB SHALL EXTEND AROUND RADIUS WITH 6' STRAIGHT PIECE ALONG TANGENT.
- 12. 6" PERFORATED ADS UNDER DRAIN PLACEMENT TO BE DETERMINED BY THE ENGINEER DURING TIME OF SUBGRADE INSPECTION. CONTRACTOR TO ADJUST LOCATION IN THE FIELD ONLY WITH PRIOR APPROVAL OF PROJECT LEGISLEER OF PUBLIC WORKS DEPARTMENT.
- 13. ALL DRIVEWAYS TO BE CONSTRUCTED MAXIMUM 10% SLOPE. SEE DETAIL SHEET.
- 14. SIDEWALK TO BE INSTALLED AT TIME OF TOP COURSE PAYING ALONG WITH DRIVEWAY APRONS.
- DRAINAGE INSPECTION AND MAINTENANCE SCHEDULE: SILT FENCING WILL BE INSPECTED DURING AND AFTER STORM EVENTS TO DESURE THAT THE FENCE STILL HAS INTEGRITY AND IS NOT ALLOWING SEDMENT TO PASS. SEDIMENT BUILD UP IN SWALES WILL BE REMOVED IF IT IS DEEPER THAN SX INCHES, AND IS TO BE REMOVED FROM SUMPS BELOW THE INLET OF CULVERTS SEMIANDUALLY, AS WELL AS FROM CATCH BASINS, FOLLOWING MAJOR, STORM EVENTS, THE STAGE DISCHARGE CULLET STRUCTURES ARE TO BE INSPECTED AND ANY DEBMIS REMOVED FROM THE ORIFICE, TRACH TRACK AND EMERGENCY SPILL WAY, INFREQUENTLY, SEDMENT MAY ALSO HAVE TO BE REMOVED FROM THE SUMP OF THE STRUCTURE.
- 18. ALL DRAINAGE INFRASTRUCTURE SHALL BE INSTALLED AND STABILIZED PRIOR TO DIRECTING ANY RUNOFF TO IT.
- 17. DETENTION PONDS REQUIRE TIMELY MAINTENANCE AND SHOULD BE INSPECTED AFTER EVERY MAJOR STORM EVENT, AS MELL AS FREQUENTLY DURING THE FIRST YEAR OF OPERATION, AND ANNUALLY THEREAFTER EVERY FIVE YEARS, THE SERVICES OF A PROFESSIONAL BUGINERS SHOULD BE RETAINED TO PERFORD A THOROUGH INSPECTION OF THE DETENTION POND AND ITS INFRASTRUCTURE. ANY DEBRIS AND SEDIMENT ACCUMULATIONS SHOULD BE REMOVED FROM THE OUTLET STRUCTURES(S) AND EXPRESENCY SHELWAY(S) AND DISPOSED OF PROFERIY, DETENTION POND BERMS SHOULD BE MONED AT LEAST ONCE ANNUALLY SO AS TO PREVISIT THE ESTABLISHMENT OF WOODY VECETAINON. TREES SHOULD NEVER BE ALLOWED TO GROW ON A PETHIND POND BERM AS THEY MAY DESTABLIZE THE STRUCTURE AND INCREASE THE POTENTIAL FOR FAILURE ARE AS THEY MAY DESTABLIZE THE STRUCTURE AND INCREASE THE POTENTIAL FOR FAILURE AND MEMBALE THE STRUCTURE AND INCREASE THE POTENTIAL FOR FAILURE AND MEMBALE THE STRUCTURE AND INCREASE THE POTENTIAL FOR FAILURE AND MEMBALE THE STRUCTURE AND INCREASE THE POTENTIAL FOR FAILURE AND MEMBALE OF WHATEVER MEMBALE SHOULD SEE REPARKED BAMEDIATELY AND THE ANIMALS SHOULD BE TRAPPED AND RELOCATED IF THE PROBLEM PERSISTS.
- THE DETENTION PONDS ARE TO BE CONSTRUCTED PRIMARILY THROUGH EXCAVATION. IN THOSE AREAS WHERE THE BERMS MUST BE CONSTRUCTED BY THE PLACEMENT OF FILL, THE ENTIRE EMBANGMENT AREA OF THE DETENTION PONDS SHALL BE EXCAVATED TO PROPOSED GRADE, STRIPPED OF ALL ORGANIC MATERIALS, COMPACTED TO AT LEAST 95% AND SCARFIED PRIOR TO THE PLACEMENT OF THE EMBANGMENT MATERIAL IN THE EVENT THE FOUNDATION MATERIAL EXPOSED DOES NOT ALLOW THE SPECIFED COMPACTION, AN ADDITIONAL ONE FOOT (1) OF EXCAVATION AND THE PLACEMENT OF A ONE FOOT (1) THICK, TWILLY FOOT (12) MICE PAD OF THE MATERIAL DESCRIBED IN THE NOTE BELOW, COMPACTED TO 95% OF ASTM D-1557 MAY BE MEDESSARY, PLACEMENT AND COMPACTION SHOULD OCUPLAT A MOSTURE CONTENT OF OPTIMEM PLUS OR MINUS 3%, AND NO FROZEN OR ORGANIC MATERIAL SHOULD BE PLACED WITHIN FOR ANY REASON.
- EMBANKMENT MATERIAL FOR THE BERMS SHALL BE CLEAN MINERAL SOIL WITH A CLAY COMPONENT FREE OF ROOTS, ORGANIC MATTER, AND OTHER DELETERIOUS SUBSTANCES, AND SHALL CONTAIN NO ROCKS OR LUMPS OVER FOUR INCHES (4") IN DIAMETER. THIS MATERIAL SHOULD BE INSTALLED IN 6" LIFTS AND COMPACTED TO 95% OS ASTN 0-1557, AND SHOULD MEET THE FOLLOWING SPECIFICATIONS: 4" PASSING 100%, P4 SIEVE
- 20. EMBANKWENT IS TO HAVE 3:1 SIDE SLOPES (MAX.) AND IS TO BE BROUGHT TO SPECIFIED GRADES PRIOR TO THE ADDITION OF LOAM (4" MINIMUM) SO AS TO ALLOW FOR THE COMPACTION OF THE STRUCTURE OVER TIME WHILE MANYARMING THE PROPER BERN LECYATION.
- COMPACTION TESTING SERVICES (I.E. NUCLEAR DENSITY TESTS) ARE TO BE PERFORMED BY AN INDEPENDEN GEOTECHNICAL ENGINEER RETAINED BY THE CONTRACTOR FOR ROADWAY CONSTRUCTION, AND ON THE FOUNDATION OF THE EBRI AND ON EVERY LIST OF NEMLY PLACED MATERIAL.
- 22. SLOPED GRANITE CURB TO BE TIPPED DOWN AT ALL DRIVEWAY ENTRANCES BY THE CONTRACTOR

HAZELNUT AVENUE



PLAN AND PROFILE

BAYBERRY COMMONS Project: 19 OLD GONIC ROAD, ROCHESTER, NH

LEO P. LACOUTURE REV. TRUST & WILLIAM B. LACOUTURE 19 OLD GONIC RD., ROCHESTER, NH 03867 BK 4093 PG 148

DRAWING No. SHEET 26 OF 55 JBE PROJECT NO. 21090

GRAPHIC SCALE (IN FEET)

1 inch = 40 ft Horiz 1 inch = 4 ft VerL



Design: JAC Draft: LAZ Date: 04/29/21 Checked: JAC Scale: AS NOTED Project No.: 21090 Drawing Name: 21090-PLAN.dwg THIS PLAN SHALL NOT BE MODIFIED WITHOUT WRITTEN PERMISSION FROM JONES & BEACH ENGINEERS, INC. (JBE)-ANY ALTERATIONS, AUTHORIZED OR OTHERWISE, SHALL BE

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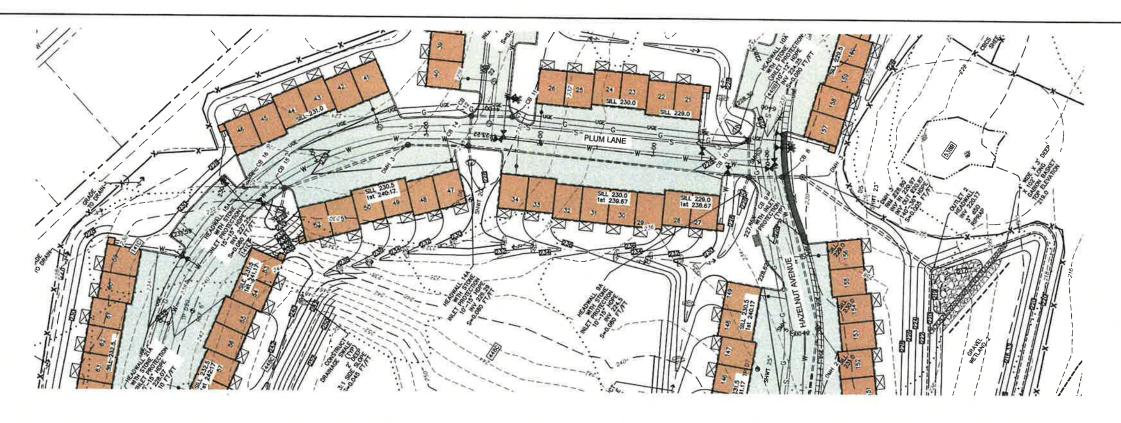
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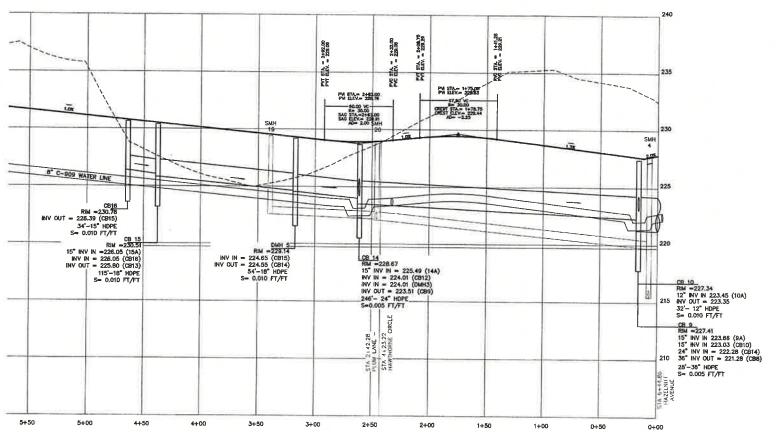
B Jones & Beach Engineers, Inc.

603-772-4746 FAX: 603-772-0227 85 Portsmouth Ave. Civil Engineering Services E-MAIL: JBE@JONESANDBEACH,COM

Plan Name:	PLAN AND PROFILE
Project:	BAYBERRY COMMONS 19 OLD GONIC ROAD, ROCHESTER, NH
Owner of Record:	LEO P. LACOUTURE REV. TRUST & WILLIAM B. LACOUTURE 19 OLD GONIC RD., ROCHESTER, NH 03867 BK 4093 PG 148

SHEET 27 OF 55 JBE PROJECT NO.21090





GRAPHIC SCALE
(IN FEET)
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1 inch = 4 ft Vert.

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18	9/12/23	REVISED PER TOWN COMMENTS	LAZ
19	10/31/23	ISSUED FINAL PLANS	LAZ

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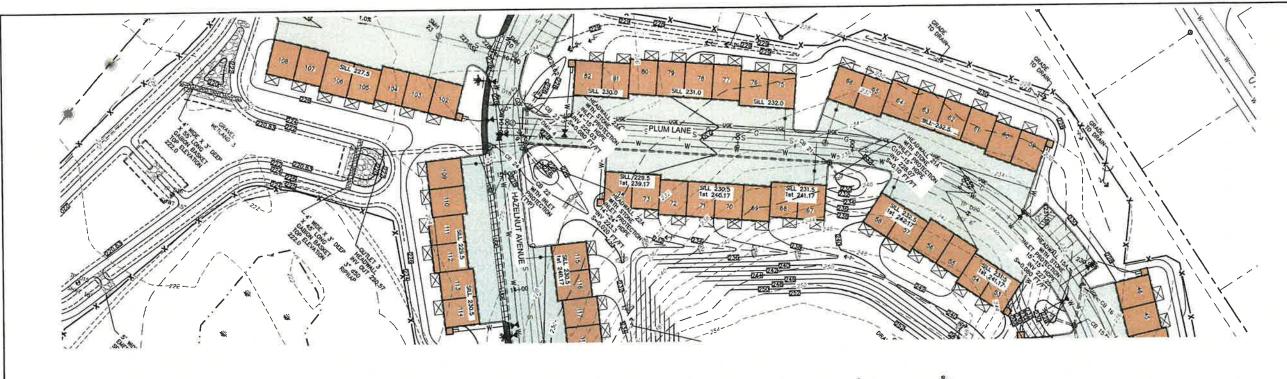
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PO Box 219
Stratham, NH 03885


603-772-0227
E-MAIL: JBE@JONESANDBEACH.COM

Plan Name:	PLAN AND PROFILE
Project:	BAYBERRY COMMONS 19 OLD GONIC ROAD, ROCHESTER, NH
Owner of Record:	LEO P. LACOUTURE REV. TRUST & WILLIAM B. LACOUTURE 19 OLD GONIC RD., ROCHESTER, NH 03867 BK 4093 PG 148

PLUM LANE

P3
SHEET 28 OF 55
JBE PROJECT NO. 21080



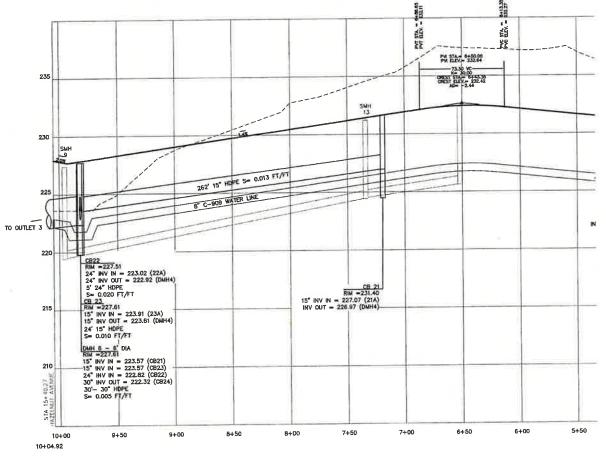

GRAPHIC SCALE
(IN FEET)
1 inch = 40 ft Horiz
1 inch = 4 ft Vert

PLUM LANE

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Checked: JAC	Scale: AS NOTED	Project No.: 21090
Drawing Name:	21090-PLAN.dwg	
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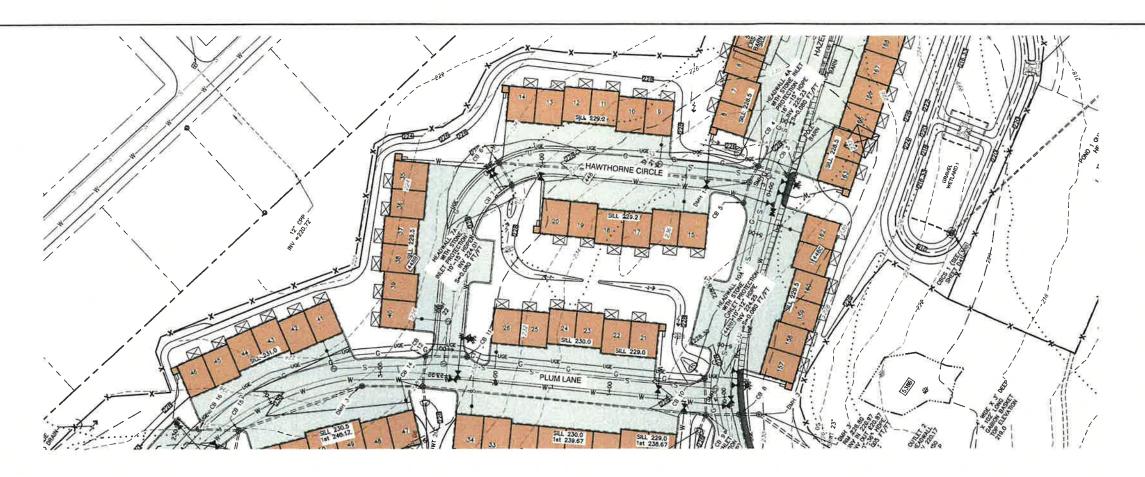
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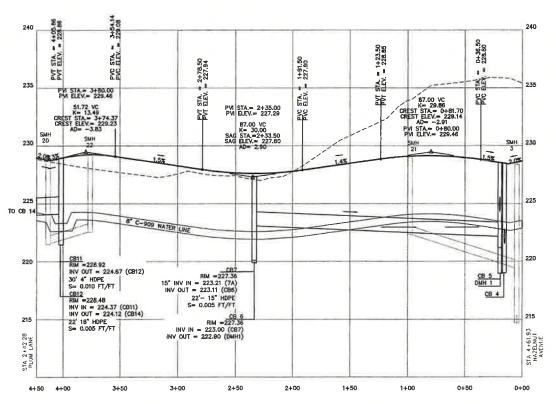
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REV.	DATE	REVISION	BY

T/			signed and Pro			
B Jo	nes	&	Beach	n Engin	eers,	Inc.
85 Portsmouth Ave. PO Box 219 Stralham, NH 03885	Civil	Eng	ineering	Services E-MAIL: JBE@-	FAX: 603	3-772-4746 3-772-0227 ACH.COM

Plan Name:	PLAN AND PROFILE	
Project:	BAYBERRY COMMONS 19 OLD GONIC ROAD, ROCHESTER, NH	
Owner of Record:	LEO P. LACOUTURE REV. TRUST & WILLIAM B. LACOUTURE	

P4
SHEET 20 OF 55
JBE PROJECT NO.2106





GRAPHIC SCALE
(N FEET)
1 inch = 40 ft Horiz
1 inch = 4 ft Vert

HAWTHORNE CIRCLE

Design: JAC	Draft: LAZ	Date: 04/29/21	1
Checked: JAC	Scale: AS NOTE!	Project No.: 21090	l
Drawing Name:	21090-PLAN.dwg		1
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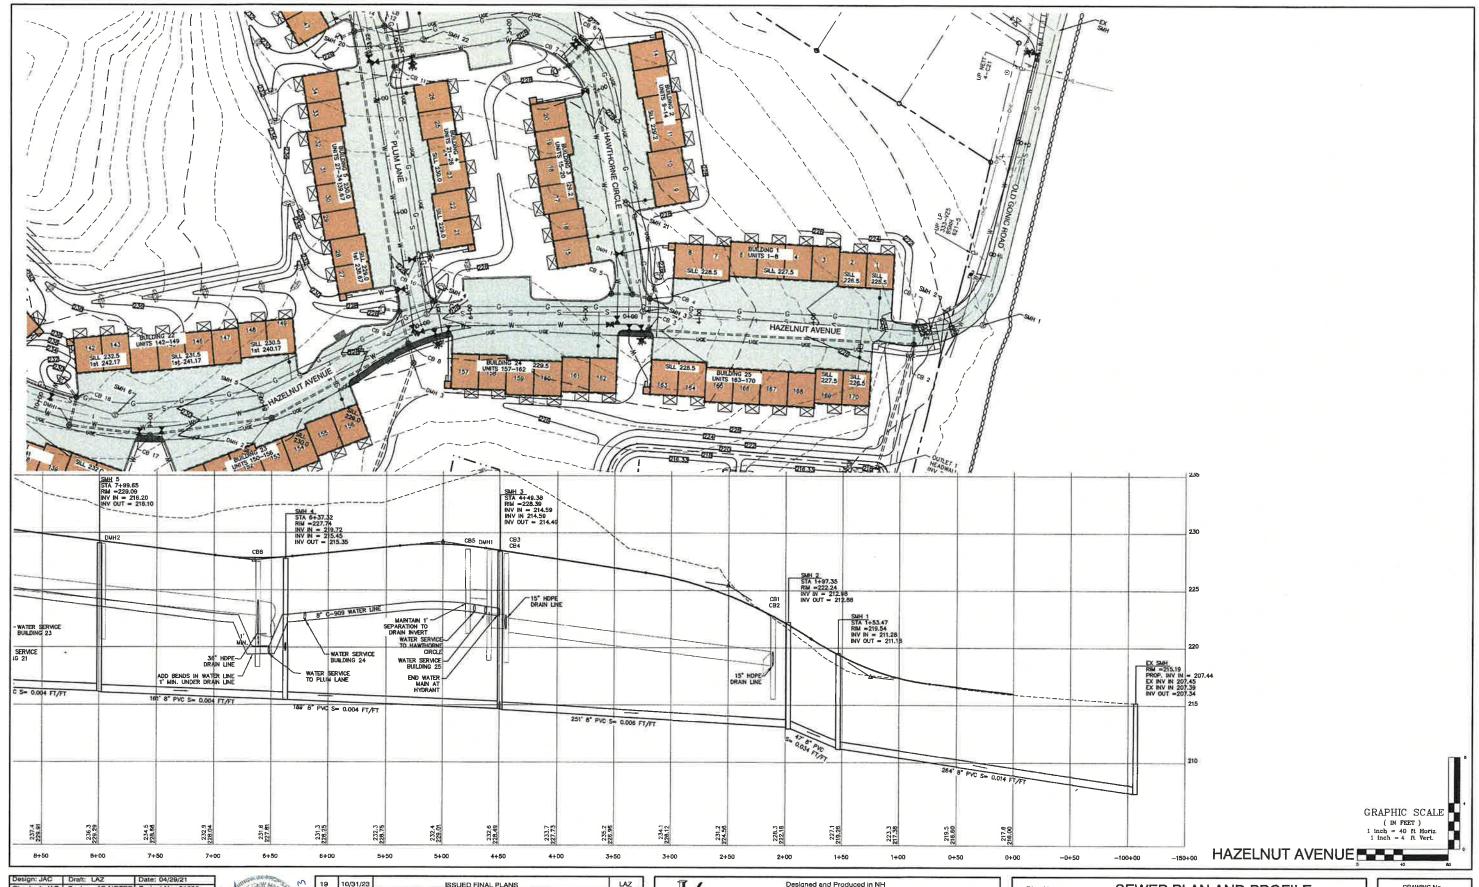


19	10/31/23	ISSUED FINAL PLANS	LAZ
18	9/12/23	REVISED PER TOWN COMMENTS	LAZ
17	8/24/23	REVISED PER TOWN COMMENTS	LAZ
16	6/14/23	REVISED OFFSITE PLANS	LAZ
15	5/23/23	REVISED PER CONDITIONS OF APPROVAL	LAZ
REV.	DATE	AEVISION	BY

Designed and Produced in NH						
JR Jo	nes	&	Beach	n Engin	eers,	Inc.
85 Portsmouth Ave. PO Box 219	Civil	Eng	ineering		FAX: 603	3-772-4746 3-772-0227
Stratham, NH 03885				E-MAIL: JBE@J	ONESANDBE	ACH COM

Plan Name:	PLAN AND PROFILE
Project:	BAYBERRY COMMONS 19 OLD GONIC ROAD, ROCHESTER, NH
Owner of Record:	LEO P. LACOUTURE REV. TRUST & WILLIAM B. LACOUTURE 19 OLD GONIC RD., ROCHESTER, NH 03867 BK 4093 PG 148

P5
SHEET 30 OF 55
JBE PROJECT NO.21090



Design: JAC Draft: LAZ Date: 04/29/21
Checked: JAC Scale: AS NOTED Project No.: 21090
Drawing Name: 21090-PLAN.dwg
THIS PLAN SHALL NOT BE MODIFIED WITHOUT WRITTEN
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19	10/31/23	ISSUED FINAL PLANS	LAZ
18	9/12/23	REVISED PER TOWN COMMENTS	LAZ
17	B/24/23	REVISED PER TOWN COMMENTS	LAZ
16	6/14/23	REVISED OFFSITE PLANS	LAZ
15	5/23/23	REVISED PER CONDITIONS OF APPROVAL	LAZ
REV.	DATE	REVISION	BY

Designed and Produced in NH

Jones & Beach Engineers, Inc.


85 Portsmouth Ave. PO Box 219
Stratham, NH 03885

Designed and Produced in NH

Engineering Services
FAX: 603-772-4746
FAX: 603-772-0227
FE-MAIL: JBE@JONESANDBEACH.COM

Plan Name:	SEWER PLAN AND PROFILE		
Project:	BAYBERRY COMMONS 19 OLD GONIC ROAD, ROCHESTER, NH		
Owner of Record:	LEO P. LACOUTURE REV. TRUST & WILLIAM B. LACOUTURE 19 OLD GONIC RD., ROCHESTER, NH 03867 BK 4093 PG 148		



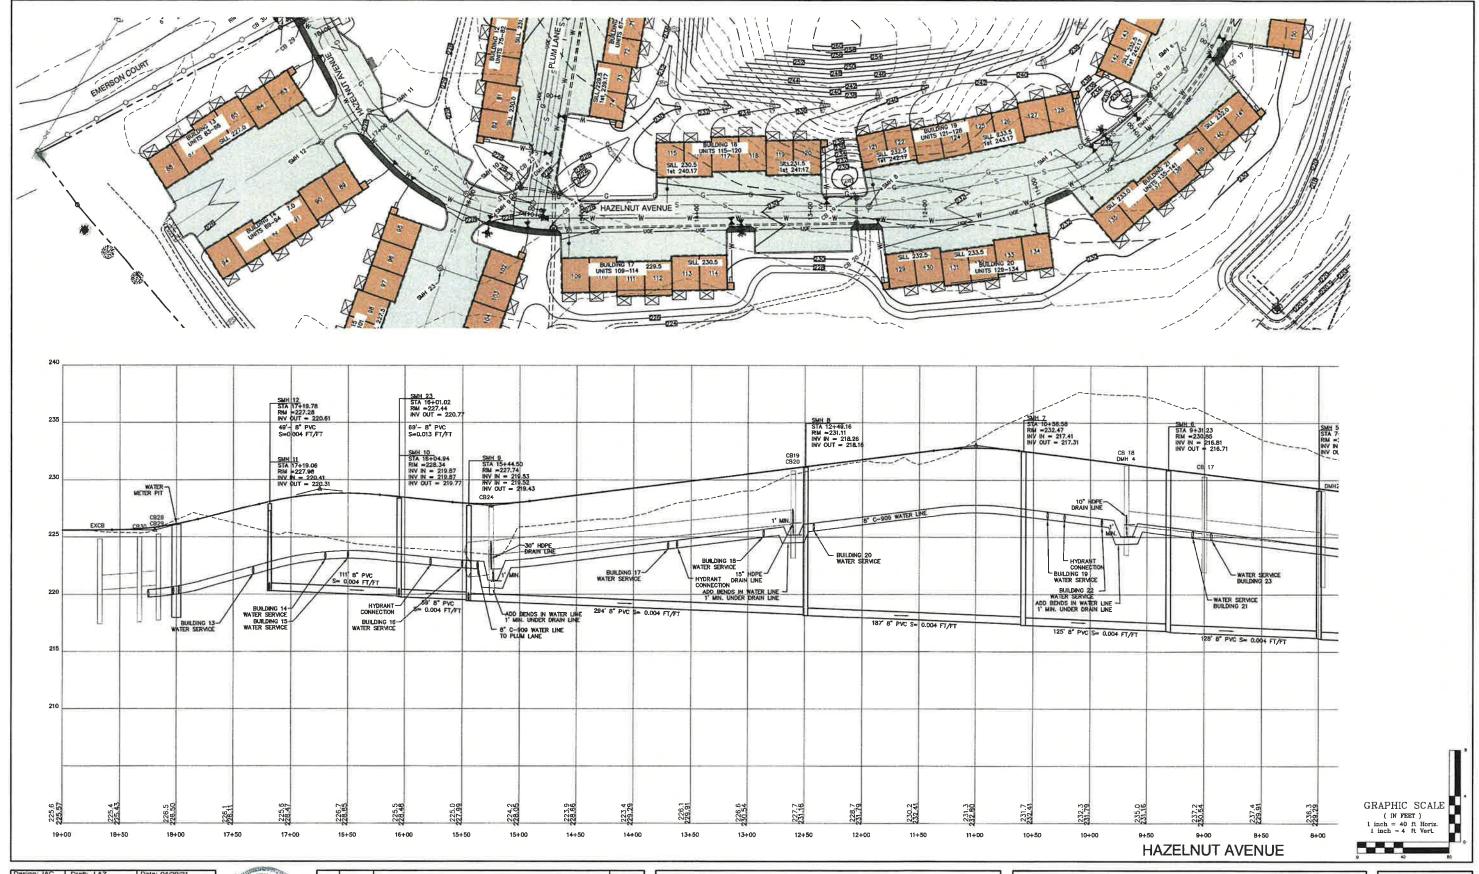

Design: JAC Draft: LAZ Date: 04/29/21
Checked: JAC Scale: AS NOTED Project No.: 21090
Drawing Name: 21090-PLAN.dwg
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18	9/12/23	REVISED PER TOWN COMMENTS	LÁZ
17	8/24/23	REVISED PER TOWN COMMENTS	LAZ
16	6/14/23	REVISED OFFSITE PLANS	LAZ
15	5/23/23	REVISED PER CONDITIONS OF APPROVAL	LAZ
REV.	DATE	REVISION	BY

Designed and Produced in NH

B Jones & Beach Engineers, Inc.

B5 Portsmouth Ave. Civil Engineering Services
FAX: 603-772-4746
FAX: 603-772-0227
Stratham, NH 03865

E-MAIL: JBE@JONESANDBEACH.COM

-0	0		
1	Płan Name:	SEWER PLAN AND PROFILE	
	Project:	BAYBERRY COMMONS 19 OLD GONIC ROAD, ROCHESTER, NH	
	Owner of Record:	LEO P. LACOUTURE REV. TRUST & WILLIAM B. LACOUTURE	

DRAWING No.

P7

SHEET 32 OF 55
JBE PROJECT NO.21090



Design: JAC Dreft: LAZ Date: 04/29/21
Checked: JAC Scale: AS NOTED Project No.: 21090
Drawing Name: 21090-PLAN.dwg
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REV.	DATE	REVISION	BY
15	5/23/23	REVISED PER CONDITIONS OF APPROVAL	LAZ
16	6/14/23	REVISED OFFSITE PLANS	LAZ
17	8/24/23	REVISED PER TOWN COMMENTS	LAZ
18	9/12/23	REVISED PER TOWN COMMENTS	LAZ
19	10/31/23	ISSUED FINAL PLANS	LAZ

Designed and Produced In NH

Jones & Beach Engineers, Inc.

85 Portsmouth Aug. Civil Engineers Services 609,7724786


85 Portsmouth Ave. Civil Engineering Services 603-772-4748
PO Box 219
Stretham, NH 03885 6-MAIL: JBE@JONESANDBEACH.COM

Plan Name:	SEWER PLAN AND PROFILE
Project:	BAYBERRY COMMONS 19 OLD GONIC ROAD, ROCHESTER, NH
Owner of Record:	LEO P. LACOUTURE REV. TRUST & WILLIAM B. LACOUTURE 19 OLD GONIC RD., ROCHESTER, NH 03867 BK 4093 PG 148

PRAWING No.

PS
SHEET 33 OF 55
JBE PROJECT NO.21090



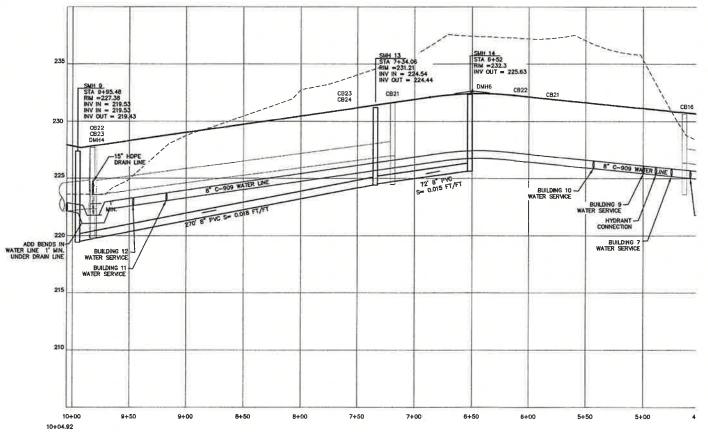

GRAPHIC SCALE
(IN FEET)
I inch = 40 ft Horiz
I inch = 4 ft Vert.

PLUM LANE

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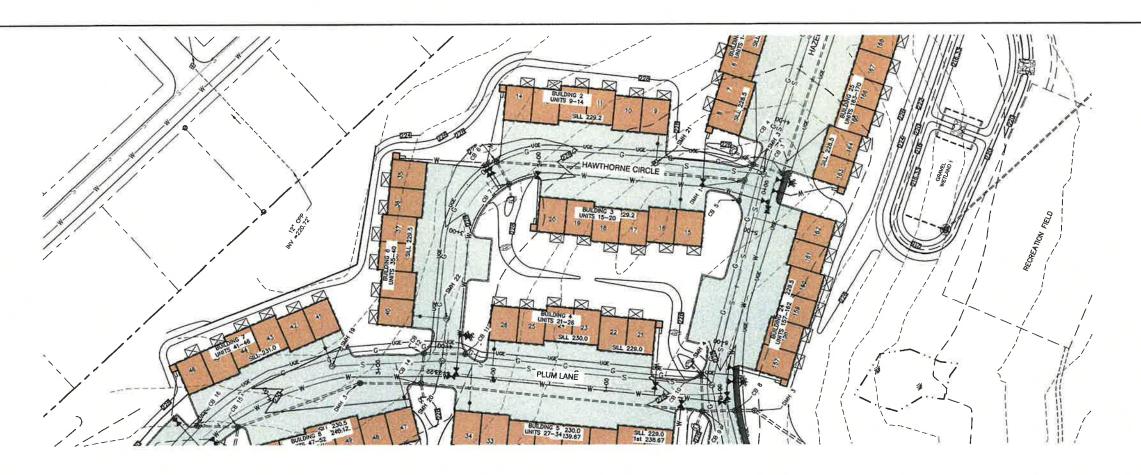



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17	8/24/23	REVISED PER TOWN COMMENTS	LAZ
16	6/14/23	REVISED OFFSITE PLANS	LAZ
15	5/23/23	REVISED PER CONDITIONS OF APPROVAL	LAZ
REV.	DATE	REVISION	BY

1/			signed and Pro			
B Jo	nes	&	Beach	ı Engi	neers,	Inc.
85 Portsmouth Ave PO Box 219 Stratham, NH 03885				Services	603	3-772-4746 3-772-0227

11	Plan Name:	SEWER PLAN AND PROFILE
П	Project:	BAYBERRY COMMONS 19 OLD GONIC ROAD, ROCHESTER, NH
	Owner of Record:	LEO P. LACOUTURE REV. TRUST & WILLIAM B. LACOUTURE 19 OLD GONIC RD., ROCHESTER, NH 03867 BK 4093 PG 148

P9
SHEET 34 OF 55
JBE PROJECT NO. 21090



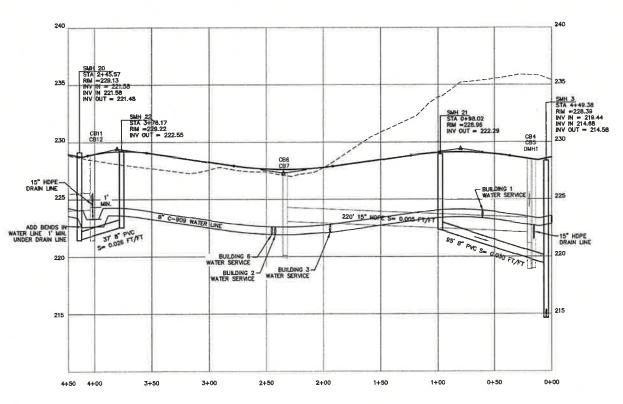

GRAPHIC SCALE
(IN FEET)
1 inch = 40 ft Horiz,
1 inch = 4 ft Vert.

HAWTHORNE CIRCLE

Design: JAC	Draft: LAZ	Date: 04/29/21	٦.
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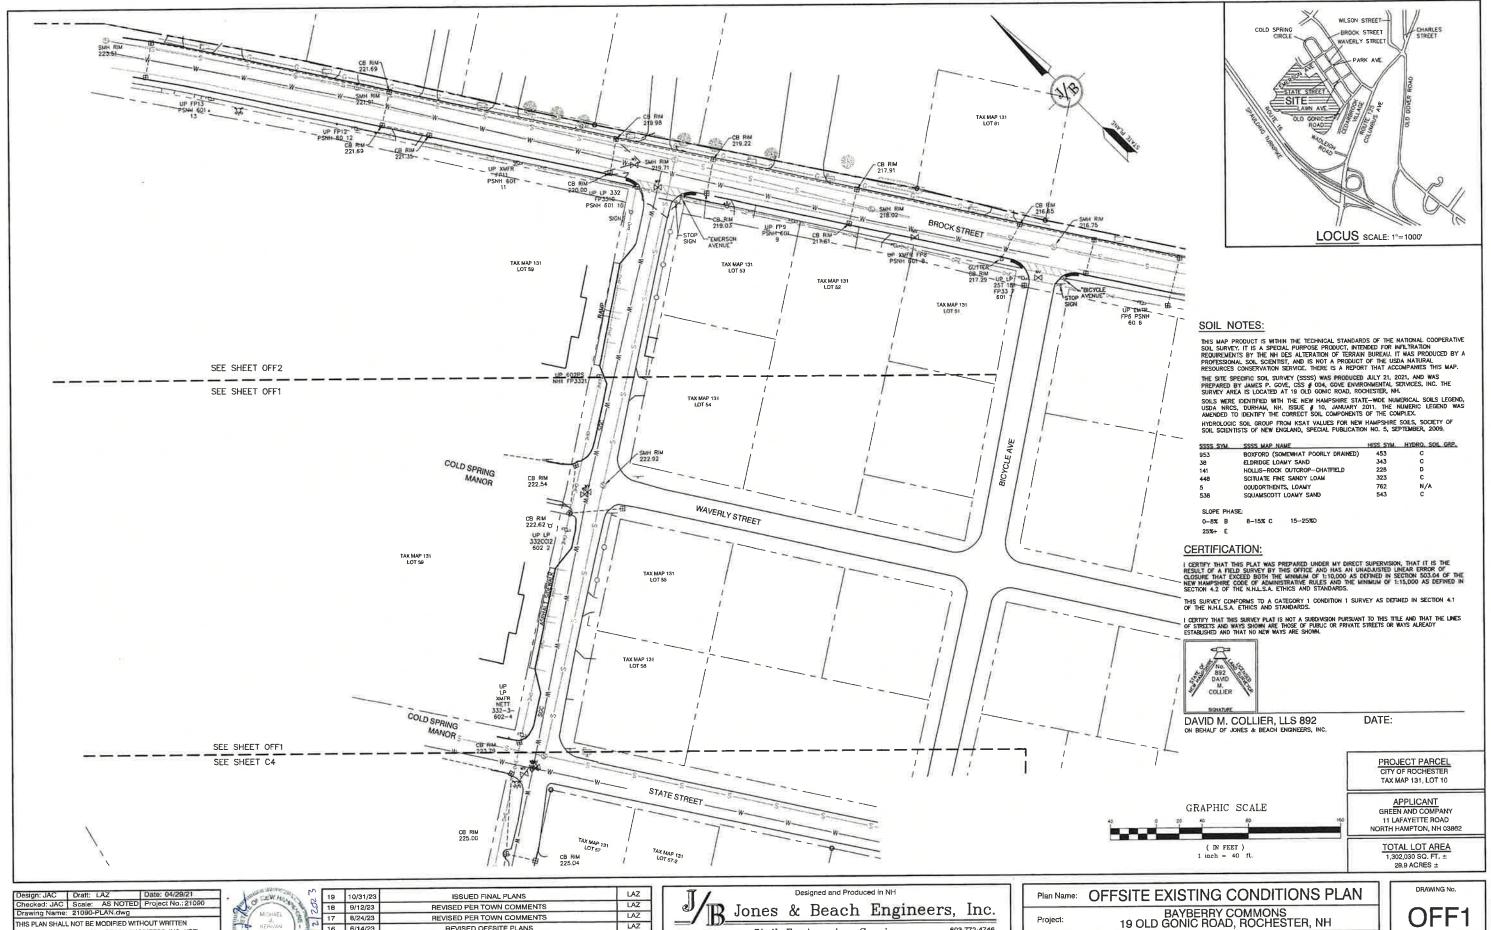


19	10/31/23	ISSUED FINAL PLANS	LAZ
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17	B/24/23	REVISED PER TOWN COMMENTS	LAZ
16	6/14/23	REVISED OFFSITE PLANS	LAZ
15	5/23/23	REVISED PER CONDITIONS OF APPROVAL	LAZ
REV.	DATE	REVISION	BY


11	Designed and Produced in NH					
B Jo	nes	&	Beach	n Engin	eers,	Inc.
85 Portsmouth Ave. PO Box 219			ineering		603 FAX: 603	-772-4746 -772-0227

	Plan Name:	SEWER PLAN AND PROFILE
	Project:	BAYBERRY COMMONS 19 OLD GONIC ROAD, ROCHESTER, NH
	Owner of Record:	LEO P. LACOUTURE REV. TRUST & WILLIAM B. LACOUTURE

P10
SHEET 35 OF 55
JBE PROJECT NO.21090





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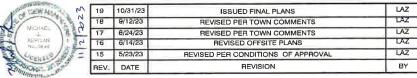
85 Portsmouth Ave Civil Engineering Services FAX: 603-772-0227
E-MAIL: JBE@JONESANDBEACH.COM LEO P. LACOUTURE REV. TRUST & WILLIAM B. LACOUTURE 19 OLD GONIC RD., ROCHESTER, NH 03867 BK 4093 PG 148

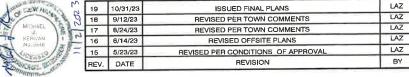SHEET 36 OF 55 JBE PROJECT NO. 21090



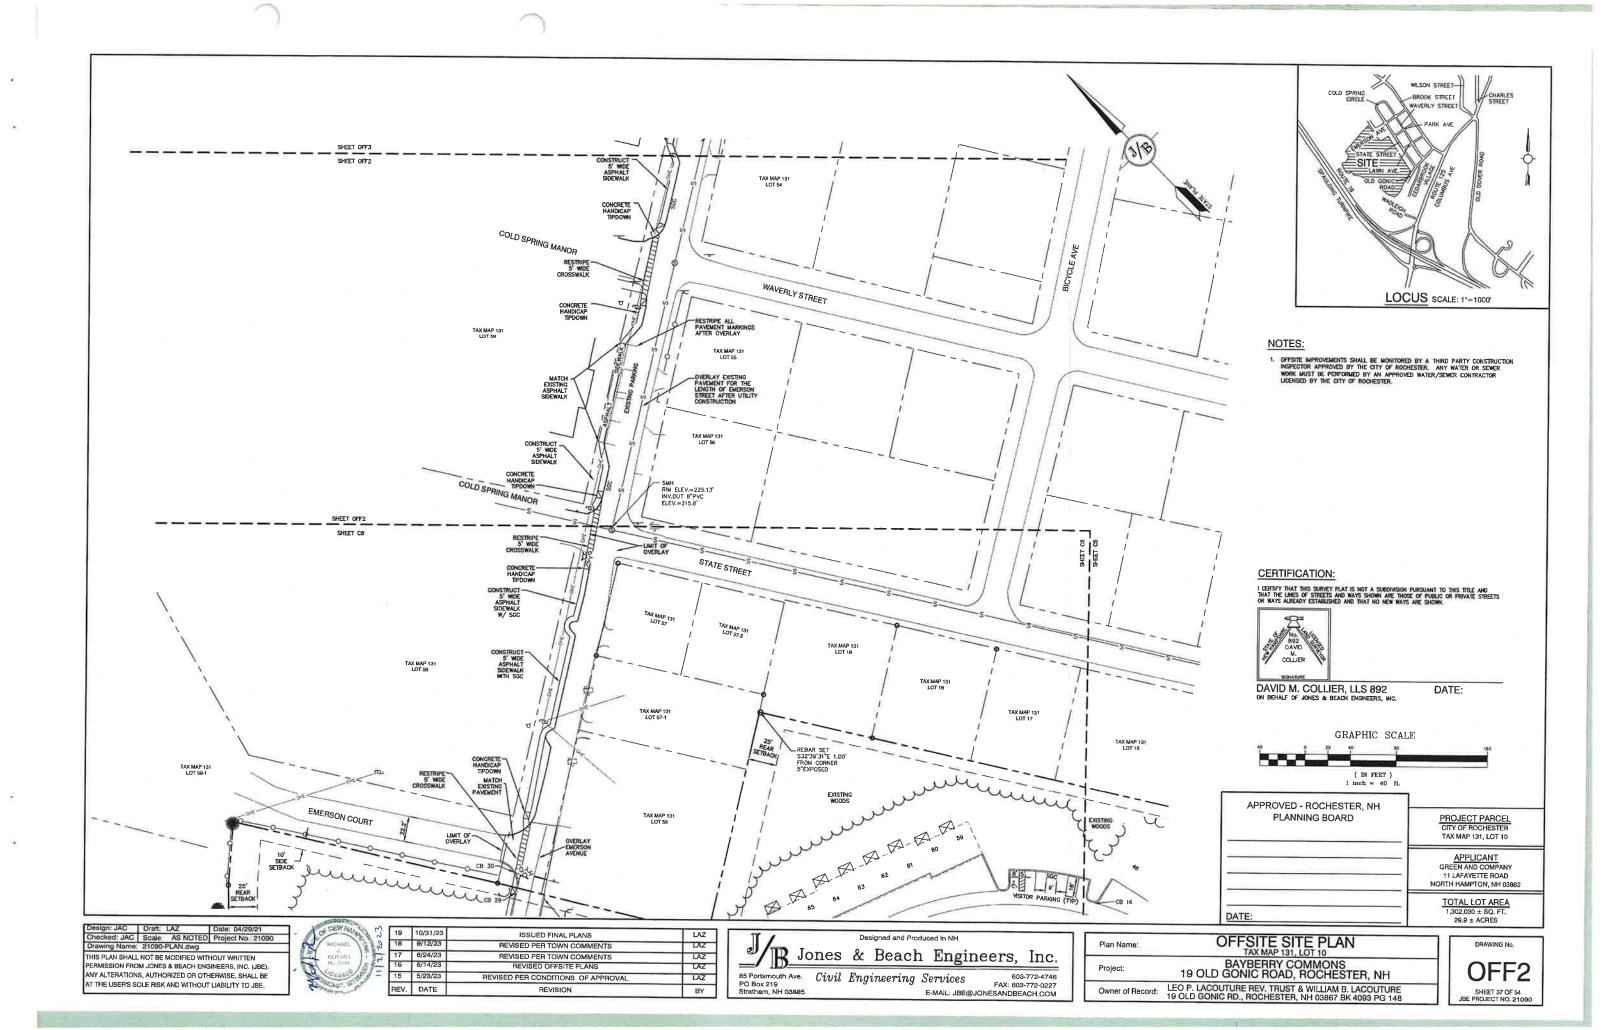


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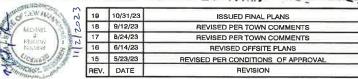
B Jones & Beach Engineers, Inc. Services 603-772-4746 FAX: 603-772-0227 E-MAIL: JBE@JONESANDBEACH.COM B5 Portsmouth Ave Civil Engineering Services PO Box 219 Stralham, NH 03885

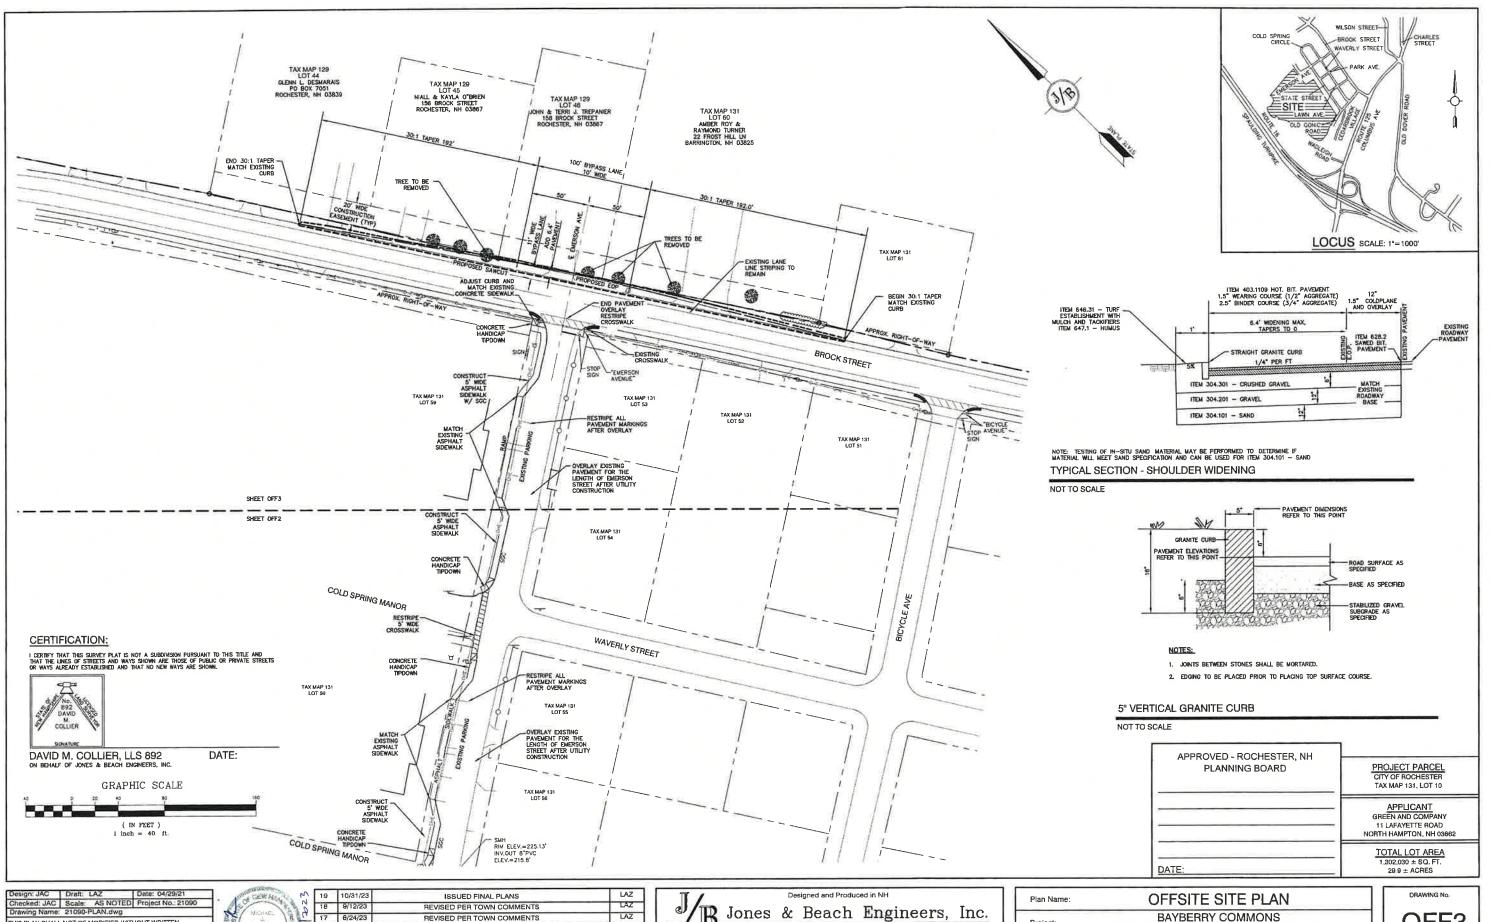Plan Name:	OFFSITE SITE PLAN	
Project:	Project: BAYBERRY COMMONS 19 OLD GONIC ROAD, ROCHESTER, NH	
Owner of Record:	LEO P. LACOUTURE REV. TRUST & WILLIAM B. LACOUTURE 19 OLD GONIC RD., ROCHESTER, NH 03867 BK 4093 PG 148	

OFF3 SHEET 38 OF 54 JBE PROJECT NO. 21090



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Services 603-772-4746 FAX: 603-772-0227 E-MAIL: JBE@JONESANDBEACH.COM 85 Portsmouth Ave. Civil Engineering Services
PO Box 219
Stratham, NH 03885
E-MAIL: JBE@

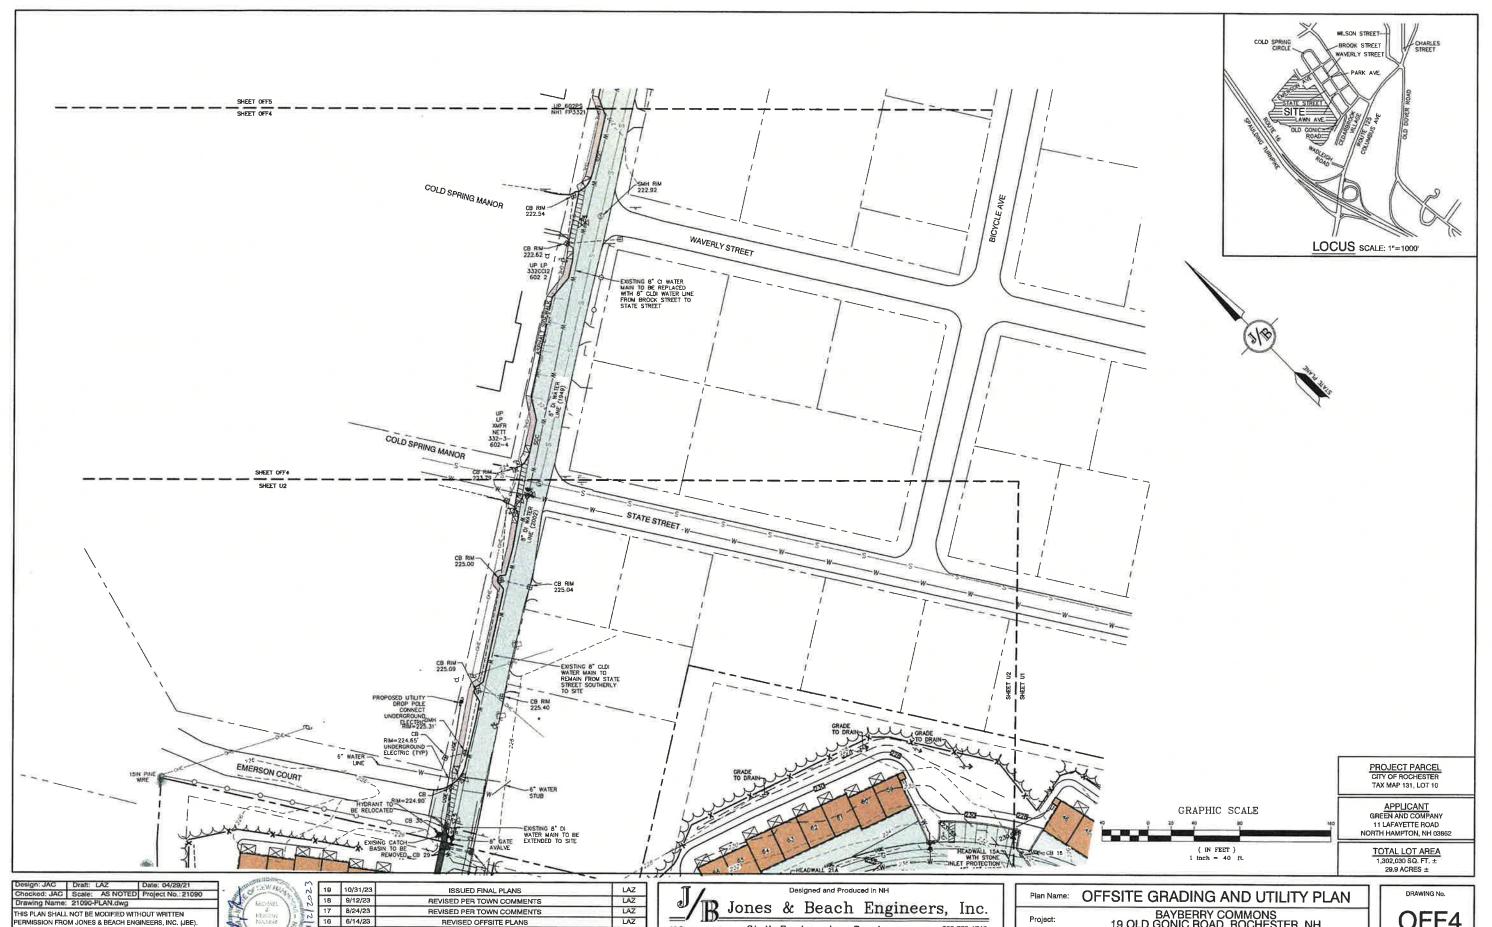
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BY

BAYBERRY COMMONS 19 OLD GONIC ROAD, ROCHESTER, NH LEO P. LACOUTURE REV. TRUST & WILLIAM B. LACOUTURE 19 OLD GONIC RD., ROCHESTER, NH 03867 BK 4093 PG 148

Owner of Record:

OFF4 SHEET 39 OF 55 JBE PROJECT NO. 21090

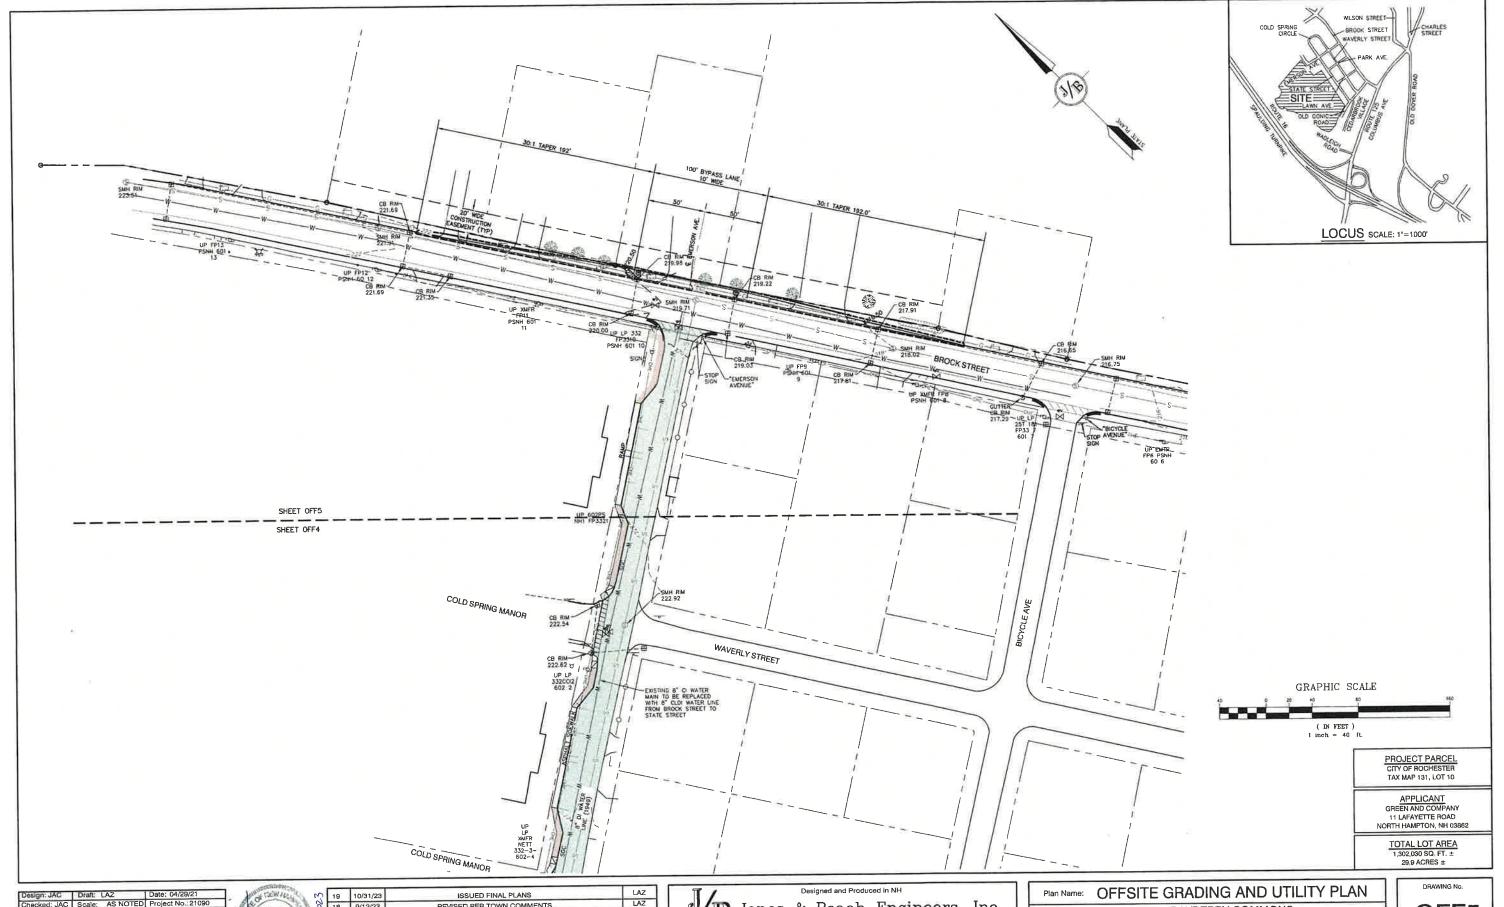

 Design: JAC
 Draft
 LAZ
 Date: 04/29/21

 Checked: JAC
 Scale: AS NOTED
 Project No.: 21090

 Drawing Name: 21090-PLAN.dwg
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LAZ 18 9/12/23 REVISED PER TOWN COMMENTS LAZ 17 B/24/23 REVISED PER TOWN COMMENTS LAZ 16 6/14/23 REVISED OFFSITE PLANS LAZ BY REVISED PER CONDITIONS OF APPROVAL 15 5/23/23 REVISION REV. DATE

Jones & Beach Engineers, Inc. Services 603-772-4746 FAX: 603-772-0227 E-MAIL: JBE@JONESANDBEACH.COM


B5 Portsmouth Ave. Civil Engineering Services
PO Box 219
Stratham, NH 03885

E-MAIL: JBE@

Project: BAYBERRY COMMONS
19 OLD GONIC ROAD, ROCHESTER, NH

Owner of Record: LEO P. LACOUTURE REV. TRUST & WILLIAM B. LACOUTURE
19 OLD GONIC RD., ROCHESTER, NH 03867 BK 4093 PG 148

OFF5

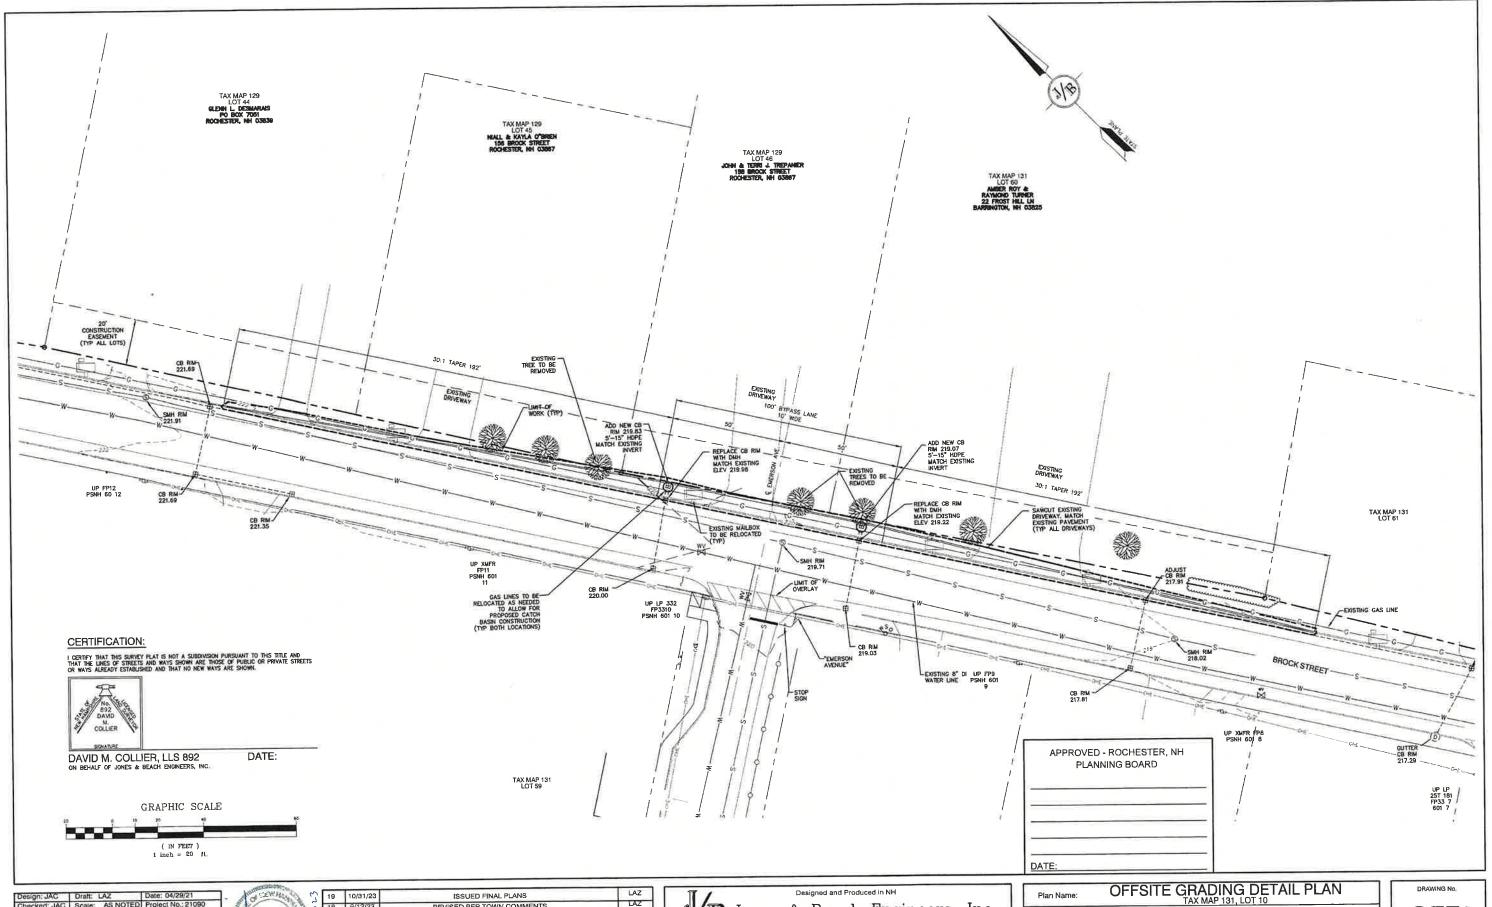

Design: JAC Draft: LAZ Date: 04/29/21
Checked: JAC Scale: AS NOTED Project No.: 21090
Drawing Name: 21090-PLAN.dwg
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19	10/31/23	ISSUED FINAL PLANS	LAZ
18	9/12/23	REVISED PER TOWN COMMENTS	LAZ
17	8/24/23	REVISED PER TOWN COMMENTS	LAZ
16	6/14/23	REVISED OFFSITE PLANS	LAZ
15	15 5/23/23 REVISED PER CONDITIONS OF APPRI		LAZ
REV.	DATE	REVISION	BY


Jones & Beach Engineers, Inc.

85 Portsmouth Ave. Civil Engineering Services 603-772-4746
PO Box 219
Stratham, NH 03885

E-MAIL: JBE@JONESANDBEACH.COM

Plan Name:	OFFSITE GRADING DETAIL PLAN	
Project:	Project: BAYBERRY COMMONS 19 OLD GONIC ROAD, ROCHESTER, NH	
Owner of Record:	LEO P. LACOUTURE REV. TRUST & WILLIAM B. LACOUTURE 19 OLD GONIC RD., ROCHESTER, NH 03867 BK 4093 PG 148	

OFF6
SHEET 41 OF 54
JBE PROJECT NO. 21090

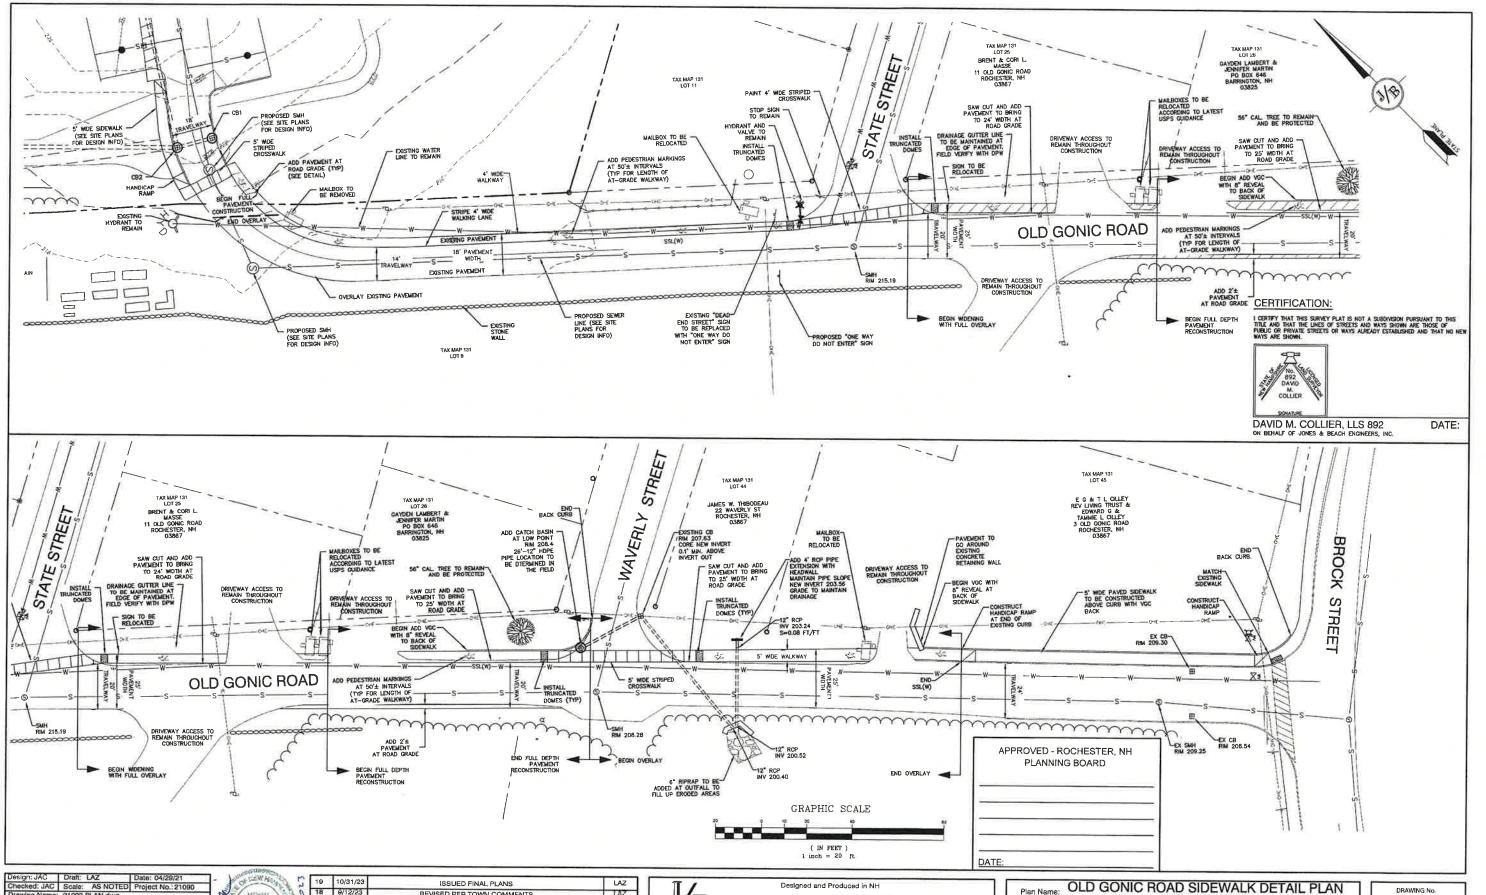

Design: JAC Draft: LAZ Date: 04/26/21
Checked; JAC Scale: AS NOTED Project No.: 21090
Drawing Name: 21090-PLAN.dwg
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15 5/23/23 REVISED PER CONDITIONS OF APPROVAL			LAZ		
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18	9/12/23	REVISED PER TOWN COMMENTS			
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Designed and Produced in NH

Jones & Beach Engineers, Inc.

85 Portsmouth Ava. Citatil Engineering Semilors 603-772-4745

85 Portsmouth Ave. Civil Engineering Services 603-772-4745
PO Box 219
Stratham, NH 03885


603-772-4745
E-MAIL: JBE@JONESANDBEACH.COM


Plan Name: OLD GONIC ROAD SIDEWALK DETAIL PLAN
TAX MAP 131, LOT 10

BAYBERRY COMMONS
19 OLD GONIC ROAD, ROCHESTER, NH

Owner of Record: LEO P. LACOUTURE REV. TRUST & WILLIAM B. LACOUTURE
19 OLD GONIC RD., ROCHESTER, NH 03867 BK 4093 PG 148

OFF7
SHEET 42 OF 54
JBE PROJECT NO. 21090

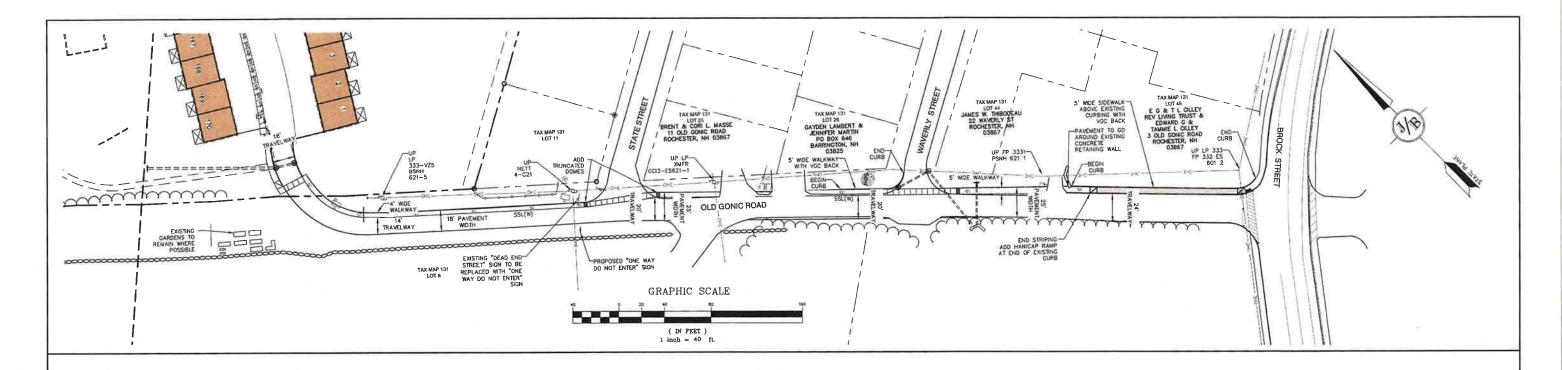

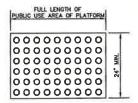

- DETECTABLE WARNINGS SHALL CONSIST OF A SURFACE OF TRUNCATED DOMES AND SHALL COMPLY WITH THE FOLLOWING:

 A TRUNCATED DOMES SHALL HAVE A BASE DIAMETER OF 0.9" (MIN.) AND 1.4" (MIAX.), A TOP DIAMETER OF 50% OF THE BASE DIAMETER MINIMUM AND 0.4" OF 100 C.2".

 B. TRUNCATED DOMES SHALL HAVE A CENTER-TO-CENTER SPACING OF 1.8" MINIMUM AND 2.4" MAXNIM, AND 8.4 BASE—TO-BASE SPACING OF 6.8" MINIMUM AND 2.4" MAXNIM, AND 8.4 BASE—TO-BASE SPACING OF 6.8" MINIMUM AND 2.4" MAXNIM, MEASURED BETWEEN THE MOST ADJACENT DOMES ON A SOLIARE ORD.

 C. TRUNCATED DOMES TO BE CAST ROW PER NIDOT SPECIFICATIONS.

 D. DETECTABLE WARNING SURFACES SHALL CONTRAST VISUALLY WITH ADJACENT WALKING SURFACES EITHER LIGHT—ON-DARK OR DARK—ON-LIGHT.


TRUNCATED DOMES TO BE PLACED IN SIDEWALK BASE IN PUBLIC TRAFFIC AREAS. ACCESSIBLE CURB RAMP TRUNCATED DOMES

NOTES:

ALL PAVEMENT MARKINGS SHALL BE 100% ACRYLIC WATER-BASED PAINT AS SPECIFIED BY NHDOT AND SHALL CONFORM TO NHDOT DETAILS/STANDARDS.

TYPICAL PEDESTRAIN MARKING SYMBOL


NOT TO SCALE

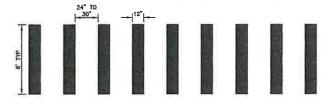

- TRANSVERSE CROSSWALK LINES SHALL 100% ACRYLIC WATER—BASED PAINT AS SPECIFIED BY NHDOT, NOT LESS THAN 6" WIDE AND NOT LESS THAN 6" APART.
- SPACING FOR THE CONTINENTAL CLOCK MARKINGS SHALL BE UNIFORM FOR EACH INDIVIDUAL CROSSWALK BUT CAN BE MODIFED FOR ONE CROSSWALK TO THE NEXT TO ELIMINET A CROSSWALK MARKING DIRECTLY IN THE WHEELPATH.

NHDOT CONTINENTAL BLOCK MARKING DETAIL

NOT TO SCALE

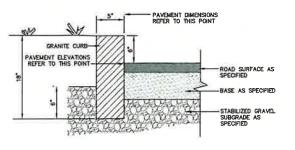


NOTES:

- 1. JOINTS BETWEEN STONES SHALL BE MORTARED.
- 2. EDGING TO BE PLACED PRIOR TO PLACING TOP SURFACE COURSE.


5" VERTICAL GRANITE CURB

NOT TO SCALE

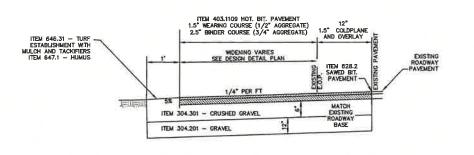

NOTE: TESTING OF IN-SITU SAND MATERIAL MAY BE PERFORMED TO DETERMINE IF MATERIAL WILL MEET SAND SPECIFICATION AND CAN BE USED FOR ITEM 304:101 - SAND TYPICAL SECTION - ROAD WIDENING TO ADD SIDEWALK

NOT TO SCALE

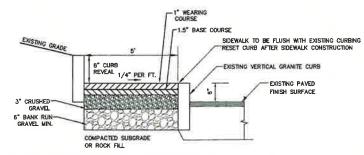

BIT. SIDEWALK W/ VERTICAL GRANITE CURB

NOT TO SCALE

Design: JAC	Draft: LAZ	Date: 04/29/21
Checked: JAC	Scale: AS NOTED	Project No.: 21090
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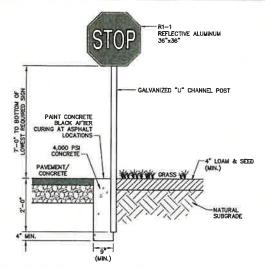
19	10/31/23	ISSUED FINAL PLANS	LAZ
18	9/12/23	REVISED PER TOWN COMMENTS	LAZ
17	8/24/23	REVISED PER TOWN COMMENTS	LAZ
16	6/14/23	REVISED OFFSITE PLANS	LAZ
15	5/23/23	REVISED PER CONDITIONS OF APPROVAL	LAZ
REV.	DATE	REVISION	BY

Designed and Produced in NH B Jones & Beach Engineers, Inc. 85 Portsmouth Ave. Civil Engineering Services
PO Box 219
Stratham, NH 03885
E-MAIL: JBE@ FAX: 603-772-0227 E-MAIL: JBE@JONESANDBEACH.COM

Plan Name:	OLD GONIC ROAD SIDEWALK PLAN
Desirate	BAYBERRY COMMONS


19 OLD GONIC ROAD, ROCHESTER, NH Owner of Record: LEO P. LACOUTURE REV. TRUST & WILLIAM B. LACOUTURE 19 OLD GONIC RD., ROCHESTER, NH 03867 BK 4093 PG 148

DRAWING No. OFF8 SHEET 43 OF 55 JBE PROJECT NO. 21090




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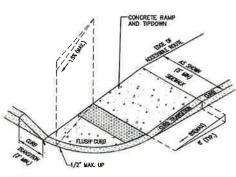
NOT TO SCALE

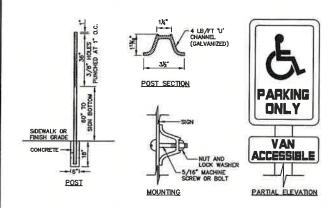

HANDICAP SIGN DETAILS

NOT TO SCALE



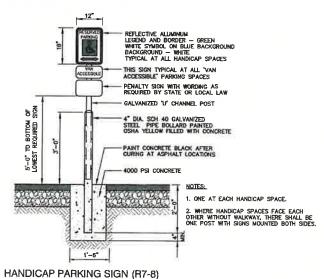

DIES.

THE MANIMA ALLOWABLE CROSS SLOPE OF ACCESSIBLE ROUTE (SDEWALK) AND CLRB SHALL BE 1.5%.

THE MANIMUM ALLOWABLE SLOPE OF ACCESSIBLE ROUTE EXCLURING CUBE RAMPS SHALL BE 5%.

THE MANIMUM ALLOWABLE SLOPE OF ACCESSIBLE ROUTE (SDEWALK) CUBE RAMPS SHALL BE 5%.

A MINIMUM OF 4 FEET CLEAR SHALL BE MANITARED AT ANY PERMANENT OBSTACLE IN ACCESSIBLE ROUTE (La., HURRANTS, UTULY POLES, INSE WILLS, SORGE, AT ANY PERMANENT OBSTACLE IN ACCESSIBLE ROUTE (La., CUBE TREATMENT WARRS, SEE PLANS FOR CUBE TYPE.


CUBE TREATMENT WARRS, SEE PLANS FOR CUBE TYPE.

BASES OF RAMP SHALL BE GRAUDE TO PREMETE PORONIG.

SEE TYPICAL SECTION FOR RAMP CONSTRUCTION.


ACCESSIBLE CURB RAMP (TYPE 'B')

NOT TO SCALE

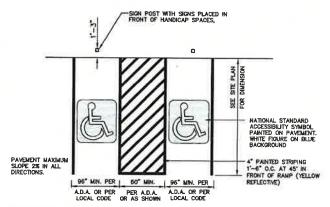

HANDICAP PARKING LAYOUT

NOT TO SCALE

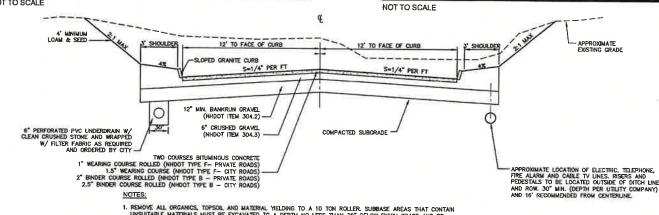


- ALL MATERIALS TO BE AS SPECIFIED PER CITY STANDARDS AND NHDOT, WHICHEVER IS MOST STRINGENT.
 GRADATION AND COMPACTION TEST RESULTS (85% MIN.) SHALL BE SUBMITTED FOR REVIEW AND APPROVAL
- 3. CITY MAY REQUIRE UNDERDRAIN, ADDITIONAL GRAVEL AND/OR ADDITIONAL DRAINAGE IF SOIL CONDITIONS WARRANT
- 4. WOVEN GEOTEXTILE FABRIC SHALL BE PLACED ABOVE SUBGRADE AT ALL WETLAND CROSSINGS.

TYPICAL ROADWAY SECTION W/CURBING (PRIVATE ROADS)

NOT TO SCALE

19 10/31/23 ISSUED FINAL PLANS LAZ 18 9/12/23 REVISED PER TOWN COMMENTS 17 B/24/23 REVISED PER TOWN COMMENTS 16 6/14/23 REVISED OFFSITE PLANS 15 5/23/23 REVISED PER CONDITIONS OF APPROVA REV. DATE BY



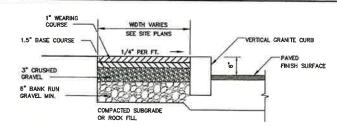

BIT. SIDEWALK W/ VERTICAL GRANITE CURB

NOT TO SCALE

PUBLIC USE AREA OF PLATFORM

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DETECTABLE WARNINGS SHALL CONSIST OF A SURFACE OF TRUNCATED DOMES AND SHALL COMPLY WITH THE FOLLOWING:

A. TRUNCATED DOMES SHALL HAVE A BASE GRAMETER OF 0.9° (MIN.) AND 1.4° (MIX.), A TOP DAMETER OF 50% OF THE BASE GRAMETER MORNIUM TO 65% OF THE BASE DAMETER MORNIUM TO 65% OF THE BASE SPACING OF 1.6° MORNIUM AND 2.4° MORNIUM, AND A SEASE TO-BASE SPACING OF 0.65° MINIMUM AND 1.5° MASKULM, MEASURED BETWEEN THE MOST ADJACENT DOMES ON A SOURCE GRO.

C. TRUNCATED DOMES TO BE CAST ROOM PER INDICT SPECIFICATIONS.

DETECTABLE WARNING SURFACES SHALL CONTRAST VISUALLY WITH ADJACENT WARDING SURFACES ETHER LICHT-ON-DARK OR DARK-ON-LICHT.

TRUNCATED DOMES TO BE PLACED IN SIDEWALK BASE IN PUBLIC TRAFFIC AREAS. ACCESSIBLE CURB RAMP TRUNCATED DOMES

" HOT BIT. PAVEMENT WEARING COURSE

TYPICAL BITUMINOUS PAVEMENT

1'-0"

KEYWAY

KEYWAY DETAIL FOR CONNECTION

TO EXISTING PAVEMENT

NOT TO SCALE

BINDER COURSE

BASE COURSE-


2" HOT BIT PAVEMENT BINDER COURSE

6" NHDOT ITEM 304.3 CRUSHED GRAVEL 95% MIN. COMPACTION INCLUDING RECLAIMED MATERIAL

- NHDOT ITEM 304.2 BANK

-6" CRUSHED GRAVEL


ALL -12" MIN. GRAVEL

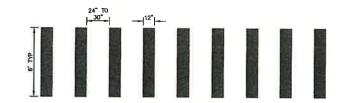

- TRANSVERSE CROSSWALK LINES SHALL BE THERMOPLASTIC, NOT LESS THAN 6" WIDE AND NOT LESS THAN 6" APART.
- SPACING FOR THE CONTINENTAL CLOCK MARKINGS SHALL BE UNIFORM FOR EACH INDIVIDUAL CROSSWALK BUT CAN BE MODIFIED FOR ONE CROSSWALK TO THE NEXT TO ELMINATE A CROSSWALK MARKING DIRECTLY IN THE IMPELIPATH.

NHDOT CONTINENTAL BLOCK MARKING DETAIL


NOT TO SCALE

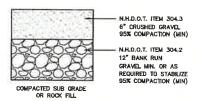

NOTE: IN AREAS OF ROCK EXCAVATION, MINIMUM 9" BANK RUN GRAVEL SHALL BE PLACED

GRAVEL SECTION

NOT TO SCALE

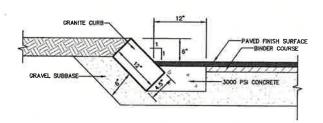

- CURB TO BE PLACED PRIOR TO PLACING TOP SURFACE COURSE.
 JOINTS BETWEEN STONES SHALL BE MORTARED.

SLOPED GRANITE CURB

NOT TO SCALE

Plan Name: DETAIL SHEET	
Project:	BAYBERRY COMMONS 19 OLD GONIC ROAD, ROCHESTER, NH
Owner of Record:	LEO P. LACOUTURE REV. TRUST & WILLIAM B. LACOUTURE 19 OLD GONIC RD., ROCHESTER, NH 03867 BK 4093 PG 148

D1

DRAWING No.


Design: JAC Draft LAZ Date: 04/29/21
Checked: JAC Scale: AS NOTED Project No.: 21090
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LAZ LAZ LAZ LAZ




NOTES:

1. PAVEMENT REPAIR IN EXISTING ROADWAYS SHALL CONFORM TO PAVEMENT DETAILS.

- 2. NEW ROADWAY CONSTRUCTION SHALL CONFORM TO SUBDIVISION SPECIFICATIONS,
- 4. WE MAXIMUM ALLOWABLE TRENCH WIDTH TO A PLANE 12" INCHES ABOVE THE PIPE. FOR PIPES 15 INCHES NOMINAL DIAMETER OR LESS, WIDTH SHALL BE NO MORE THAN 36". FOR PIPES GREATER THAN 15 INCHES NOMINAL DIAMETER, WIDTH SHALL BE 24 INCHES PLUS PIPE OLD. WIDTH SHALL ALSO BE THE PAYMENT WIDTH FOR LEDGE EXCAVATION AND FOR ORDERED EXCAVATION BELOW GRADE.
- RIGID FOAM INSULATION TO BE PROVIDED WHERE COVER IN THE ROADWAY IS LESS THAN 6' AND CROSS COUNTRY IS LESS THAN 4', PURSUANT TO DES WAIVER BEING ISSUED,
- PIPE SAND BLANKET MATERIAL SHALL BE GRADED SAND, FREE FROM ORGANIC MATERIALS, GRADED SUCH THAT 100% PASSES A 1/2 " SIEVE AND A MAXMUM OF 15% PASSES A #200 SIEVE IN ACCORDANCE WITH ENV-WQ 704.11(b).
- JOHT SEALS FOR PVC PIPE SHALL BE OIL RESISTANT COMPRESSION RINGS OF ELASTOMERIC MATERIAL AND CERTIFIED BY THE MANUFACTURER AS CONFORMING TO THE ASTM D3212 STANDARD IN EFFECT WHEN THE JOHT SEALS WERE MANUFACTURED, AND SHALL BE PUSH-ON, BELL-AND-SPIGOT TYPE PER EN-WAY 704-05 (6).

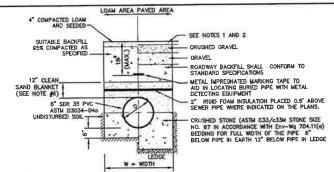SEWER TRENCH


NOT TO SCALE

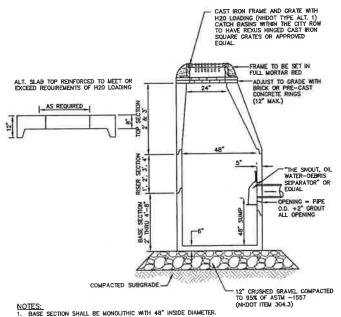

- 2 ALL SECTIONS SHALL BE DESIGNED FOR H20 LOADING.
- 3, CONCRETE SHALL BE COMPRESSIVE STRENGTH 4000 PSI, TYPE II CEMENT
- 4. FRAMES AND GRATES SHALL BE HEAVY DUTY AND DESIGNED FOR H20 LOADING
- PROVIDE "V" KNOCKOUTS FOR PIPES WITH 2" MAX. CLEARANCE TO OUTSIDE OF PIPE MORTAR ALL PIPE CONNECTIONS SO AS TO BE WATERTIGHT.
- 6. JOINT SEALANT BETWEEN PRECAST SECTIONS SHALL BE BUTYL RUBBER
- ALL CATCH BASIN FRAMES AND GRATES SHALL BE NHDOT CATCH BASIN TYPE ALTERNATE 1 OR NEENAH R-3570 OR APPROVED EQUAL (24"x24" TYPICAL).
- STANDARD CATCH BASIN FRAME AND GRATE(S) SHALL BE SET IN FULL MORTAR BED. ADJUST TO GRADE WITH CLAY BRICK AND MORTAR (2 BRICK COURSES TYPICALLY, 5 BRICK COURSES MAXIMUM, BUT NO MORE THAN 12"). OR PRECAST CONCRETE "DOMUTS".
- B. ALL CATCH BASINS ARE TO BE FITTED WITH GREASE HOODS.

CATCH BASIN WITH GREASE HOOD

NOT TO SCALE

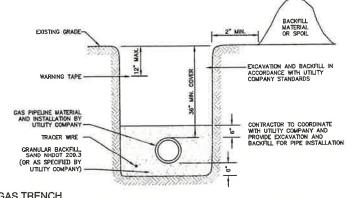


GAS TRENCH

NOT TO SCALE CROSS-COUNTRY | IN PAVEMENT (ASTM D1557) D.I. CLASS 350 DOUBLE CEMENT LINED

IN EARTH IN LEDGE

WATER SYSTEM TRENCH

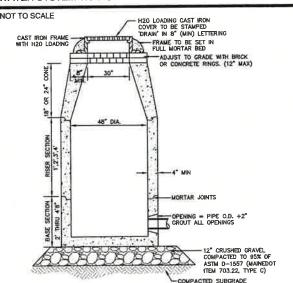


NOTES:

- 1. BASE SECTION SHALL BE MONOLITHIC WITH 48" INSIDE DIAMETER
- 3. CONCRETE SHALL BE COMPRESSIVE STRENGTH 4000 PSI, TYPE II CEMENT.
- 4. FRAMES AND GRATES SHALL BE HEAVY DUTY AND DESIGNED FOR H20 LOADING
- PROVIDE "V" KNOCKOUTS FOR PIPES WITH 2" MAX. CLEARANCE TO OUTSIDE OF PIPE. MORTAR ALL PIPE CONNECTIONS SO AS TO BE WATERTIGHT.
- ALL DRAIN MANHOLE FRAMES AND GRATES SHALL BE NEENAH R-1798 OR APPROVED EQUAL (30° DIA. TYPICAL).
- 8. STANDARD FRAME(S) AND GRATE(S) SHALL BE SET IN FULL MORTAR BED. ADJUST TO GRADE WITH CLAY BRICK AND MORTAR (2 BRICK COURSES TYPICALLY, 5 BRICK COURSES MAXIMUM, BUT NO MORE THAN 12"), OR PRECAST CONCRETE 'DONUTS'.

DRAIN MANHOLE (4' DIAM.)


NOT TO SCALE

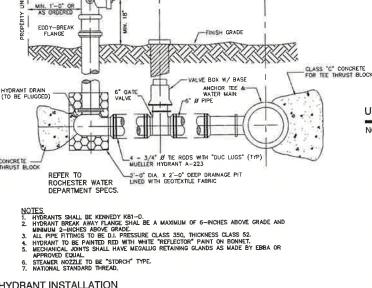

MIN. AS ORDERED


PUMPER NOZZLE TO FACE STREE AT 90"

HYDRANT INSTALLATION

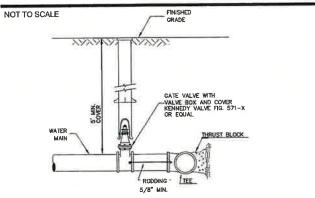

BURIED GATE VALVE DETAIL

NOT TO SCALE

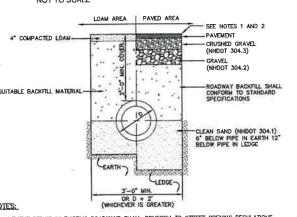

- 1. PAVEMENT REPAIR IN EXISTING ROADWAYS SHALL CONFORM TO STREET OPENING REGULATIONS.
- 2. NEW ROADWAY CONSTRUCTION SHALL CONFORM WITH PROJECT AND CITY SPECIFICATIONS.
- 3. ALL MATERIALS ARE TO BE COMPACTED TO 95% OF ASTM D-1557

DRAINAGE TRENCH

NOT TO SCALE

NOTE: ALL UTILITIES SHALL BE REVIEWED AND APPROVED BY APPROPRIATE UTILITY COMPANY UTILITY TRENCH NOT TO SCALE

CATV CABLE

36" (12" MIN.)

PLASTIC MARKER TAPE ABOVE CABLES

ELECTRIC SERVICE CABLES 250 VAC OR LESS PVC-SCH 40

-FULL MORTAR BED (PORTLAND TYPE II CEMENT) ADJUST TO GRADE WITH HARD BRICK GRADE SS (MIN. 2 COURSES, MAX. 5 COURSES OR 12" MAX. ADJUSTMENT) 30" DIA. CLEAR OPENING PRECAST CONCRETE UNITS SHALL CONFORM TO ASTM C-47B -CLASS "AA" CONCRETE 4000 P.S.I. 48" DIAMETER MIN. 5" MIN. REINFORCED 4" MAX. TO 3" MAX. -WATER TIGHT JOINT HARD BRICK WITH PORTLAND TYPE II CEMENT - A" MIN RETIDING IN EARTH 12" MIN. BEDDING IN LEDGE (ASTM C33-03 NO. 67 STONE)

OTES:

C33-03 NO. 67 STONE)

PER NHOES ENV-WQ 704.13(C), MORTAR USED IN MANHOLE CONSTRUCTION SHALL COMPLY WITH THE FOLLOWING:

O MORTAR SHALL BE COMPOSED OF TYPE II PORTLAND CEMENT AND SAND WITH OR WITHOUT HYDRAFTED LINE ADDITION

D. PROPORTIONS IN MORTAR OF PARTS BY VOLUMES SHALL BE PER TABLE 704-4:

(1) 4.5 PARTS SAND, ONE PARTS EDIENT; OR

(2) 4.5 PARTS SAND, ONE PART CEMENT AND 0.7 PART HYDRATED LINE:
C. CEMENT SHALL BE TYPE II FORTLAND CEMENT THAT IS CERTIFIED BY ITS MANUFACTURER AS CONFORMING TO THE ASTM CISO/CISOM STANDARD IN LEFTECT AT THE TIME THE CEMENT WAS MANUFACTURED LINE WAS ADDITED USED SHALL BE TYPE S THAT IS CERTIFIED BY ITS MANUFACTURER AS CONFORMING TO THE ASTM CISO/CISOM STANDARD IN EFFECT AT THE TIME THE HYDRATED LINE WAS PROCESSED SAND SHALL CONSIST OF INERT NATURAL SAND THAT IS CERTIFIED BY ITS SUPPLIER AS CONFORMING TO THE ASTM CISO STANDARD IN EFFECT AT THE TIME THE THE ENE SAND IS PROCESSED.

5. SAND SHALL CONSIST OF INERT NATURAL SAND THAT IS CERTIFIED BY ITS SUPPLIER AS CONFORMING TO THE ASTM CISO STANDARD IN EFFECT AT THE TIME THE BUE SAND IS PROCESSED BY STANDARD SPECIFICATIONS FOR CONCRETE, FIRE AGGREGATES.

6. CONCRETE FOR DROP SUPPORTS SHALL CONFORM TO THE REQUIREMENT FOR CLASS ANA CONCRETE OF THE NEW HAMPSHERE DEPARTMENT OF TRANSPORTATIONS STANDARD SPECIFICATIONS FOR ROAD AND BRIDGE CONSTRUCTION AS AVAILABLE AT:

HTTD: //WWW.W.B.GOV/TOO/TOO/GOO/GOORDET FOR SETTING MORE AVAILABLE AT:

HTTP: //WWW.NH.GOV/DOT/ORG/PROJECTDEVELOPMENT/HIGHWAYDESIGN/SPECIFICATIONS/INDEX.HT

- ALL MANHOLES SHALL BE TESTED FOR LEAKAGE IN ACCORDANCE WITH ENV-WO 704.17 (d) THROUGH
- 4. SEWER MANHOLE COVERS SHALL CONFORM TO ASTM A48/48M WITH A CASTING EQUAL TO CLASS 30 IN ACCORDANCE WITH ENV-WQ 704.13 (q) (8).
- ALL PRECAST SECTIONS SHALL BE COATED ON THE EXTERIOR WITH A BITUMINOUS DAMP-PROOFING COATING IN ACCORDANCE WITH ENV-WQ 704.12 (J).
- ALL PRECAST SECTIONS AND BASES SHALL HAVE THE DATE OF MANUFACTURE AND TI TRADEMARK OF THE MANUFACTURER IMPRESSED OR INDELIBLY MARKED ON THE INSIDE
- 7. BRICK MASONRY SHALL CONFORM TO ASTM C32 (ENV-WQ 704.12(a)(9))

SEWER MANHOLE

NOT TO SCALE

Plan Name

DETAIL SHEET

DRAWING No.

SHEET 45 OF 55

JBE PROJECT NO. 21090


BAYBERRY COMMONS 19 OLD GONIC ROAD, ROCHESTER, NH Project: LEO P. LACOUTURE REV. TRUST & WILLIAM B. LACOUTURE 19 OLD GONIC RD., ROCHESTER, NH 03867 BK 4093 PG 148

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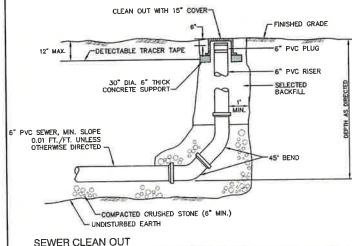
19	10/31/23	ISSUED FINAL PLANS	LAZ
18	9/12/23	REVISED PER TOWN COMMENTS	LAZ
17	8/24/23	REVISED PER TOWN COMMENTS	LAZ
16	6/14/23	REVISED OFFSITE PLANS	LAZ
15	5/23/23	REVISED PER CONDITIONS OF APPROVAL	LAZ
REV.	DATE	REVISION	BY


Designed and Produced in NH Jones & Beach Engineers, Inc. 603-772-4746 85 Portsmouth Ave. Civil Engineering Services FAX: 603-772-0227 E-MAIL: JBE@JONESANDBEACH.COM



PRECAST CONCRETE HEADWALL

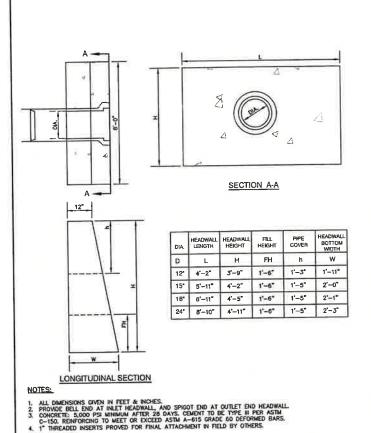NOT TO SCALE



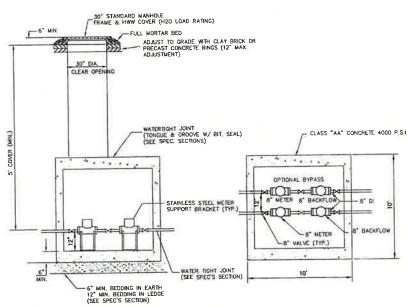

ELEVATION

PLAN VIEW

NOTES

1. METER TO BE SENSUS OMNI 02 OF APPROPRIATE SIZE.

2. BACKFLOW TO BE TESTABLE DOUBLE CHECK VALVE ASSEMBLY WITH CENTER-SHAFT OR TOP HINGE CHECKS (MILKINS 350AST OR EQUAL) OF APPROPRIATE SIZE, IF APPLICATION IS DESIDED LOW HAZARD.

3. OPTIONAL BYPASS MY DE SIZED FOR DOMESTIC SERVEC ONLY.


5. VALLT COURSES TO BE STAMPED WITH "REPORT AND MATCH EXISTING CITY OF ROCHESTER INFRASTRUCTURE STAMPADS WITH "REPORT FOR MAINTENED, LESTING AND SERVICE.

6. ISCALATION VALVES REQUIRED AROUND EQUIPMENT FOR MAINTENCE, TESTING AND SERVICE.

7. IF APPLICATION IS DESIGNATED HICH HAZARD, THE ASSEMBLY MUST USE MPZ BACKFLOW DEMCES AND BE LOCATED IN AN ADONE GRADE, HEATED AND INSULATED ENLICOSITE TO ALLOW FOR DRAINING.

8. VAULT AND ACCESS HATCHES SHALL BE SIZED TO ALLOW ENTRY FOR INSPECTION, TESTING AND COMPLETE REPLACEMENT OF DEVICES.


WATER METER PIT ROCHESTER

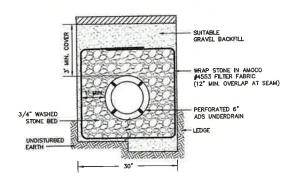

- 1. PAVEMENT REPAIR IN EXISTING ROADWAYS SHALL CONFORM TO STREET OPENING REGULATIONS.
- 2. NEW ROADWAY CONSTRUCTION SHALL CONFORM TO PROJECT AND CITY SPECIFICATIONS.
- 3, SLOPE UNDERDRAIN PIPE TO DAYLIGHT

ROADWAY UNDERDRAIN TRENCH


NOT TO SCALE

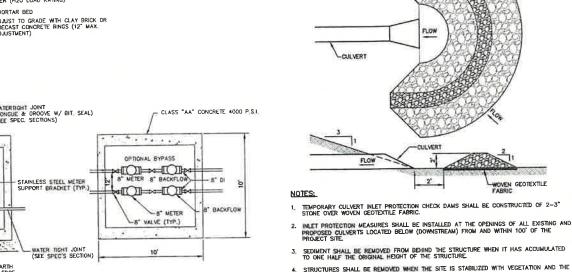

- STRUCTURES SHALL BE REMOVED WHEN THE SITE IS STABILIZED WITH VEGETATION AND THE CHANNEL SHALL BE SMOOTHED AND REVEGETATED.


TEMPORARY CULVERT INLET PROTECTION CHECK DAM

NOT TO SCALE

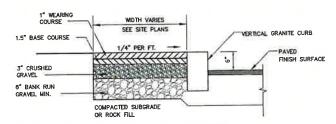

BIT. SIDEWALK W/ VERTICAL GRANITE CURB


NOT TO SCALE

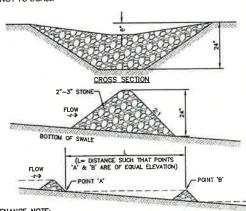

1. STONE CHECK DAMS SHOULD BE CHECKED AFTER EACH RAINFALL AND AT LEAST DALLY DURING PROLONGED RAINFALL. ANY NECESSARY REPAIRS SHOULD BE MADE IMMEDIATELY. PARTICULAR ATTENTION SHOULD BE GYES OF THE PROSON AT THE DOWNSTREAM TOE OF THE STRUCTURE HERE THE DISTRUCTURES ARE RELIGIOUS. THE DISTRUCTURE DOWNSTREAM TOE OF THE EXISTING CHANNEL GRADE AND THE SPEPARED, SEEDED AND MULCHED. WHILE THIS PRACTICE IS NOT INTENDED TO BE USED PROMARY FOR SEDIMENT TRAPPING, SOME SEDIMENT WILL ACCUMULATE BEHIND THE STRUCTURES. SEDIMENT SHALL BE REMOVED FROM BEHIND THE STRUCTURES WHEN IT HAS ACCUMULATED TO GIVE HALF OF THE ORIGINAL HEIGHT OF THE STRUCTURE.

STONE CHECK DAM


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MAINTENANCE NOTE:

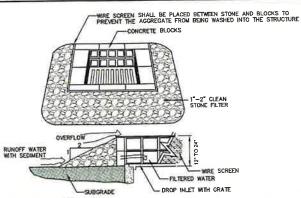1. ALL STRUCTURES SHOULD BE INSPECTED AFTER EVERY RAINFALL AND REPAIRS MADE AS NECESSARY. SEDMENT SHOULD BE REMOVED FROM TRAPPIND DEVICES AFTER THE SEDMENT HAS REACHED A MAXIMUM OF ONE HALF THE DEPTH OF THE TRAP. THE SEDMENT SHOULD BE DISPOSED IN A SUITABLE UPLAND AREA AND PROTECTED FROM EROSON BY EITHER STRUCTURE OR VEGETATIVE MEANS. THE TEMPORARY TRAPS SHOULD BE REMOVED AND THE AREA REPAIRED AS SOON AS THE CONTRIBUTING DRAINAGE AREA TO THE INLET HAS BEEN COMPILETELY STABILIZED.

TEMPORARY CATCH BASIN INLET PROTECTION (Block and Gravel Drop Inlet Sediment Filter)





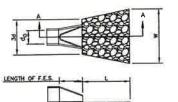

SECTION A-A PIPE OUTLET TO FLAT AREA WITH NO DEFINED CHANNEL

SECTION A-A PIPE OUTLET TO WELL-DEFINED CHANNEL

TABLE 7-24	RECOMMENDED	RIP RAP GE	TADAS	ION RANGES
THICKNESS OF	RIP RAP = 1.	5 FEET		
d50 SIZE=	0.50	FEET	6	INCHES
% OF WEIGHT S THAN THE GIVE		SIZE OF FROM	STO	NE (INCHES) TO
100%		9		12
85%		8		11
50%		6		9
15%		2		3

- The subgrade for the geotextile fabric and RIP RAP shall be prepared to the lines and grades shown on the plans.
- 2. THE RIP RAP SHALL CONFORM TO THE SPECIFIED GRADATION.
- 3. GEOTEXTILE FABRICS SHALL BE PROTECTED FROM PUNCTURE OR TEARING DURING THE PLACEMENT OF THE ROCK RP. DIAMAGED AREAS IN THE FABRIC SHALL BE REPARRED BY PLACING A PIECE OF FABRIC OVER THE DIAMAGED AREA OR BY COMPLETE REPLACEMENT OF THE FABRIC, ALL OVERLAPS REQUIRED FOR REPAIRS OR JOINNO TWO PIECES OF FABRIC SHALL BE A MINIMUM OF 12 INCHES.
- 4. STONE FOR THE RIP RAP MAY BE PLACED BY EQUIPMENT AND SHALL BE CONSTRUCTED TO THE FULL LAYER THICKNESS IN ONE OPERATION AND IN SUCH A MANNER AS TO PREVENT SEGREGATION OF THE STONE SIZES.
- 5. OUTLETS TO A DEFINED CHANNEL SHALL HAVE 2:1 OR FLATTER SIDE SLOPES AND SHOULD BEGIN AT THE TOP OF THE CULVERT AND TAPER DOWN TO THE CHANNEL BOTTOM THROUGH THE LENGTH OF THE APRON.
- 6. MAINTENANCE: THE OUTLET PROTECTION SHOULD BE CHECKED AT LEAST ANNUALLY AND AFTER EVERY MAJOR STORM. IF THE RIP RAP HAS BEEN DISPLACED, UNDERWINDED OR DAMAGED, IT SHOULD BE REPAIRED IMMEDIATELY. THE CHANNEL IMMEDIATELY BELOW THE OUTLET SHOULD BE CHECKED TO SEE THAT EROSON IS NOT OCCURRING. THE DOWNSTREAM CHANNEL SHOULD BE KEPT CLEAR OF OBSTRUCTIONS SUCH AS FALLEN TREES, DEBRIS, AND SEDIMENT THAT COULD CHANGE FLOW PATTERNS AND/OR TALWARTER DEPTHS ON THE PIPES. REPAIRS MUST BE CARRIED OUT IMMEDIATELY TO AVOID ADDITIONAL DAMAGE TO OUTLET PROTECTION.

RIP RAP OUTLET PROTECTION APRON

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18	9/12/23	REVISED PER TOWN COMMENTS	LAZ
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15	5/23/23	REVISED PER CONDITIONS OF APPROVAL	LAZ
REV.	DATE	REVISION	BY


Designed and Produced in NH

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85 Portsmouth Ave PO Box 219	Civil	Eng	ineering	Services	FAX: 603	3-772-0227
Stratham, NH 03885				E-MAIL: JBE@	JONESANDBE	ACH COM

Plan Name:	DETAIL SHEET
Project:	BAYBERRY COMMONS 19 OLD GONIC ROAD, ROCHESTER, NH
Owner of Record	LEO P. LACOUTURE REV. TRUST & WILLIAM B. LACOUTURE

SHEET 46 OF 55 JBE PROJECT NO. 21090

DRAWING No.

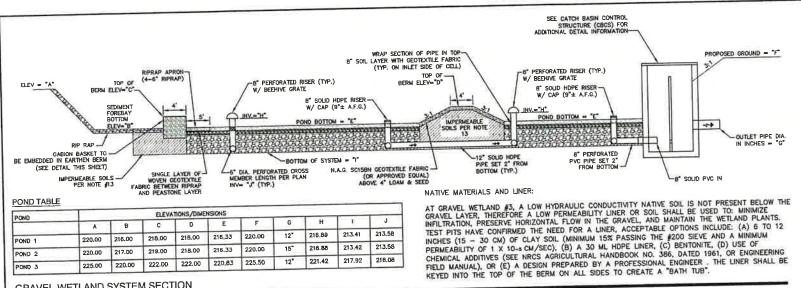

ELEVATIONS/DIMENSIONS G D E 216.89 213.41 213.58 12" 216,33 220.00 218.00 218.00 POND 1 216.88 213.42 213.58 220.00 217.00 219.00 218.00 215.33 220.00 15" POND 2 12" 221.42 217.92 218.08 225.00 220.00 222.00 222.00 220.83 225.50

GRAVEL WETLAND SYSTEM SECTION


NOT TO SCALE

1 LOW HYDRAULIC CONDUCTIVITY (0.1-0.01 FT/DAY) 2. A BLEND OF LOAM, SAND, AN SOME FINE SOILS WITH MORE THAN 15% ORGANIC MATTER 3. AVOID A FINAL SOIL MIX WITH CLAY CONTENT IN EXCESS OF 15% 50 AS NOT TO ENCOURAGE DRYING AND CRACKING: ALLOWING THE MIGRATION OF PINES INTO THE SUBSURFACE LAYERS

WETLAND SOIL (TYP.) SEEDED WITH WETLAND MIX Nº MIN. THICKNESS OF 3/8" CLEAN PEA STONE CHOKER COURSE 24" - 3/4" CLEAN CRUSHED STONE TREATMENT COURSE

GRAVEL WETLAND POND BOTTOM CROSS SECTION (FIG-2)

NOT TO SCALE

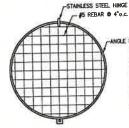


	(A)	®	0	0	(E)	(f)	0
POND 1	2.0	216.00	216.00	12"	218.50		
POND 2	2.5*	216.00	216.00	15°	219.00	217.86	36
POND 3	3.0"	220.50	220.50	12"	223.50	==	

WETLAND SOIL SPEC:

POND STRUCTURE COVER

NOT TO SCALE

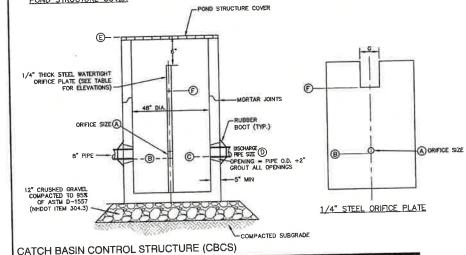

GRAVEL WETLAND CONSTRUCTION NOTES

- THE CONTRACTOR WILL NOTIFY JONES AND BEACH ENGINEERS AFTER EACH OF THE GRAVEL WETLAND PORDS HAVE BEEN EXCAVATED TO THE BOTTOM OF THE SYSTEM FOR A MANDATORY INSPECTION PRIOR TO BUILDING BERNS, PLACING STONE OR INSTALLING PIPE SYSTEM.
- NO-GEOTEXTILE OR GEOFABRIC LAYERS ARE USED WITHIN THIS SYSTEM, BUT MAY BE USED TO LINE WALLS.
- 3. IF A NATIVE LOW HYDRAULIC CONDUCTIVITY SOIL IS NOT PRESENT BELOW THE DESIRED LOCATION OF THE SOW, A LOW PERMEABILITY LINER OR SOIL (HYDRAULIC CONDUCTIVITY LESS THAN 0.03 FT/DAY) BELOW THE GRAVEL LAYER SHOULD BE USED TO MINIBLEZ BIRLTATION, PRESENTE HORIZONTAL FLOW IN THE GRAVEL, AND MAINTAIN THE WETLAND PLANTS (FIGURE 2).
- 8 IN. MINIMUM THICKNESS OF A WETLAND SOIL AS THE TOP LAYER. (SEE DESCRIPTION IN SURFACE INFILTRATION RATES SECTION FOR DETAILS (FIGURE 2)). THIS LAYER IS LEVELED (CONSTRUCTED WITH A SURFACE SLOPE OF ZERO)
- J. NI, MINIMUM THICKNESS OF AN INTERMEDIATE LAYER OF A GRADED ACCREGATE FILTER IS NEEDED TO PREVENT THE WEILAND SOL FROM MOVING DOWN INTO THE GRAVEL SUB-LAYER. MATERIAL COMPATIBILITY BETWEEN LAYERS NEEDS TO BE EVALUATED.
- 24 IN. (0.6 M) MINIMUM THICKNESS OF 3/4" CRUSHED-STONE SUB-LAYER. THIS
 IS THE ACTIVE ZONE WHERE TREATMENT OCCURS (FIGURE 2).
- 7. THE PRIMARY CUILET INVERT SHALL BE LOCATED 4" BELOW THE ELEVATION OF THE WETLAND SOIL SURFACE TO CONTROL GROUNDWATER ELEVATION. CARE SHOULD BE TAKEN TO NOT DESIGN A SIPHON THAT WOULD BRAIN THE WETLAND: THE PRIMARY OUTSET LOCATION MUST BE OPEN OF WENTED. IN CONTRAST TO FIGURE 1, THE PRIMARY OUTSET CAN BE A SMPLE PIPE.
- AN OPTIONAL HIGH CAPACITY OUTLET AT EQUAL ELEVATION OR LOWER TO THE PRIMARY OUTLET MAY BE INSTALLED FOR MAINTENANCE. THUS OUTLET WOULD NEED TO BE PLUGGED DURING REGULAR OPERATION. THIS OPTIONAL CUITLET ALLOWS FOR FLUSHING OF THE TREATMENT CELLS AT HIGHER FLOW RATES. IF IT IS LOCATED LOWER, IT CAN BE USED TO DRAIN THE SYSTEM FOR MAINTENANCE OR REPAIRS.
- 10. THE MINIMUM SPACING BETWEEN THE SUBSURFACE PERFORATED DISTRIBUTION LINE AND THE SUBSURFACE PERFORATED COLLECTION DRAIN (SEE FIGURE 1) AT EITHER END OF THE GRAVEL IN EACH TREATMENT COLL IS 15 FT, THERE SHOULD BE A MINIMUM HORIZONTAL TRAVEL DISTANCE OF 15 FT WITHIN THE GRAVEL LAYER IN EACH CELL.
- 11. VERTICAL PERFORATED OR SLOTTED RISER PIPES DELIVER WATER FROM THE SURFACE DOWN TO THE SUBSURFACE, PERFORATED OR SLOTTED DISTRIBUTION LINES. THESE RISERS SHALL HAVE A MAXIMUM SPACING OF 15 PEET (ROURE 1) OVERSIZING OF THE PERFORATED OR SLOTTED VERTICAL RISERS IS USEPTU. TO ALLOW A MARGIN OF SAFETY AGAINST CLOGGING WITH A MINIMUM RECOMMENDED DIAMETER OF 12 FOR THE CENTRAL RISER AND 6° FOR DISTRIBUTED. STAFELY AGAINST CLOGGING WITH A MINIMUM RECOMMENDED VERTICAL RISERS SHALL NOT BE CAPPED, BUT RATHER COVERED WITH AN INLET GRATE TO ALLOW FOR AN OVERFLOW WHEN THE WATER LEVEL EXCEEDS THE WOY.
- 12. VERTICAL CLEANOUTS CONNECTED TO THE DISTRIBUTION AND COLLECTION SUBDRAINS, AT EACH END, SHALL BE PERFORATED OR SUOTED ONLY THE GRAVEL LAYER, AND SOLID WITHIN THE WELLAND SOIL AND STORAGE AREA ABOVE. THIS IS IMPORTANT TO PREVENT SHORT—CIRCUITING AND SOIL PIPING.
- 13. BERMS AND WEIRS SEPARATING THE FOREBAY AND TREATMENT CELLS SHOULD BE CONSTRUCTED WITH CLAY, OR NON-COMDUCTIVE SOLS, AND/OR A FINE GEOTEXTILE, OR SOME COMBINATION THEREOF, TO AVOID WATER SEEPAGE AND SOL PRING THROUGH THESE EARTHEN DIVIDERS.
- 14. THE SYSTEM SHOULD BE PLANTED TO ACHEVE A RIGOROUS ROOT MAT WITH GRASSES, FORBS, AND SHRUBS WITH OBUGATE AND FACULTATIVE WETLAND SPOIDS. IN NORTHERN CLIMATES REFER TO THE NM STORMWATER MANUAL OR APPROVED EQUIVALENT LOCAL GUIDANCE FOR DETAILS ON LOCAL WETLAND PLANTINGS.
- SIDE SLOPES, EROSION CONTROL, USE OF RIP RAP FOR STABILIZED REGIONS AT OUTLETS AND OTHER LOCATIONS OF CONCENTRATED FLOW. ETC.
- 16. SEE LANDSCAPE PLAN FOR PLANTING DETAILS.
- GABION BASKET TO BE CONSTRUCTED OF 3mm GALVANIZED DOUBLE—TWST WRE MESH, MESH OPDING SHALL BE 100mm to 120mm, ROCK FILL TO BE 4"—D50 ROUNDED STONE. LARGER STONES TO BE PLACED TO THE OUTSIDE OF GABION BASKET WITH SMALLER STONE IN INTERIOR.

INSPECTION AND MAINTENANCE (GRAVEL WETLAND)

- THE CONTRACTOR WILL NOTIFY JONES AND BEACH ENGINEERS AFTER EACH OF THE GRAVEL WETLAND PONDS HAVE BEEN EXCAVATED TO THE BOTTOM OF THE SYSTEM FOR A MANDATORY INSPECTION PRIOR TO BUILDING BERMS, PLACING STONE OR INSTALLING PIPE SYSTEM.
- IST YEAR POST-CONSTRUCTION: INSPECTION FREQUENCY SHOULD BE AFTER EVERY MAJOR STORM IN THE FIRST YEAR FOLLOWING CONSTRUCTION.

- INSPECT TO BE CERTAIN SYSTEM DRAINS WITHIN 24-72 HRS (WITHIN THE DESIGN PERIOD, BUT ALSO NOT SO QUICKLY AS TO MINIMIZE STORMWATER TREATMENT!).

 WATERING PLANTS AS NECESSARY DURING THE FIRST GROWING SEASON

 RE-VEGETATING POORLY ESTABLISHED ARREA AS NECESSARY

 TREATING DISEASED VEGETATION AS NECESSARY

 QUARTERLY INSPECTION OF SOIL AND REPAIRING ERDOED AREAS, ESPECIALLY ON SLOPES

 CHECKING RULETS, OUTLETS, AND OVERFLOW SPILLWAY FOR BLOCKAGE, STRUCTURAL INTEGRITY,

 AND EMDENCE OF EROSION.
- POST-CONSTRUCTION: INSPECTION PREQUENCY SHOULD BE AT LEAST EVERY 6 MONTHS THEREAFTER, AS PER USEPA GOOD HOUSE-KEEPING REQUIREMENTS, INSPECTION FREQUENCY CAN BE REQUICED TO ANNUAL FOLLOWING 2 YEARS OF MONTIONIC THAT INDICATES THE RATE OF SEDIMENT ACCUMULATION IS LESS THAN THE CLEANING CRITERIA LISTED BELOW, INSPECTIONS SHOULD FOCUS ON:
- SLESS THAN THE CREANING CHIEFA LISTED BELOW, INSPECTIONS SHOULD FLOODS OF CHIEFACTORY OF THE WELLAND SURFACE. THOROUGH REVECETATION WITH GRASSES, FORES, AND SHRIBS IS NECESSARY, UNLIKE BIORETENTION, WHERE MULCH IS COMMONLY USED, COMPLETE SURFACE COVERAGE WITH VEGETATION IS NEEDED. CHECKING WHITE CREATER WELLAND IS NEEDED. CHECKING SUCH AS DISCOLORED OR ACCUMULATED SEDMENTS. CHECKING THE SEDMENTATION CHAMBER OR FOREBAY FOR SEDMENT ACCUMULATION, TRASH, AND DEBRIS.
 INSPECT TO BE CERTAIN THE SEDMENTATION FOREBAY DRAINS WITHIN 24 TO 72 HRS. INSPECT TO BE CERTAIN THE SEDMENTATION FOREBAY DRAINS WITHIN 24 TO 72 HRS. CHECKING BILLETS, OUTLETS, AND OVERFLOW SPILLWAY FOR BLOCKAGE, STRUCTURAL INTEGRITY, AND EXPOSED OF BEROSCO.

 MENONE OF DECATIVE VEGETATION, LITTER, AND DEBRIS.
 MOW GRASS AREAS PERIODICALLY SO THAT GRASS DOES NOT EXCEED 4° IN HEIGHT.

- IN CLEANING CRITERIA FOR ALL SEDIMENTATION FORBAYS: SEDIMENT SHOULD BE REMOVED FROM THE SEDIMENTATION CHAMBER (FOREBAY) WHEN IT ACCUMULATES TO A DEPTH OF MORE THAN 12 INCHES (30 CM) OR 10 PERCENT OF THE PRETICATION TO AMBRE HAN 12 INCHES (30 CM) OR 10 PERCENT OF THE PRETICATION TO AMBRE HAN WELLAND VEGETATION BECOMES DOMINANT. THE CLEANING INTERVAL IS ONCE EVERY YEAR. A DRY SEDIMENTATION ECONOMISM OF THE PRESENCE THIS CONDITION IS RARELY FOR THE SEDIMENTATION CHAMBER, FOREBAY, AND TREATMENT CELL OUTLET DEVICES SHOWN HE SEDIMENTATION THIS EXCEPTION OF DEVICES OF THE WELLAND SHOULD WHEN DRAWDOWN THIS EXCEPT OF THE SEDIMENTATION OF DISTURBING HAS DEVICED FOR THE WELLAND SHAPE OF THE SEDIMENTATION OF DISTURBED AREAS AS INCESSARY REMOVED SEDIMENTS SHOULD BE DEWATERED (IF NECESSARY) AND DISPOSED OF IN AN ACCEPTABLE MANNER.
- CLEANING ORDERIA FOR GRAVEL METLAND TREATMENT CELLS: SEDMENT SHOULD BE REMOVED FROM THE GRAVEL WETLAND SURFACE MEEN IT ACCUMILATES TO A DEPTH OF SEVERAL INCHES (>10 CM) ACROSS THE METLAND SURFACE. MATERIALS SHOULD BE REMOVED WITH RAVES RATHER THAN HEALTH CONSTRUCTION EXPLAND SURFACE. MEANY CONSTRUCTION OF THE GRAVEL METLAND SURFACE. MEANY CONSTRUCTION OF THE GRAVEL METLAND. THE GRAVEL METLAND WITH IS DESCRIBED WITH DIMENSIONS THAT ALLOW EQUIPMENT TO BE LIGHT AND THE DEFENDE STRUCTURE DEPLOYERS THE TO SELL METLAND. THE DEFENDE STRUCTURE DEPLOYERS THE TO SELL METLAND. TO PERMINE STRUCTURE DEPLOYERS THE PROPERTY SELVENDERS PROPERTY FOR THE PROPERTY OF THE PROPERTY SELVENDERS PROPERTY OF THE PROPERTY SELVENDERS PROPERTY OF THE PROPERTY SELVENDERS PROPERTY OF THE PROPERTY OF THE PROPERTY SELVENDERS PROPERTY OF THE PROPERTY OF THE PROPERTY OF THE PROPERTY SELVENDERS PROPERTY OF THE PROPERTY OF THE PROPERTY SELVENDERS PROPERTY OF THE TO BE LOCATED OUTSIDE THE GRAVEL WETLAND, WHILE A BACKHOE SHOVEL REACHES INSIGNATED WETLAND TO REMOVE SEDIMENTS, REMOVED SEDIMENTS SHOULD BE DEWATERED (IF NECESSARY) AND DISPOSED OF IN AN ACCEPTABLE MANNER.
- PRAINING AND FLUSHING GRAVEL WETLAND TREATMENT CELLS: FOR MAINTENANCE IT MAY BE NECESSARY TO DRAIN OR FLUSH THE TREATMENT CELLS. THE OPTIONAL DRAINS WILL PERMIT SIMPLER MAINTENANCE OF THE SYSTEM IF RECEIVED. THE ORDINAS NEED TO BE CLOSED DEWING STANDARD OPERATION. FLUSHING OF THE RISERS AND HORIZOTTAL SIDERANDS IS USED FERETIVE WITH THE ENTIRE SYSTEM DRAINED, FLUSHED WATER AND SEDIMENT SHOULD BE COLLECTED AND PROPERLY

(d50=3")

EMERGENCY SPILLWAY SECTION

FFFFFF


GEOTEXTILE FABRIC OR APPROVED EQUAL

EMERGENCY SPILLWAY PROFILE


RED MAPLE GREEN ASH AR ACER RUBRUM FP FRAXINUS PENNSYLVANICA DECIDUOUS SHRUBS: VD VIBURNUM DENTATUM AI ALIAUS INCANA CS CORNUS STOLONIFERA VC VACCINIUM CORYMBOS IV LLEX VERTICILLATA WETLAND SEED MIX: SC SCIRPUS CYPERRINUS SA SCIRPUS ATROVIRENS LE JUNCUS EFFUSUS CA CAREX LUPULINA CC CAREX CRINITA WETLAND SEEDING MIX (TYP.) SHRUBS-**1000**


GRAVEL WETLAND PLANTING SCHEDULE (FIG-1)

NOT TO SCALE

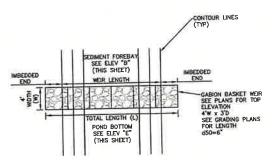

PLAN VIEW W/ EXAMPLE

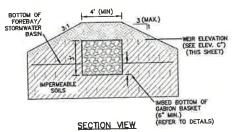

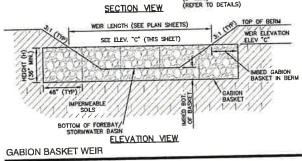

NOT TO SCALE

NOT TO SCALE

3' (TYP.)

WATER FLO

RIPRAP EMERGENCY SPILLWAY

Jones & Beach Engineers, Inc.

85 Portsmouth Ave. Civil Engineering Services

FAX: 603-772-0227 E-MAIL: JBE@JONESANDBEACH.COM


DETAIL SHEET Plan Name:

BAYBERRY COMMONS 19 OLD GONIC ROAD, ROCHESTER, NH

LEO P. LACOUTURE REV. TRUST & WILLIAM B. LACOUTURE 19 OLD GONIC RD., ROCHESTER, NH 03867 BK 4093 PG 148 Owner of Record:


SHEET 47 OF 55 JBE PROJECT NO. 21090

Design: JAC | Draft: LAZ 19 10/31/23 Checked: JAC Scale: AS NOTED Project No.: 21090 Drawing Name: 21090-PLAN.dwg 18 9/12/23 17 8/24/23 HIS PLAN SHALL NOT BE MODIFIED WITHOUT WRITTEN 16 6/14/23 ERMISSION FROM JONES & BEACH ENGINEERS, INC. (JBE). 15 5/23/23 Y ALTERATIONS, AUTHORIZED OR OTHERWISE, SHALL BE AT THE USER'S SOLE RISK AND WITHOUT LIABILITY TO JBE.

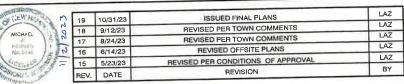


Designed and Produced in NH

PO Box 219 Stratham, NH 03885

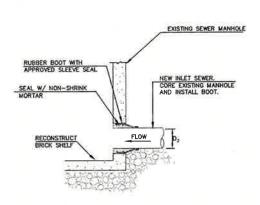

SEWER CONNECTION TO EXISTING STRUCTURE

NOT TO SCALE

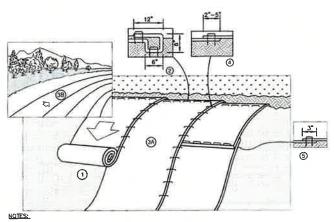

- 1. There shall be no plasic, or multi-filament or monofilament polypropylene netting or mesh with an opening size of greater than 1/8 inch material utilized.
- PREPARE SOIL BEFORE INSTALLING BLANKETS, INCLUDING ANY NECESSARY APPLICATION OF LIME, FERTILIZER, AND SEED, NOTE: WHEN USING CELL-O-SEED DO NOT SEED PREPARED AREA. CELL-O-SEED MUST BE INSTALLED WITH PAPER SIDE DOWN.
- 3. BEGIN AT THE TOP OF THE SLOPE BY ANCHORING THE BLANKET IN A 6" DEEP BY 6" WIDE TRENCH WITH APPROXIMATELY 12" OF BLANKET EXTENDED BEYOND THE UP-SLOPE PORTION OF THE TRENCH, ANCHOR THE BLANKET WITH A ROW OF STAPLES/STAKES APPROXIMATELY 12" APART IN THE BOTTOM OF THE TRENCH, APACKFILL AND COMPACT THE TRENCH AFTER STAPLING, APPLY SEED TO COMPACTED SOIL AND FOLD REMAINING 12" PORTION OF BLANKET BACK OVER SEED AND COMPACTED SOIL SCUEDE BLANKET OVER COMPACTED SOIL WITH A ROW OF STAPLES/STAKES SPACED APPROXIMATELY 12" APART ACROSS THE WIDTH OF THE BLANKET.
- 4. ROLL THE BLANKETS (A) DOWN OR (B) HORIZONTALLY ACROSS THE SLOPE. BLANKETS WILL UNROLL WITH APPROPRIATE SIDE AGAINST THE SOIL SURFACE. ALL BLANKETS MUST BE SCURELY FASTENED TO SOIL SURFACE BY PLACING STRAPES/STAKES IN APPROPRIATE LOCATIONS AS SHOWN IN THE STAPLE PATTERN. GUIDE, WHEN USING OPTIONAL DOT SYSTEMM, STAPLES/STAKES SHOULD BE PLACED THROUGH EACH OF THE COLOROD DOTS CORRESPONDING TO THE APPROPRIATE STAPLE PATTERN.
- THE EDGES OF PARALLEL BLANKETS MUST BE STAPLED WITH APPROXIMATELY 2"-5" OVERLAP
 DEPENDING ON BLANKET TYPE. TO ENSURE PROPER SEAM ALICHMENT, PLACE THE EDGE OF THE
 OVERLAPPING BLANKET (BLANKET BENG INSTALLED ON TOP) EVEN WITH THE COLORED SEAM STITCH ON
 THE PREVIOUSLY INSTALLED BLANKET.
- 6). CONSECUTIVE BLANKETS SPLICED DOWN THE SLOPE MUST BE PLACED END OVER END (SHINGLE STYLE) WITH AN APPROXIMATE 3" OVERLAP, STAPLE THROUGH OVERLAPPED AREA, APPROXIMATELY 12" APART ACROSS ENTIRE BLANKET WIDTH, NOTE; IN LOOSE SOIL CONDITIONS, THE USE OF STAPLE OR STAKE LENGTHS GREATER THAN 6" MAY BE NECESSARY TO PROPERLY SECURE THE BLANKETS.



NORTH AMERICAN GREEN 14649 HIGHWAY 41 NORTH EVANSVILLE, INDIANA 47725 1-800-772-2040

EROSION CONTROL BLANKET SLOPE INSTALLATION

NORTH AMERICAN GREEN (800) 772-2040

Checked: JAC Scale: AS NOTED Project No.:21090
Trawing Name: 21090-PLAN.dwg

RMISSION FROM JONES & BEACH ENGINEERS, INC. (JBE).

ANY ALTERATIONS AUTHORIZED OR OTHERWISE SHALL BE

AT THE USER'S SOLE RISK AND WITHOUT LIABILITY TO JBE.



19 10/31/23 LAZ ISSUED FINAL PLANS LAZ 18 9/12/23 REVISED PER TOWN COMMENTS LAZ 17 8/24/23 REVISED PER TOWN COMMENTS 16 6/14/23 LAZ REVISED OFFSITE PLANS LAZ 15 5/23/23 REVISED PER CONDITIONS OF APPROVAL REV. DATE REVISION BY

INSIDE DROP MANHOLE

NOT TO SCALE

U-CUT 3/4 PIPE DEPTH

CALDER STYLE COUPLING-

S.S. REMOVABLE BAND

12° 7

STREET FERROUS MET/ ROD OR PIPE (SEE NOTE 11) ALL AROUND CLEANOUT ISEE DETAIL 1/2 TO 3/4 INCH CRUSHED STONE -BASEMEN' ADAPTER AS NECESSARY L STREET SEWER HOUSE SEWER SERVICE NOTE SOLID COUPLING REDUCER ARE REQUIRED AT ALL TRANSITIONS SEALED CAP-- SULTABLE 45" WYE PUC-BEDDING TO BE COMPACTED (SEE NOTE 10) 6" SOLID PVC 1% MIN. SLOPE FROM BLDG CROSS-SECTION CLEANOUT DETAIL

S.S. ANCHOR BOLT WELDED TO S.S. BAND


- MODIFIED PVC ELBOW

(WITH BELL REMOVED)

MANHOLE WALL

HOUSE SEWER SERVICE

NOT TO SCALE

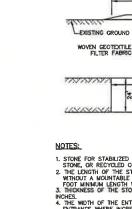

50' MINIMUM (75' W/O MOUNTABLE BERM)

50' MINIMUM (75 W/O MOUNTABLE BERM)

PROFILE

EXISTING PAVEMENT

PAVEMENT

STONE FOR STABILIZED CONSTRUCTION ENTRANCE SHALL BE 3 INCH STONE, RECLAIMED STONE, OR RECYCLED CONCRETE EQUIVALENT.

2 THE LIBERTH OF THE STABILIZED ENTRANCE SHALL NOT BE LESS THAN 50 FEET, 75' WITHOUT A MOUNTABLE BERM, AND EXCEPT FOR A SINCLE RESIDENTIAL LOT WHERE A 30 FOOT MINIQUE LENGTH WOULD APPLY.

3. THICKNESS OF THE STONE FOR THE STABILIZED ENTRANCE SHALL NOT BE LESS THAN 6 INCLUSE.

PLAN VIEW

- 3. THICKNESS OF THE STONE FOR THE STABILIZED ENTRANCE SHALL NOT BE LESS THAN 6 INCHES.

 4. THE WOTH OF THE ENTRANCE SHALL NOT BE LESS THAN THE FULL WIDTH OF THE ENTRANCE WHERE INGRESS OR EGRESS OCCURS, OR 10 FEET, WHICHEVER IS GREATER, 5. GEOTEXTILE FILTER FABRIC SHALL BE PLACED OVER THE ENTIRE AREA PRIOR TO PLACING THE STONE, FILTER FABRIC SHALL BE PLACED OVER THE STONE READER FOR TO PLACING FILL SUFFACE WATER THAT IS FLOWING TO OR DIVERTED TOWARD THE CONSTRUCTION ENTRANCE SHALL BE PIPED BENEATH THE ENTRANCE IF PIPHING IS IMPRACTICAL, A STONE BERM WITH 5:1 SLOPES THAT CAN BE CROSSED BY VEHICLES MAY BE SUBSTITUTED FOR THE PIPE.

 7. THE ENTRANCE SHALL BE PRANTAINED IN A CONDITION THAT WILL PREVENT TRACKING OR FLOWING OF SEDIMENT ONTO THE PUBLIC RICHT-OF-WAY. THIS MAY REQUIRE PERIODIC TOP DRESSING WITH ADDITIONAL STONE AS CONDITIONS DEMAND AND REPAIR AND/OR CLEAN OUT OF ANY MEASURES USED TO TRAP SEDIMENT. ALL SEDIMENT SPILLED, WASHED, OR TRACKED ONTO THE PUBLIC RIGHT-OF-WAY MUST BE REMOVED PROMPTLY.

STABILIZED CONSTRUCTION ENTRANCE

NOT TO SCALE

NOTES: 1. MINIMUM SIZE PIPE FOR HOUSE SERVICE SHALL BE 6 INCHES.

2. PIPE AND JOINT MATERIALS:

- A VITRIFIED CLAY PIPE:

 1. PIPE AND BITTINGS SHALL BE EXTRA STRENGTH CLAY PIPE CONFORMING TO THE REQUIREMENTS OF ASTM C-700.

 2. JOINTS SHALL BE MADE WITH OIL RESISTANT CASKETS IN ACCORDANCE WITH ASTM C-425 TYPE III MANUFACTURERS INSTRUCTIONS FOR INSTALLATION SHALL BE FOLLOWED.
- B. UP.V.C. (POLY VINYL CHLORIDE) PIPE:

 1. PIPE AND FITTINGS SHALL CONFORM TO THE MOST RECENT REQUIREMENTS OF ASTM SPECIFICATIONS FOR TYPE PSM POLY VINYL CHLORIDE (P.V.C.) SEWER PIPE AND FITTINGS, DESIGNATION D-3034 AND ASTM SPECIFICATIONS FOR SEWER PIPE, JOINTS USING ELASTOMERIC SEALS, DESIGNATION D-3212.

 2. JOINTS SHALL BE OF THE ELASTOMERIC GASKET TYPE. SOLVENT CEMENT JOINTS SHALL BY
- C. CAST IRON PIPE FITHINGS AND JOINTS

 1. CAST IRON PIPE AND FITHINGS AND JOINTS


 1. CAST IRON PIPE AND FITHINGS SHALL CONFORM TO THE FOLLOWING STANDARDS OF THE AMERICAN NATIONAL STANDARDS INSTITUTE: A21.1 THICKNESS DESIGN OF CAST IRON PIPE A21.4 CEMENT MORTAR LINING FOR CAST IRON PIPE A21.6 CAST IRON PIPE CENTRIFUGALLY CAST IN METAL MOLDS FOR WATER OR OTHER LIQUIDS. A21.8 CAST IRON PIPE CENTRIFUGALLY CAST IN SAND LINED MADJO FOR WATER OR OFFICE AND ADDRESS OF THE TROUGH AS INCHES FOR WATER AND OTHER LIQUIDS. 2 MORTES THE MOLDS AND ADDRESS OF THE MECHANICAL OR PUSH ON TYPE JOINTS AND CASTERS SHALL CONFORM TO: A21.11 RUBBER GASKET JOINTS FOR CAST IRON PRESSURE PIPE AND FITTINGS.
- D. DUCTILE IRON PIPE, FITTINGS AND JOINTS

 1. DUCTILE IRON PIPE, FITTINGS AND JOINTS

 1. DUCTILE IRON PIPE AND FITTINGS SHALL CONFORM TO THE STANDARDS OF THE UNITED STATES OF AMERICA STANDARDS INSTITUTE: A21.50 THICKNESS DESIGN OF DUCTILE IRON PIPE AND WITH ASTM A536 DUCTILE IRON CASTINGS A21.51 DUCTILE IRON PIPE CENTRIFUGALLY CAST IN METAL MOLDS OR SAND LINED MOLDS FOR WATER OR OTHER LIQUIDS.


 2. JOINTS SHALL BE AS SPECIFIED IN C2 ABOVE, CAST IRON PIPE JOINTS.
- 3. DAMAGED PIPE SHALL BE REJECTED AND REMOVED FROM THE JOB SITE.
- 4. JOINTS SHALL BE DEPENDENT UPON A NEOPRENE OR ELASTOMERIC GASKET FOR WAIERTIGHTNESS. ALL JOINTS SHALL BE PROPERLY MATCHED WITH THE 1PPE MATERIALS USED. WHERE DIFFERING MATERIALS ARE TO BE CONNECTED, AS IT THE STREET SEWER "Y OR AT THE FOUNDATION WALL, APPROPRATE ADAPTERS SHALL BE USED.
- 5. U "T AND "Y WHERE A "T OR "Y IS NOT AVAILABLE IN THE EXISTING STREET SEMER, AN APPROPRIATE CONNECTION! SHALL BE MADE IN THE SEMER, FOLLOWING CEMENTE OS SADDLE TAPPED INTO A SMOOTHLY DRILLED OR SAWN OPENING THE FRACTICE OF BREADING AN OPENING WITH A SLEDGE HAMMER, STUPFING CLOTH (OR OTHER SUCH MATERIAL) AROUND THE JOINT, OR APPLING MORTAR TO HOLD THE CONNECTION AND ANY OTHER SMILLS ROUDE PRACTICES OR NIET OR RASTY IMPROVISATIONS WILL NOT BE PERMITTED. THE CONNECTION SHALL BE CONCRETE ENCASED, AS SHOWN IN THE DETAIL, UP TO AND INCLUDING 15" DIAMETER.

- 6. PIPE INSTALLATION. U THE PIPE SHALL BE HANDLED, PLACED AND JOINTED IN ACCORDANCE WITH INSTALLATION CUIDES OF THE APPROPRIATE MANUFACTURER. IT SHALL BE CAREFULLY BEDDED ON A 4 INCH LAYER OF CRUSHED STONE AND/OR GRAVEL, AS SPECHED IN NOTE 10, BEDDING AND RE-FILL FOR A DEPTH OF 12 INCHES AGOVE THE TOP OF THE PIPE SHALL BE CAREFULLY AND THOROUGHLY TAMPED BY HAND OR WITH APPROPRIATE MECHANICAL DEVICES. THE PIPE SHALL BE LAD AT A CONTINUOUS AND SECOND OF THE PIPE SHALL BE CAREFULLY AND THOROUGHLY TAMPED BY HAND OR WITH APPROPRIATE MECHANICAL DEVICES. THE PIPE SHALL BE LAD AT A CONTINUOUS AND SECOND OF THE PIPE SHALL BE LAD AND A CONTINUOUS AND SECOND OF THE PIPE SHALL BE LAD AND SECOND OF THE PIPE SHALL BE LAD AND SECOND OF THE PIPE SHALL BE LAD AND SECOND OF THE PIPE SHALL BE TAKEN TO DEWATER THE TRENCH.
- TESTING: THE COMPLETED HOUSE SEWER SHALL BE SUBJECTED TO A LEAKAGE TEST IN ANY OF THE FOLLOWING MANNERS (PRIOR TO BACKFILLING):
 - A. AN OBSERVATION "I" SHALL BE INSTALLED AS SHOWN, WHEN READY TESTING, AN INFLATABLE BLADDER OR PLUG SHALL BE INSERTED JUST DESTREAM FROM THE OPENING IN ITHE "I". AFTER INFLATION, WATER SHALL BE INTRODUCED INTO THE SYSTEM ABOVE THE PLUG TO A HEIGHT OF 5 FEET ABOVE THE LEVEL OF THE PLUG.
 - B. THE PIPE SHALL BE LEFT EXPOSED AND LIBERALLY HOSED WITH WATER TO INVILATE, AS NEARLY AS POSSIBLE, WET TRENCH CONDITIONS. IF THE TRENCH IS WET, THE GROUND WATER SHALL BE PERMITED TO RISE IN THE TRENCH OVER THE PIPE, INSPECTIONS FOR LEAKS SHALL BE MADE THROUGH THE CLEANOLY WITH A FLASHLIGHT. *POSES NOT APPLY TO INSTALLATIONS WHERE "TS" AND "YS" ARE USED
 - C. DRY FLUORESCENT DYE SHALL BE SPRINKLED INTO THE TRENCH OVER THE PIPE. IF THE TRENCH IS DRY, THE PIPE SHALL BE LIBERALLY HOSED WITH WATER. IF THE TRENCH IS WET, GROUND WATER SHALL BE PERMITTED TO RISE IN THE TRENCH OVER THE PIPE. OBSERVATION FOR LEAKS SHALL BE MADE IN THE FIRST MANNICLE DOWNSTREAM. LEAKAGE OBSERVED IN ANY OF THE ABOVE, ALTERNATE TESTS SHALL BE CAUSE FOR NON-ACCEPTANCE AND THE PIPE SHALL BE DUG UP, IF NECESSARY, AND RELAID SO AS TO ASSURE WATERTICHTNESS.
- ILLEGAL CONNECTION: NOTHING BUT SANITARY WASTE FLOW FROM THE HOUSE TOILETS, SIMS, LAUNDRY, ETC. SHALL BE PERMITTED. ROOF LEADERS, FOOTING DRAINS, SUMP PUMPS OR ANY OTHER SIMILAR CONNECTION CARRYING RAIN WATER, DRAINAGE OR GROUND WATER SHALL NOT BE PERMITTED.
- HOUSE WATER SERVICE SHOULD NOT BE LAID IN THE SAWE TRENCH AS THE SEWER SERVICE, BUT WHEN INCESSARY, SHALL BE PLACED ABOVE AND TO ONE SIDE OF THE HOUSE SEWER AS SHOWN.
- 10. BEDDING: SCREENED GRAVEL AND/OR CRUSHED STONE FREE FROM CLAY, LOAM, ORGANIC MATERIAL AND MEETING ASTM C33-67. 100%—PASSING 37. INCH SCREEN 80-100%—PASSING 37. INCH SCREEN 80-100%—PASSING 37. INCH SCREEN 80-100%—PASSING 38. SEVE 0-5%—PASSING 38. SIEVE WHERE OFFICE BY THE ENGINEER TO STABLILE THE TRENCH BASE, SCREENED GRAVEL OR CRUSHED STONE (1/2 TO 3/4 INCH) SHALL BE USED.
- 11. LOCATION: THE LOCATION OF THE "T" OR "Y" SHALL BE RECORDED AND FILED IN THE MUNICIPAL RECORDS. IN ADDITION, A FERROUS METAL ROD OR PIPE SHALL BE PLACED OVER THE "T" OR "Y", AS DESCRIBED IN THE TYPICAL "CHIMME" DETAIL, TO AID IN LOCATING THE BURIED PIPE WITH A DIP NEEDLE OR PIPE FINDER.
- CHIMNEYS: IF VERTICAL DROP INTO THE SEWER IS GREATER THAN 4 FEET, A CHIMNEY SHALL BE CONSTRUCTED FOR THE HOUSE CONNECTION.

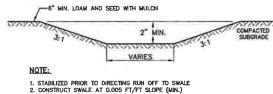

VEGETATED SWALE

NOT TO SCALE

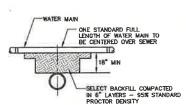

SEPARATION NOTES:

 WATER MAINS SHALL BE LAID AT LEAST 10 FEET HORIZONTALLY FROM ANY EXISTING OR PROPOSED SEWERS. THE DISTANCE SHALL BE MEASURED EDGE TO EDGE. WATER MAINS CROSSING SEWERS SHALL BE LAID TO PROVIDE A MINIMUM VERTICAL DISTANCE OF 18 INCHES BETWEEN PIPES. SEWER PIPE JOINTS SHALL BE LOCATED AT LEAST 6 PEET HORIZONTALLY FROM THE WATER MAIN

TYPICAL WATER / SEWER SEPARATION

NOT TO SCALE

1/		De	signed and Produc	ced in NH	
	Jones	&	Beach	Engineers,	Inc.

85 Portsmouth Ave. Civil Engineering Services PO Box 219

E-MAIL: JBE@JONESANDBEACH.COM

603-772-4746

Plan Name:	DETAIL SHEET
Project:	BAYBERRY COMMONS 19 OLD GONIC ROAD, ROCHESTER, NH
Owner of Record:	LEO P. LACOUTURE REV. TRUST & WILLIAM B. LACOUTURE 19 OLD GONIC RD., ROCHESTER, NH 03867 BK 4093 PG 148

DRAWING No D5 SHEET 48 OF 55 JBE PROJECT NO. 21090

BLASTING SPECIFICATIONS

- BEST MANAGEMENT PRACTICES FOR BLASTING, ALL ACTIVITIES RELATED TO BLASTING SHALL FOLLOW BEST MANAGEMEN PRACTICES (BMPS) TO PRACTICES FIRE BLASHING, ALL ACTIVITIES (BMPS) TO PRACTICES (BMPS) TO PRACTICES (BMPS) TO PREVENT CONTAINATION OF GROUNDWATER INCLUDING PREPARING, REVIEWING AND FOLLOWING AN APPROVED BLASTING PLAN; PROPER DRILLING, EXPLOSIVE HANDING AND LOADING PROCEDURES; OBSERVING THE ENTIRE BLASTING PROCEDURES; EVALUATING BLASTING PERFORMANCE; AND HANDLING AND STORAGE OF BLASTED ROCK.
- LOADING PRACTICES. THE FOLLOWING BLASTHOLE LOADING PRACTICES TO MINIMIZE ENVIRONMENTAL EFFECTS SHALL BE FOLLOWED:
 - SHALL BE FOLLOWED:


 (a) DRILLING LOGS SHALL BE MAINTAINED BY THE DRILLER AND COMMUNICATED DIRECTLY TO THE BLASTER. THE LOGS SHALL INDICATE DEPTHS AND LENGTHS OF VOIDS, CAVITIES, AND FAULT ZONES OR OTHER WEAK ZONES ENCOUNTERED AS WELL AS GROUNDWATER CONDITIONS.

 (b) EXPLOSIVE PRODUCTS SHALL BE MANAGED ON SITE SO THAT THEY ARE EITHER USED IN THE BOREHOLE, RETURNED TO THE DELIVERY VEHICLE, OR PLACED IN SECURE CONTAINERS FOR OFF. SITE DISPOSAL.
- O SPILLAGE AROUND THE BORBHOLE SHALL EITHER BE PLACED IN THE BORBHOLE OR CLEANED UP AND RETURNED TO AN APPROPRIATE VEHICLE FOR HANDUNG OR PLACEMENT IN SECURED CONTAINERS FOR OFF SITE DISPOSAL (1) LOADED EXPLOSIVES SHALL BE DETOMATED AS SOON AS POSSIBLE AND SHALL NOT BE LETT THE BLASTHOLES OVERNIGHT, UNLESS WEATHER OR OTHER SAFETY CONCERNS REASONABLY DISTATE THAT DETOMATION SHOULD BE
- (e) LOADING EQUIPMENT SHALL BE CLEANED IN AN AREA WHERE WASTEWATER CAN BE PROPERLY CONTAINED AND HANDLED IN A MANNER THAT PREVENTS RELEASE OF CONTAINNANTS TO THE ENVIRONMENT.

 (1) EXPLOSIVES SHALL BE LOADED TO MAINTAIN GOOD CONTINUITY IN THE COLUMN LOAD TO PROMOTE COMPLETE DETONATION. INDUSTRY ACCEPTED LOADING PRACTICES FOR PRIMING, STEMMING, DECKING AND COLUMN RISE NEED TO
- EXPLOSIVE SELECTION. THE FOLLOWING BMPS SHALL BE FOLLOWED TO REDUCE THE POTENTIAL FOR GROUNDWATER CONTAMINATION WHEN EXPLOSIVES ARE USED:
 - (a) EXPLOSIVE PRODUCTS SHALL BE SELECTED THAT ARE APPROPRIATE FOR SITE CONDITIONS AND SAFE BLAST EXECUTION.
- (b) EXPLOSIVE PRODUCTS SHALL BE SELECTED THAT HAVE THE APPROPRIATE WATER RESISTANCE FOR THE SITE CONDITIONS PRESENT TO MINIMIZE THE POTENTIAL FOR HAZARDOUS EFFECT OF THE PRODUCT UPON GROUNDWATER.
- PREVENTION OF MISTIRES. APPROPRIATE PRACTICES SHALL BE DEVELOPED AND IMPLEMENTED TO PREVEN MISTIRES.
- MUCK PILE MANAGEMENT, MUCK PILES (THE BLASTED PIECES OF ROCK) AND ROCK PILES SHALL BE MANAGED IN A MANNER TO REDUCE THE POTENTIAL FOR CONTAMINATION BY IMPLEMENTING THE FOLLOWING MEASURES:

REMOVE THE MUCK PILE FROM THE BLAST AREA AS SOON AS REASONABLY POSSIBLE.

- (b) MANAGE THE INTERACTION OF BLASTED ROCK PILES AND STORMWATER TO PREVENT CONTAMINATION OF WATER SUPPLY WELLS OR SURFACE WATER.
- SPILL PREVENTION MEASURES AND SPILL MITIGATION, SPILL PREVENTION AND SPILL MITIGATION MEASURES SHALL BE IMPLEMENTED TO PREVENT THE RELEASE OF FUEL AND OTHER RELATED SUBSTANCES TO THE ENVIRONMENT. THE MEASURES SHALL INCLUDE AT A MINIMUM:
- THE FUEL STORAGE REQUIREMENTS SHALL INCLUDE:
- 1. STORAGE OF REGULATED SUBSTANCES ON AN IMPERVIOUS SURFACE.
- 2. SECURE STORAGE AREAS AGAINST UNAUTHORIZED ENTRY.
- 3. LABEL REGULATED CONTAINERS CLEARLY AND VISIBLY.
- 4. INSPECT STORAGE AREAS WEEKLY.
- 5. COVER REGULATED CONTAINERS IN OUTSIDE STORAGE AREAS.
- 8. WHEREVER POSSIBLE, KEEP REGULATED CONTAINERS THAT ARE STORED OUTSIDE MORE THAN 50 FEET FROM SURFACE WATER AND STORM DRAINS, 75 FEET FROM PRIVATE WELLS, AND 400 FEET FROM PUBLIC WELLS.
- 7. SECONDARY CONTAINMENT IS REQUIRED FOR CONTAINERS CONTAINING REGULATED SUBSTANCES STORED OUTSIDE, EXCEPT FOR ON PREMISE USE HEATING FUEL TANKS, OR ABOVEGROUND OR UNDERGROUND STORAGE TANKS OTHERWISE REGULATED.
- b. THE FUEL HANDLING REQUIREMENTS SHALL INCLUDE:
- 1. EXCEPT WHEN IN USE, KEEP CONTAINERS CONTAINING REGULATED SUBSTANCES CLOSED AND SEALED.
- 2. PLACE DRIP PANS UNDER SPIGOTS, VALVES, AND PUMPS.
- 3. HAVE SPILL CONTROL AND CONTAINMENT EQUIPMENT READILY AVAILABLE IN ALL WORK AREAS. 4 LISE FLINNELS AND DRIP PANS WHEN TRANSFERRING REGULATED SUBSTANCES.
- 5 PERFORM TRANSFERS OF REGULATED SUBSTANCES OVER AN IMPERVIOUS SURFACE.
- c. THE TRAINING OF ON-SITE EMPLOYEES AND THE ON-SITE POSTING OF RELEASE RESPONSE INFORMATION DESCRIBING WHAT TO DO IN THE EVENT OF A SPILL OF REGULATED SUBSTANCES.
- d. Fueling and maintenance of excavation, earthwoying and other construction related ecoupment will comply with the regulations of inides (note these requirements are summarized in wo-dwg8-22-8: "Best management practices for fueling and maintenance of excavation and earthmoving equipment" or its

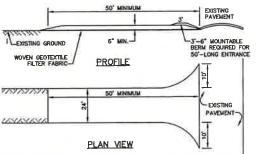

- NOTES:

 1. STONE FOR STABILIZED CONSTRUCTION ENTRANCE SHALL BE 3 INCH STONE, RECLAIMED STONE, OR RECVCLED CONCRETE EQUIVALENT.

 2. THE LENGTH OF THE STABILIZED ENTRANCE SHALL NOT BE LESS THAN 50 FEET, EXCEPT FOR A SINGLE RESIDENTIAL LOT WHERE A 30 FOOT MARMINIAL LENGTH WOULD APPLY A 12 FOOT MARMINIAL ENGINE WHERE A 12 FOOT MARMINIAL LENGTH WOULD APPLY A 12 FOOT MARMINIAL RESIDENTIAL LOT BE LESS THAN 6 INCRES.

 3. THE CHARLES OF THE DITTANCE SHALL NOT BE LESS THAN THE FALL WOTH OF THE ENTRANCE WHERE INGRESS OR ERGESS OCCURS, OR 10 FEET, WHICHEVER IS GREATER. OTH OF THE ENTRANCE WHERE INGRESS OR ERGESS OCCURS, OR 10 FEET, WHICHEVER IS GREATER. OTH OF THE ENTRANCE WHERE INGRESS OR ERGESS OCCURS, OR 10 FEET, WHICHEVER IS GREATER. OTH OF THE ENTRANCE HALL BE PLACED OVER THE ENTIRE AREA PRIOR TO PLACING THE STONE.

 5. GCOTEXTILE FILTER FABRIC SHALL BE PLACED OVER THE ENTIRE AREA PRIOR TO PLACING THE STONE.

 6. ALL SURFACE WATER THAT IS FLOWING TO OR DIVERTED TOWARD THE CONSTRUCTION DITTANCE SHALL BE PRED BENEATH THE ENTRANCE. SHALL BE REPORTED BENEATH THE STATE SHALL BE MADE CROSSED BY VEHICLES MAY BE SUBSTITUTED FOR THE PIPE.

 7. THE ENTRANCE SHALL BE MANIFAMED IN A CONDITION THAT WILL PREVENT TRACKING OR FLOWING OF SEDMENT ONTO THE PUBLIC RIGHT-OF-WAY. THIS MAY REQUIRE PERIODIC TOP DRESSING WITH ADDITIONAL STONE AS CONDITIONS DEBAND AND BERNAR MAD FOR CLAIM OUT OF ANY MEASURES USED TO TRAP
- STONE AS CONDITIONS DEMAND AND REPAIR AND/OR CLEAN OUT OF ANY MEASURES USED TO TRAP SEDIMENT. ALL SEDIMENT SPILLED, WASHED, OR TRACKED ONTO THE PUBLIC RIGHT—OF—WAY MUST BE REMOVED PROMPTLY.


STABILIZED CONSTRUCTION ENTRANCE

NOT TO SCALE

TEMPORARY EROSION CONTROL NOTES THE SMALLEST PRACTICAL AREA OF LAND SMALL BE EXPOSED AT ANY ONE TIME. AT NO TIME SHALL AN AREA IN EXCESS OF 5 ACRES BE EXPOSED AT ANY ONE TIME BEFORE DISTURBED AREAS ARE STABILIZED.

- 2. EROSION, SEDIMENT AND DETENTION MEASURES SHALL BE INSTALLED AS SHOWN ON THE PLANS AND AY LOCATIONS AS REQUIRED, DIRECTED BY THE ENGINEER.
- ALL DISTURBED AREAS (INCLIDING POND AREAS BELOW THE PROPOSED WATERLINE) SHALL BE RETURNED TO PROPOSED GRADES AND ELEVATIONS. DISTURBED AREAS SHALL BE LOAMED WITH A MINIMUM OF 6° OF SCREENED ORGANIC LOAM AND SEEDED WITH SEED MIXTURE 'C' AT A RATE NOT LESS THAN 1.10 POUNDS OF SEED PER 1,000 S.F. OF AREA (48 LBS. / AORE).
- SILT FENCES AND OTHER BARRIERS SHALL BE INSPECTED EVERY SEVEN CALENDAR DAYS AND WITHIN 24 HOURS OF A RAINFALL OF 0.5" OR GREATER. ALL DAMAGED AREAS SHALL BE REPAIRED, AND SEDIMENT DEPOSITS SHALL PERIODICALLY BE REDIVOY AND DISPOSED OF.
- AFTER ALL DISTURBED AREAS HAVE BEEN STABILIZED, THE TEMPORARY EROSION CONTROL MEASURES SHALL BE REMOVED AND THE AREA DISTURBED BY THE REMOVAL SMOOTHED AND RE-VEGETATED.
- AREAS MUST BE SEEDED AND MULCHED OR OTHERWISE PERMANENTLY STABILIZED WITHIN 3 DAYS OF FINAL GRADING, OR TEMPORARILY STABILIZED WITHIN 14 DAYS OF THE INITIAL DISTURBANCE OF SOIL, ALL AREAS SHALL BE STABILIZED WITHIN 45 DAYS OF INITIAL DISTURBANCE.
- IN AREAS WHERE FINAL GRADING HAS NOT OCCURRED, TEMPORARY STABILIZATION MEASURES SHOULD BE IN PLACE WITHIN 5 CALENDAR DAYS FOR EXPOSED SOIL AREAS THAT ARE WITHIN 100 FEET OF A SUFFACE WATERBOOY OR A WETLAND AND NO MORE THAN 14 CALENDAR DAYS FOR ALL OTHER AREAS. PERMANENT STABILIZATION SHOULD BE IN PLACE WITHIN 3 CALENDAR DAYS FOLLOWING COMPLETION OF FINAL GRADING OF EXPOSED SOIL AREAS.
- ALL PROPOSED VEGETATED AREAS THAT DO NOT EXHIBIT A MINIMUM OF 85 PERCENT VEGETATIVE GROWTH 8Y OCTOBER 15, OR WHICH ARE DISTURBED AFTER OCTOBER 15, SHALL BE STABILIZED BY SEEDING AND INSTALLING NORTH AMERICAN GREEN 575 EROSION CONTROL BLANKETS (OR AN EQUIVALENT APPROVED IN WHITHIN 68 THE NORMER) ON SLOPES GREATER THAN 3:1, AND SEEDING AND PLACING 3 TO 4 TONS OF MULCH PER ACRE, SECURED WITH AMCHORE NETTING, ELSEMBERE. THE MISTALLATION OF EROSION CONTROL BLANKETS OR MULCH AND NETTING SHALL HOT CORR OVER ACCUMULATED SHOW ON ON PROZEM GROUND AND SHALL BE COMPLETED IN ADVANCE OF THAM OR SPRING MELT.
- ALL DITCHES OR SWALES WHICH DO NOT EXHIBIT A MINIMUM OF 85 PERCENT VEGETATIVE GROWTH BY DCTOBER 15, OR WHICH ARE DISTURBED AFTER OCTOBER 15, SHALL BE STABILIZED TEMPORARILY WITH STONE OR EROSION CONTROL ELANKETS APPROPRIATE FOR THE DESIGN FLOW CONDITIONS.
- AFTER OCTOBER 15th, INCOMPLETE ROAD OR PARKING SURFACES, WHERE WORK HAS STOPPED FOR THE WINTER SEASON, SHALL BE PROTECTED WITH A MINIMUM OF 3" OF CRUSHED GRAVEL PER NHDOT ITEM 304.3.
- 11. AN AREA SHALL BE CONSIDERED STABLE IF ONE OF THE FOLLOWING HAS OCCURRED:
- a. BASE COURSE GRAVELS HAVE BEEN INSTALLED IN AREAS TO BE PAVED;
- b. A MINIMUM OF 85% VEGETATED GROWTH HAS BEEN ESTABLISHED
- C. A MINIMUM OF 3" OF NON-EROSIVE MATERIAL SUCH STONE OR RIPRAP HAS BEEN INSTALLED; OR
- FUGITIVE DUST CONTROL IS REQUIRED TO BE CONTROLLED IN ACCORDANCE WITH ENV-A 1000, AND THE PROJECT IS TO MEET. THE REQUIREMENTS AND INTENT OF RSA 430:53 AND AGR 3800 RELATIVE TO INVASIVE SPECIES.
- 12. PRIOR TO BEGINNING CONSTRUCTION, THE CONTRACTOR'S NAME, ADDRESS, AND PHONE NUMBER SHALL BE SUBMITTED TO
- IN ORDER TO ENSURE THE STABILITY OF THE SITE AND EFFECTIVE IMPLEMENTATION OF THE SEDIMENT AND EROSION CONTROL MEASURES SPECIFIED IN THE PLANS FOR THE DURATION OF CONSTRUCTION, THE CONTRACTOR SHALL BE IN STRUCT COMPLIANCE WITH THE FOLLOWING INSPECTION AND MAINTENANCE REQUIREMENTS IN ADDITION TO THOSE CALLED FOR IN THE SWPPP:
 - G. A CERTIFIED PROFESSIONAL IN EROSION AND SEDIMENT CONTROL OR A PROFESSIONAL ENGINEER LICENSED IN THE STATE OF NEW HAMPSHIRE ("LONTIDE") SHALL BE EMPLOYED TO INSPECT THE SITE FROM THE START OF ALTERATION OF TERRAIN ACTIVITIES UNTIL THE SITE IS IN PULL COMPLIANCE WITH THE SITE SECOND PERMIT
 - b. DURING THIS PERIOD, THE MONITOR SHALL INSPECT THE SUBJECT SITE AT LEAST ONCE A WEEX, AND IF POSSIBLE, DURING ANY ¼ NICH OR GREATER RAIN EVENT (I.E. ½ INCH OF PREOPITATION OR MORE WITHIN A 24 HOUR PERIOD). IF UNABLE TO BE PRESENT DURING SUCH A STORM, THE MONITOR SHALL INSPECT THE SITE WITHIN 24 HOURS OF THIS EVENT.
 - .. THE MONITOR SHALL PROVIDE TECHNICAL ASSISTANCE AND RECOMMENDATIONS TO THE CONTRACTOR ON THE APPROPRIATE SETS MANAGEMENT PRACTICES FOR EROSION AND SEDIMENT CONTROLS REQUIRED TO MEET THE REQUIREMENTS SETS MANAGEMENT PRACTICES FOR EROSION DESPERSIFIED OF PRIMIT CONDITIONS.
 - WITHIN 24 HOURS OF EACH INSPECTION, THE MONITOR SHALL SUBMIT A REPORT TO DES VIA EMAIL (RIDGELY MAUCK AT: RIDGELY.MAUCK@DES.NH.GOV).
 - THE MONITOR SHALL MEET WITH DES TO DECIDE UPON A REPORT FORMAT. THE REPORT FORMAT SHALL BE REVIEWED AND APPROVED BY DES PRIOR TO THE START OF CONSTRUCTION. f. THE MONITOR SHALL INCLUDE PHOTOGRAPHS OF THE SITE THAT ARE REPRESENTATIVE OF THE PROJECT.

Eorth Berm PLAN VIEW

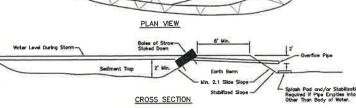

TEMPORARY SEDIMENT BASIN

NOT TO SCALE

SEEDING SPECIFICATIONS

- GRADING AND SHAPING

 A. SLOPES SHALL NOT BE STEEPER THAN 2:1 WITHOUT APPROPRIATE EROSION CONTROL MEASURES AS
 - SPECIFIED ON THE PLANS (3:1 SLOPES OR FLATTER ARE PREFERRED).
 WHERE MOWING WILL BE DONE, 3:1 SLOPES OR FLATTER ARE RECOMMENDED.

- 2. SECRETO PREPARATION

 A. SURFACE AND SEEPAGE WATER SHOULD BE DRAINED OR DIVERTED FROM THE SITE TO PREVENT DROWNING
- A SURFACE AND SEEPAGE WATER SHOULD BE DRAINED OR DIVERTED FROM THE STE TO PREVENT DROWNING ON WINTER KILLING OF THE PLANTS.

 B. STONES LARGER THAN 4 INCHES AND TRASH SHOULD BE REMOVED BECAUSE THEY INTERFERE WITH SEEDING AND PUTURE MAINTENANCE OF THE AREA, WHERE FEASIBLE, THE SOIL SHOULD BE TILLED TO A DEPTH OF ABOUT 4 INCHES TO PREPARE A SEEDBED AND FERTILIZER AND LIME MIXED INTO THE SOIL THE SEEDBED SHOULD BE LETT IN A REASONABLY FIRM AND SMOOTH CONDITION. THE LAST TILLAGE OPERATION SHOULD BE PERFORMED ACROSS THE SLOPE WHEREVER PRACTICAL.

- 3. <u>ESTABLISHING A STAND</u>

 A. LIME AND FERTILIZER SHOULD BE APPLIED PRIOR TO OR AT THE TIME OF SEEDING AND INCORPORATED INTO THE SOIL TYPES AND AMOUNTS OF LIME AND FERTILIZER SHOULD BE BASED ON AN EVALUATION OF SOIL TESTS. WHEN A SOIL TEST IS NOT AVAILABLE, THE FOLLOWING MINIMUM AMOUNTS SHOULD BE APPLIED.
 - APPLED:
 AGRICULTURAL LIMESTONE, 2 TONS PER ACRE OR 100 LBS. PER 1,000 SQ.FT.
 NITROGEN(N), 50 LBS. PER ACRE OR 1.1 LBS, PER 1,000 SQ.FT.
 PHOSPHATE(P205), 100 LBS. PER ACRE OR 2.2 LBS. PER 1,000 SQ.FT.

 - POTASH(K20), 100 LBS, PER ACRE OR 2.2 LBS, PER 1,000 SQ.FT.
- (NOTE: THIS IS THE EQUIVALENT OF 500 LBS. PER ACRE OF 10-20-20 FERTILIZER OR 1,000 LBS. PER
- REFER TO THE 'SEEDING GUIDE' AND 'SEEDING RATES' TABLES ON THIS SHEET FOR APPROPRIATE SEED MIXTURES AND RATES OF SEEDING. ALL LEGUMES (CROWNVETCH, BIRDSFOOT, TREFOIL AND FLATPEA)
 MUST BE INOCULATED WITH THEIR SPECIFIC INOCULANT PRIOR TO THEIR INTRODUCTION TO THE SITE.
- WHEN SEEDED AREAS ARE MULCHED, PLANTINGS MAY BE MADE FROM EARLY SPRING TO EARLY OCTOBER.
 WHEN SEEDED AREAS ARE NOT MULCHED, PLANTINGS SHOULD BE MADE FROM EARLY SPRING TO MAY 20th OR FROM AUGUST 10th TO SEPTEMBER 1st.

4. MULCH
A. HAY, STRAW, OR OTHER MULCH, WHEN NEEDED, SHOULD BE APPLIED IMMEDIATELY AFTER SEEDING.
B. MULCH WILL BE HELD IN PLACE USING APPROPRIATE TECHNIQUES FROM THE BEST MANAGEMENT PRACTICE
FOR MULCHING. HAY OR STRAW MULCH SHALL BE PLACED AT A RATE OF 90 LBS PER 1000 S.F.

5. MAINTENANCE TO ESTABLISH A STAND. A. PLANTED AREAS SHOULD BE PROTECTED FROM DAMAGE BY FIRE, GRAZING, TRAFFIC, AND DENSE WEED

- B. FERTILIZATION NEEDS SHOULD BE DETERMINED BY ONSITE INSPECTIONS; SUPPLEMENTAL FERTILIZER IS
- USUALLY THE KEY TO FULLY COMPLETE THE ESTABLISHMENT OF THE STAND BECAUSE MOST PERENNIALS TAKE 2 TO 3 YEARS TO BECOME FULLY ESTABLISHED.

 IN WATERWAYS, CHANNELS, OR SWALES WHERE UNIFORM FLOW CONDITIONS ARE ANTICIPATED, ANNUAL
- MOWING MAY BE NECESSARY TO CONTROL GROWTH OF WOODY VEGETATION.

USE	SEEDING MIXTURE 1/	DROUGHTY	WELL, DRAINED	MODERATELY WELL DRAINED	POORLY DRAINED
STEEP CUTS AND	A	FAIR	GOOD	G000	FAIR
FILLS, BORROW AND DISPOSAL	B C	POOR POOR	G000 G000	FAIR EXCELLENT	FAIR GOOD
AREAS	D	FAIR	EXCELLENT	EXCELLENT	POOR
WATERWAYS, EMERGENC' SPILLWAYS, AND OTHER CHANNELS WITH FLOWING WATER.	r Ĉ	GOOD GOOD	GOOD EXCELLENT	GOOD EXCELLENT	FAIR FAIR
LIGHTLY USED PARKING LOTS, ODD AREAS, UNUSED LANDS, AND LOW INTENSITY USE RECREATION SITES.	A B C	G000 G000 G000	GOOD GOOD EXCELLENT	GOOD FAIR EXCELLENT	FAIR POOR FAIR
PLAY AREAS AND ATHLETIC FIELDS. (TOPSOIL IS ESSENTIAL FOR GOOD TURF.)	E F	FAIR FAIR	EXCELLENT	EXCELLENT EXCELLENT	2/ 2/

GRAVEL PIT, SEE NH-PM-24 IN APPENDIX FOR RECOMMENDATION REGARDING RECLAMATION OF SAND AND GRAVEL PITS.

1/ REFER TO SEEDING MIXTURES AND RATES IN TABLE BELOW.
2/ POORLY DRAINED SOILS ARE NOT DESIRABLE FOR USE AS PLAYING AREA AND ATHLETIC FIELDS.

NOTE: TEMPORARY SEED MIX FOR STABILIZATION OF TURF SHALL BE WINTER RYE OR OATS AT A RATE OF 2.5 USS. PER 1000 S.F. AND SHALL BE PLACED PRIOR TO OCTOBER 15th, IF PERMANENT SEEDING NOT YET COMPLETE.

SEEDING GUIDE

PER ACRE	POUNDS PER 1.000 Sq. Ft.
20	0.45
20	0.45
2	0.05
42	0.95
15	0.35
10	0.25
15	0.35
30	0.75
40 OR 55	0.95 OR 1.35
20	0.45
20	0.45
<u>5</u>	0.20
48	1.10
20	0.45
30	0.75
50	1.20
50	1.15
50	1.15
100	2.30
150	3.60
	20 2 42 15 10 15 30 40 OR 55 20 20 48 20 30 50 50

SEEDING RATES

- PRIOR TO THE START OF ANY ACTIVITY, IT IS THE RESPONSIBILITY OF THE SITE'S SITE DEVELOPER (OR OWNER) TO FILE A NOTICE OF INTENT (NO.) FORM WITH THE ENVIRONMENTAL PROTECTION ACENCY (EPA) IN ORDER TO GAIN COVERAGE UMDER THE NEW PDES GOMERAL PERMIT FOR STORM WATER DISCHARGES FROM CONSTRUCTION ACTIVITIES, A PRE CONSTRUCTION MEETING IS TO BE HELD WITH ALL DEPARTMENT HEADS PRIOR TO THE START OF CONSTRUCTION.
- 2. THIS PROJECT SHALL BE CONSTRUCTED ACCORDING TO THE PHASING PLAN INCLUDED WITHIN THE PLAN SET
- 3. WETLAND BOUNDARIES ARE TO BE CLEARLY MARKED PRIOR TO THE START OF CONSTRUCTION
- 4. CUT AND REMOVE TREES IN CONSTRUCTION AREA AS REQUIRED OR DIRECTED,
- INSTALL SILT FENCING, HAY BALES AND CONSTRUCTION ENTRANCES PRIOR TO THE START OF CONSTRUCTION. THESE ARE TO BE MAINTAINED UNTIL THE FINAL PAVEMENT SURFACING AND LANDSCAPING AREAS ARE ESTABLISHED.
- CLEAR, CUT, GRUB AND DISPOSE OF DEBRIS IN APPROVED FACILITIES. THIS INCLUDES ANY REQUIRED DEMOLITION OF EXISTING STRUCTURES, UTILITIES, ETC.
- CONSTRUCT AND/OR INSTALL TEMPORARY OR PERMANENT SEDIMENT AND/OR DETENTION BASIN(S) AS REQUIRED PRIOR TO ROUGH GRADING. THESE FAGILITIES SHALL BE INSTALLED AND STABILIZED PRIOR TO DIRECTING ROUM-OFF TO THEM.
- 8. STRIP LOAM AND PAYEMENT, OR RECLAIM EXISTING PAYEMENT WITHIN LIMITS OF WORK PER THE RECOMMENDATIONS OF THE PROJECT ENGINEER AND STOCKPILE EXCESS MATERIAL STABILIZE STOCKPILE AS
- 9. PERFORM PRELIMINARY SITE GRADING IN ACCORDANCE WITH THE PLANS, INCLUDING THE CONSTRUCTION OF ANY RETAINING WALLS.
- 10. PREPARE BUILDING PAD(S) TO ENABLE BUILDING CONSTRUCTION TO BEGIN
- 11. INSTALL THE SEWER AND DRAINAGE SYSTEMS FIRST, THEN ANY OTHER UTILITIES IN ACCORDANCE WITH THE PLAN AND DETAILS. ANY CONFLICTS BETWEEN UTILITIES ARE TO BE RESOLVED WITH THE INVOLVEMENT AND APPROVAL OF THE PICKINFER.
- 12. INSTALL INLET PROTECTION AT ALL CATCH BASINS AS THEY ARE CONSTRUCTED IN ACCORDANCE WITH DETAILS.
- 13. ALL SWALES AND DRAINAGE STRUCTURES ARE TO BE CONSTRUCTED AND STABILIZED PRIOR TO HAVING RUN-OFF DIRECTED TO THEM.
- 14. DAILY, OR AS REQUIRED, CONSTRUCT TEMPORARY BERMS, DRAINAGE DITCHES, CHECK DAMS, SEDIMENT TRAPS, ETC., TO PREVENT EROSION ON THE SITE AND PREVENT ANY SILITATION OF ABUTTING WATERS
- 15. PERFORM FINAL FINE GRADING, INCLUDING PLACEMENT OF 'SELECT' SUBGRADE MATERIALS.
- 17. PERFORM ALL REMAINING SITE CONSTRUCTION (I.e. BUILDING, CURBING, UTILITY CONNECTIONS, ETC.).
- LOAM AND SEED ALL DISTURBED AREAS AND INSTALL ANY REQUIRED SEDIMENT AND EROSION CONTROL FACILITIES (i.e. RIP RAP, EROSION CONTROL BLANKETS, ETC.).
- 19. FINISH PAYING ALL ROADWAYS AND PARKING AREAS WITH 'FINISH' COURSE
- 20. ALL ROADWAYS AND PARKING LOTS SHALL BE STABILIZED WITHIN 72 HOURS OF ACHIEVING FINISHED GRADE.
- 21. ALL CUT AND FILL SLOPES SHALL BE SEEDED/LOAMED WITHIN 72 HOURS OF ACHIEVING FINISHED GRADE.
- 22. COMPLETE PERMANENT SEEDING AND LANDSCAPING.
- REMOVE TEMPORARY EROSION CONTROL MEASURES AFTER SEEDING AREAS HAVE BEEN 75%-85%
 ESTABLISHED AND SITE IMPROVEMENTS ARE COMPLETE. SMOOTH AND RE-VEGETATE ALL DISTURBED AREAS.
- 24. CLEAN SITE AND ALL DRAINAGE STRUCTURES, PIPES AND SUMPS OF ALL SILT AND DEBRIS
- 25. INSTALL ALL PAINTED PAVEMENT MARKINGS AND SIGNAGE PER THE PLANS AND DETAILS. 26. ALL EROSION CONTROLS SHALL BE INSPECTED WEEKLY AND AFTER EVERY HALF-INCH OF RAINFALL
- UPON COMPLETION OF CONSTRUCTION, IT IS THE RESPONSIBILITY OF THE CONTRACTOR TO NOTIFY ANY
 RELEVANT PERMITTING AGENCIES THAT THE CONSTRUCTION HAS BEEN FINISHED IN A SATISFACTORY MANNER.
 - 2.5' (MIN)

- 1. EROSION CONTROL MIX BERMS SHALL BE
- O USED ONLY IN AREAS WHERE EROSION WILL OCCUR IN THE FORM OF SHEET EROSION ONLY AND THERE IS NO CONCENTRATION OF WATER IN A CHANNEL OR OTHER DRAINAGE WAY ABOVE THE BERM;

 NISTALLED FOLLOWING THE CONTOUR OF THE LIAND AS CLOSELY AS POSSIBLE;


 USED ONLY IF THE AREA UPSLOPE OF THE BERM HAS A SLOPE OF LESS THAN 5%; AND
- d. AT LEAST 12 INCHES HIGH AND AT LEAST 2 FEET WIDE
- THE EROSION CONTROL MIX USED IN THE FILTER BERMS SHALL BE A WELL—GRADED MIXTURE OF PARTICLE SIZES, AND SHALL MEET THE FOLLOWING STANDARDS:
- a) THE ORGANIC CONTENT SHALL BE 25-65% OF DRY WEIGHT THAT IS 1) FIBROUS AND ELONGATED SUCH AS FROM SHREDDED BARK, STUMP GRINDINGS, COMPOSTED BARK OR EQUIVALENT MANUFACTURED PRODUCTS; AND
- 2) NOT COMPRISED OF WOOD CHIPS, BARK CHIPS, GROUND CONSTRUCTUION DEBRIS OR REPROCESSED WOOD PRODUCTS
- b) PARTICLE SIZE BY WEIGHT SHALL BE 100% PASSING A 3" SCREEN, 90% TO 100% PASSING A 1" SCREEN, 70% TO 100% PASSING A 0.75" SCREEN, AND 30%-75% PASSING A 0.25" SCREEN
- c) DOES NOT CONTAIN SILTS, CLAYS OR FIND SANDS
- 3. ORGANIC FILTER BERMS SHALL BE INSTALLED ALONG A RELATIVELY LEVEL CONTOUR, FOLOWING THE CONTOUR OF THE LAND AS CLOSLELY AS POSSBEE. IT MAY BE NECESSARY TO CUT TALL GRASSES OR WOODLY VECETATION TO AVIDO CREATING WOODS AND BRIDGES THAT WOULD ENABLE FINES TO WASH UNDER THE BERM.
- 5. FROZEN GROUND, OUTCROPS OF BEDROCK, AND VERY ROOTED FORESTED AREAS PRESENT THE MOST PRACTICAL AND EFFECTIVE LOCATIONS FOR ORGANIC FILTER BERMS. OTHER BMP'S SHOULD BE USED AT LOW POINTS OF CONCENTRATED RUNOFF, BELOW CULVERT OUTLET APPROVING. AROUND CATCH BASINS, AND AT THE BOTTOM OF STEEP PERIMETER SLOPES THAT HAVE A LARGE CONTRIBUTING AREA.
- SEDIMENT SHALL BE REMOVED FROM BEHIND THE STRUCTURES WHEN IT HAS ACCUMULATED TO ONE HALF THE ORIGINAL HEIGHT OF THE STRUCTURE.
- 7. STRUCTURES MAY BE LEFT IN PLACE ONCE THE SITE IS STABILIZED.

ORGANIC FILTER BERM

NOT TO SCALE

Owner of Record:

Design: JAC	Draft: LAZ	Date: 04/29/21
Checked: JAC	Scale: AS NOTED	Project No.: 21090
Drawing Name:	21090-PLAN,dwg	

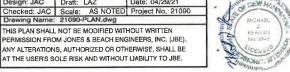

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17	8/24/23	REVISED PER TOWN COMMENTS	LAZ
16	6/14/23	REVISED OFFSITE PLANS	LAZ
15	5/23/23	REVISED PER CONDITIONS OF APPROVAL	LAZ
REV	DATE	REVISION	BY



	Plan Name:	EROSION AND SEDIMENT CONTROL DETAILS
Ī	Project:	BAYBERRY COMMONS 19 OLD GONIC ROAD, ROCHESTER, NH

LEO P, LACOUTURE REV. TRUST & WILLIAM B. LACOUTURE 19 OLD GONIC RD., ROCHESTER, NH 03867 BK 4093 PG 148

DRAWING No

WINTER CONSTRUCTION NOTES

IF THIS CONSTRUCTION SITE IS NOT STABILIZED WITH PAVEMENT, A ROAD GRAVEL BASE, 85 % MATURE VEGETATION COVER, OR RIPRAP BY OCTOBER 15, THEN THE SITE MUST BE PROTECTED WITH OVER-WINTER STABILIZATION. THE WINTER CONSTRUCTION PERIOD IS FROM OCTOBER 15 THROUGH MAY 15.

ACIONER 13 INRUUGH MAT 13. MINTER FXCAVATION AND FARTHWORK ACTIVITIES SHALL BE LIMITED IN EXTENT AND DURATION, TO MINIMIZE POTENTIAL EROSION AND

GENERALLY, THE EXPOSED AREA SHOULD BE LIMITED TO ONLY THOSE AREAS IN WHICH WORK WILL OCCUR DURING THE FOLLOWING 15 DAYS AND THAT CAN BE MULCHED IN ONE DAY PRIOR TO ANY SNOW OR RAINFALL EVENT.

SUBSEQUENT WORK AREAS SHOULD NOT BE EXPOSED UNTIL THE PREVIOUSLY EXPOSED WORK AREA HAS BEEN FULLY STABILIZED. AN AREA IS CONSIDERED "EXPOSED" UNTIL STABILIZED WITH GRAVEL BASE ON A ROAD OR PARKING AREA, PAVEMENT, VEGETATION, MULCHING, EROSION CONTROL MIX, EROSION CONTROL MATS, OR RIPRAP.

ALL EROSION AND SEDIMENT CONTROL MEASURES INSTALLED FOR THE PROJECT SHOULD HAVE ROUTINE MAINTENANCE AND CLEANING COMPLETED, AND SHOULD BE INSPECTED AND REPAIRED AS NEEDED IN PREPARATION FOR THE CONSTRUCTION SEASON, TEMPORARY EMBANKMENTS SHOULD BE FULLY VEGETATED OR OTHERWISE STABILIZED BY ACCEPTED METHODS.

MAINTENANCE REQUIREMENTS

MAINTIANACE REQUIREMENTS

MAINTIANACE REQUIREMENTS

MAINTIANACE MEASURES SHOULD CONTINUE AS NEEDED THROUGHOUT CONSTRUCTION, INCLIDING THE OVER-WINTER PERIOD, AFTER EACH RAINFALL, SHOWSTORM, OR PERIOD OF THAWNG AND RUNOFF, THE SITE CONTRACTOR SHOULD CONDUCT AN INSPECTION OF ALL INSTALLED BY REGISION CONTINUING FUNDER, OF ANY AREA STABILIZED BY TEMPORARY OR PERMANENT SEEDING PRIOR TO THE ONSET OF THE WINTER SEASON, THE CONTRACTOR SHOULD CONDUCT AN INSPECTION IN THE SPRING TO ASCENIAN THE CONDITION OF VEGETATION COVER, AND REPAIR ANY DAMAGE AREA OR BARE SPOTS AND RESEED AS RECUIRED TO ACHIEVE AN ESTABLISHED VEGETATIVE COVER (AT LEAST 85% OF AREA VEGETATED WITH HEALTHY, WOOROUS GROWTH), SPECIFICATIONS TO ADEQUATELY PROTECT WATER QUALITY DURING COLD WEATHER AND DURING SPRING INDIFF, THE FOLLOWING STABILIZATION TECHNIQUES SHOULD BE EMPLOYED DURING THE PERIOD FROM OCTOBER 15TH THROUGH MAY 15TH.

THE AREA OF EXPOSED, UNSTABILIZED SOIL SHOULD BE PROTECTED AGAINST EROSION BY THE METHODS DESCRIBED IN THIS SECTION PRIOR TO ANY THAW OR SPRING MELT EVENT.

STABILIZATION AS FOLLOWS SHOULD BE COMPLETED WITHIN A DAY OF ESTABLISHING THE GRADE THAT IS FINAL OR THAT OTHERWISE WILL EXIST FOR MORE THAN 5 DAYS:

- SEFOR MORE, HAN 3 DATS:

 O ALL PROPOSED YECETATED AREAS HAVING A SLOPE OF LESS THAN 15% WHICH DO NOT EXHIBIT A MINIMUM OF 85% VEGETATIVE
 GROWTH BY OCTOBER 15TH, OR WHICH ARE DISTURBED AFTER OCTOBER 15TH, SHOULD BE SEEDED AND COVERED WITH 3 TO 4 TONS
 OF HAY OR STRAW MULCH PER ACRE SECURED WITH ANCHORED NETTING, OR 2 INCHES OF EROSION CONTROL MIX (SEE DESCRIPTION
 OF EROSION CONTROL MIX BERMS FOR MATERIAL SPECIFICATION),
- O ALL PROPOSED VEGETATED AREAS HAVING A SLOPE OF GREATER THAN 15% WHICH DO NOT EXHIBIT A MINIMUM OF 85% VEGETATIVE GROWTH BY OCTOBER 15TH, OR WHICH ARE DISTURBED AFTER OCTOBER 15TH, SHOULD BE SEEDED AND COVERED WITH A PROPERLY INSTALLED AND ANCHORDE PROSON CONTROL BLANKET OR WITH A MINIMUM 4 NICH THICKNESS OF REOSION CONTROL MIX, UNILESS OTHERWISE SPECIFIED BY THE MANUFACTURER. NOTE THAT COMPOST BLANKETS SHOULD NOT EXCEED 2 INCHES IN THICKNESS OR THEY MAY OVERTICE.

INSTALLATION OF ANCHORED HAY MULCH OR EROSION CONTROL MIX SHOULD NOT OCCUR OVER SNOW OF GREATER THAN ONE INCH IN

ALL MULCH APPLIED DURING WINTER SHOULD BE ANCHORED (E.G., BY NETTING, TRACKING, WOOD CELLULOSE FIBER).

STOCKPILES OF SOIL MATERIALS SHOULD BE MULCHED FOR OVER WINTER PROTECTION WITH HAY OR STRAW AT TWICE THE NORMAL RATE OR WITH A FOUR-INCH LAYER OF EROSSON CONTROL MIX. MULCHING SHOULD BE DONE WITHIN 24 HOURS OF STOCKING, AND RE-ESTABLISHED PRIOR TO ANY RAINFALL OR SNOWFALL NO SOIL STOCKPILE SHOULD BE PLACED (EVEN COVERED WITH MULCH) WITHIN 100 FEFT FROM ANY WETLAND OR OTHER WATER RESOURCE AREA.

FROZEN MATERIALS, (E.G., FROST LAYER THAT IS REMOVED DURING WINTER CONSTRUCTION), SHOULD BE STOCKPILED SEPARATELY AND IN A LOCATION THAT IS AWAY FROM ANY AREA NEEDING TO BE PROTECTED. STOCKPILES OF FROZEN MATERIAL CAN MELT IN THE SPRING AND BECOME UNKNOKKABLE AND DEFICULT TO THANSPORT DUE TO THE HIGH MOISTURE CONTENT IN THE SOUR

INSTALLATION OF EROSION CONTROL BLANKETS SHOULD NOT OCCUR OVER SNOW OF GREATER THAN ONE INCH IN DEPTH OR ON FROZEN

ALL GRASS—LINED DITCHES AND CHANNELS WHICH ARE DISTURBED AFTER OCTOBER 15TH, SHOULD BE STABILIZED TEMPORARILY WITH STONE OR EROSION CONTROL BLANKETS APPROPRIATE FOR THE DESIGN FLOW CONDITIONS, AS DETERMINED BY A DUALIFIED PROFESSIONAL DISGINEER OR A CERTIFIED PROFESSIONAL IN EROSION AND SEDIMENT CONTROL AS CERTIFIED BY THE CSPESC COUNCIL OF ENVIROCERT INTERNATIONAL, INC. IF A STONE LINING IS NECESSARY, THE CONTRACTOR MAY NEED TO RE-GRADE THE DITCH AS REQUIRED TO PROVIDE ADEQUATE CROSS-SECTION AFTER ALLOWING FOR PLACEMENT OF THE STONE.

AFTER NOVEMBER 15TH, INCOMPLETE ROAD OR PARKING AREAS WHERE ACTIVE CONSTRUCTION OF THE ROAD OR PARKING AREA HAS STOPPED FOR THE WHITER SEASON SHOULD BE PROTECTED WITH A MINIAMM 3 INCH LAYER OF SAND AND GRAVEL WITH A GRADATION SUICH THAT LESS THAN 12% OF THE SAND PORTION, OR MATERIAL PASSING THE NUMBER 4 SIEVE, BY WEIGHT, PASSES THE NUMBER 200 SEVE.

SEDIMENT BARRIERS THAT ARE INSTALLED DURING FROZEN CONDITIONS SHOULD CONSIST OF EROSION CONTROL MIX BERMS, OR CONTINUOUS CONTAINED BERMS. SILT FENCES AND HAY BALES SHOULD NOT BE INSTALLED WHEN FROZEN CONDITIONS PREVENT PROPER EMBEDMENT OF THESE BARRIERS.

ADDITIONAL WINTER MITIGATION MEASURES

- THE TRANSITIONAL PERIODS BETWEEN FALL AND WINTER, AND WINTER AND SPRING MAY REQUIRE A WET WEATHER SHUTDOWN PERIOD.
 WEATHER CONSTRONS THAT FLUCTUATE BETWEEN ABOVE FREEZING TEMPERATURES DURING THE DAY AND BELOW FREEZING
 TEMPERATURES AT NIGHT OFTEN RESULT IN SOILS THAT ARE WET AND "GREASY," WHICH ARE SUSCEPTIBLE TO RUTTING AND SOIL WINING.
 THE ENVIRONMENTAL MONITOR WILL DETERMINE THE NEED FOR AND DURATION OF A WET WEATHER SHUTDOWN OR OTHER MITIGATIVE ACTIONS IN THESE SITUATIONS.
- NO DEICHIG PRODUCTS WILL BE USED ON THE PROJECT; HOWEVER, SNOW REMOVAL MAY BE REQUIRED TO ALLOW SAFE ACCESS TO THE SITE. SNOW IS TYPICALLY PUSHED OFF OF AN ACCESS ROAD WITH EQUIPMENT SUCH AS A GRADER, SNOWFLOW, OR BULLDOZER AND THEN STOCKPILED ALLOW THE EDGE OF THE ACCESS ROAD, TO MINIMIZE SCRAPING OFF UNDERLYING SOIL OR GRAVEL DURING SNOW REMOVAL, SNOWBLOWER ATTACHMENTS WILL BE INSTALLED ON COMPATIBLE EQUIPMENT.
- WHEN SNOW IS STORED ON THE SITE, A PHYSICAL BARRIER SUCH AS MULCH OR SEPARATION OF SNOW PILES FROM SPOIL PILES WILL BE CONDUCTED TO AVOID MIXING.
- CONDUCTED TO AVOID MIXING.

 DUE TO FROZEN CONDITIONS, INSTALLATION OF CERTAIN TEMPORARY BMPS TO MINIMIZE EROSION AND CONTROL SEDIMENT (E.G., SILT FENCE AND STAKED STRAW BALES) MAY NOT BE PRACTICABLE. IN THIS CASE, ALTERNATIVE BMPS (SUCH AS COMPOST FILTER SOCKS, EROSION CONTROL BLANKETS, OR STRAW WATTLES) WILL BE INSTALLED ON BAME FROZEN GROUND OR SNOW (LESS THAN 2 MICHIES DEEP) TO MITIGATE EROSION AND SEDIMENT MIGRATION. WEED-FREE STRAW OR HAY MILLOT MILL BE APPLIED AND ANCHORED (IF POSSIBLE) TO EXPOSED SOILS AT ALL UPLAND LOCATIONS WITH A 5 PERCENT OR GREATER SLOPE, MILLOT MAY BE APPLIED REGARDLESS OF SHOW COVER TO COVER AT LEAST 80 PERCENT OF THE GROUND SURFACE; SURJIGHT WILL THE STRAW INTO THE SNOW TO MELT ONTO BAKE SOIL. IN THE SPRRING, MULCH WILL NOT BE APPLIED IN WETLANDS OR CONVEYANCE SYSTEMS. INSTALLED SLOPE BREAKERS AND EROSION AND SEDIMENT CONTROL BMPS WILL BE SUBJECT TO INSPECTION AND REPAIR REQUIREMENTS AS OUTLINED IN SECTION 4.15 OF THE SWPPP AND/OR APPLICABLE PERMITS, WHEN THE MANNEY CONDITIONS BEGIN, BMPS WILL BE MONITORED AND UPGRADED AS NEEDED TO PREVENT SEDIMENT DEPOSITION INTO RESOURCES OR OFF SITE. SHOULD FINAL GRADING AND CLEANUP BE COMPLETED THE FOLLOWING SPRING THE THE PROPORTION OF SITEMS INTO THE SOURCES OR OFF SITE SHOULD FINAL GRADING AND CLEANUP BE COMPLETED THE FOLLOWING SPRING THE THE PROPORTION AND DEPARLED IN DISCROSORY SITEMS. INTO THE SOURCES OR OFF SITE SHOULD FINAL GRADING AND CLEANUP BE COMPLETED THE FOLLOWING SPRING, THEN TEMPORARY SLOPE BREAKERS AND SEDIMENT BARRIERS WILL BE INSTALLED DURING BACKFILL AND/OR ROUGH GRADE ACTIVITIES. BMPS WILL BE INSTALLED AS NEEDED TO PROVIDE A CONDUIT FOR THE CONCENTRATED FLOW OF WELT WATER TO ENSURE THAT SNOW MELT WILL NOT CAUSE EROSION AND SEDIMENT LOSS.
- SEPARATION WILL BE MAINTAINED BETWEEN THE TOPSOIL SUBSOIL AND/OR SNOW PILES TO PREVENT MIXING, WHERE THE SEPARATION CANNOT BE MAINTAINED. THE ENVIRONMENTAL MONITOR MAY APPROVE THE USE OF A PHYSICAL BARRIER ON A SITE-SPECIFIC BASIS. SUCH AS A THICK LAYER OF CERTIFIED WEED-FREE STRAW OR HAY MULCH OR SILT FENCE, BETWEEN THE SPOIL, TOPSOIL, AND/OR
- * THE AMOUNT OF OPEN EXCAVATION WILL BE MINIMIZED DURING WINTER CONSTRUCTION TO REDUCE THE AMOUNT OF FROZEN BACKFILL EXCAVATED SOIL MATERIAL WILL THEN BE USED TO BACKFILL THE TRENCH; THE SUBSOIL WILL BE REPLACED FIRST, AND THEN THE TOPSOIL IN CASES WHERE TOPSOIL HAS BEEN SEGREGATED. IN SOME SITUATIONS, FROZEN UPILAND TOPSOIL WILL NOT BE REPLACED DURING PROZEN CONDITIONS. THIS OPTION WILL BE IMPLEMENTED WHEN THE TRENCH, SUBSOIL BACKFILL, AND TOPSOIL ARE PROZEN PREVENTING PROPER REPLACEMENT OF SOILS AND COMPACTION OF THE TRENCH, INSTEAD, THE TRENCH WILL BE BACKFILLED WITH SUBSOIL ONLY, AND TOPSOIL REPLACEMENT AND FINAL READING WILL COCUR DURING THE SUBSEQUENT PREVENTING PROPERTY AND FINAL READING THE AREA TO RECLAIM AN EXCESSIVE TOPSOIL CROWN OR REPLAY SUBMIRE. THIS OPTION WILL PREVENT MULTIPLE TRIPS INTO AN AREA TO RECLAIM AN EXCESSIVE TOPSOIL CROWN OR REPLAY SUBSIDENCE THAT HAS TAKEN PLACE OVER THE TRENCH LINE DURING THE FREEZE/THAW CYCLE. THE TOPSOIL STOCKPILE WILL REMAIN TEMPORARILY STABILIZED WITH COVER CROP AND/OR MULCH (IN ACCORDANCE WITH SECTION 4.4 OF THE SWPPP) THROUGHOUT THIS PERIOD TO PREVENT EROSION AND OR SEDIMENT MIGRATION OFF THE CONSTRUCTION WORKSPACE, ADEQUATE BREAKS OR GAPS IN THE TOPSOIL STOCKPILES WILL BE INSTALLED FOR PRAINAGE SO THAT SPRING RUNOFF AND SNOW MELT WILL NOT IMPACT THE TOPSOIL PULSE AND ADJACENT AREAS.
- * IT IS NOT ANTICIPATED THAT CONSTRUCTION DEWATERING WILL BE CONDUCTED DURING WINTER CONDITIONS. IF CONSTRUCTION DEWATERING IS REQUIRED, THE PROCEDURES IN SECTION 4.13 OF THE SWPPP WILL BE FOLLOWED, WITH THE FOLLOWING ADDITIONAL CONSIDERATIONS: MEASURES WILL BE TAKEN TO PROTECT PUMPS FROM FREEZING TO AVOID DISRUPTIONS IN DEWATERING AND POTENTIAL SPILLS OR LEAKS OF LUBRICANTS OR FUEL (E.G., PLACE PUMPS INSIDE PORTABLE SHELTERS WITH HEATERS);

DEWATERING STRUCTURES MAY BE INSTALLED EARLY IN THE CONSTRUCTION PROCESS BEFORE FROZEN GROUND CONDITIONS EXIST, WHERE FEASIBLE;

REMOVAL OF DEWATERING STRUCTURES WILL BE CONDUCTED AS SOON AS PRACTICABLE AFTER COMPLETION OF DEWATERING IN AN ATTEMPT TO REMOVE THE STRUCTURE BEFORE THEY ARE FROZEN.

COLD SPRING MANOR WAVERLY STREET LOCUS SCALE: 1"=1000' PHASING NOTES: PHASING IS MANDATORY PER NEW HAMPSIRE DEPARTMENT OF ENVIRONMENTAL SERVICES AND NEW HAMPSHIRE DEPARTMENT OF ENVIRONMENTAL SERVICES ALTERATION OF TERRAIN SHALL BE NOTIFIED OF ANY ALTERATION OF THE PHASING PLAN. COLD SPRING MANOR TEMPORARY SEDIMENT BASINS SHALL BE CONSTRUCTED PRIOR TO THE ROUGH GRADING OF EACH PHASE. 3. EACH PHASE MUST BE STABILIZED BEFORE PROCEEDING TO SUCCESSIVE PHASES. WSTATE STREET AN ENVIRONMENTAL MONITOR SHALL BE EMPLOYED TO EVALUATE THE SITE DURING CONSTRUCTION. AREAS MUST BE STABILIZED PRIOR TO WINTER CONSTRUCTION SEASON FROM OCTOBER 15 THROUGH MAY 15 PURSUANT TO EN-Wg 1505.08 (1 AC OPEN) UNLESS A WINTER CONSTRUCTION/STABILIZATION PLAN IS SUBMITTED AND APPROVED. 6. THE NEW DRAINAGE INFRASTRUCTURE MUST BE CONSTRUCTED PRIOR TO CONSTRUCTION OF THE NEW BUILDING AND ASSOCIATED PARKING. IF THE INFRASTRUCTURE IS USED AS A TEMPORARY SETTLING AREA DURING CONSTRUCTION, THE INFRASTRUCTURE SHALL BE CLEANED OUT AND BROUGHT DOWN TO PROPOSED BOTTOM ELEVATION PRIOR TO CERTIFICATE OF OCCUPANCY FOR NEW BUILDING. STATE SYPEET EMERSON COURT PHASING SCHEDULE: PHASE 1 8.6 AC HAZELNUT AVENUE
ALL BUILDINGS ON WEST SIDE OF HAZELNUT AVENUE
ALL PONDS 1.5 AC OFFSITE WORK IN EMERSON STREET OFFSITE WIDENING OF BROCK AVE PHASE 2 5.3 AC CONSTRUCT: EASTERN 500'± OF PLUM LANE AND BUILDINGS FRONTING ON COMPLETED SECTION OF PLUM LANE
HAWTHORNE CIRCLE AND
ALL BUILDINGS ON HAWTHORNE CIRCLE
BUILDINGS ON EAST SIDE OF HAZENUT AVENUE PHASE 3 24 AC REMAINDER OF PLUM LANE AND BUILDINGS FRONTING ON REMAINDER OF PLUM LANE PHASE 4 0.8 AC CONSTRUCT: OFFSITE WORK ON OLD GONIC ROAD GRAPHIC SCALE (IN FEET) 1 inch = 100 ft PROJECT PARCEL TAX MAP 131, LOT 10 APPLICANT GREEN AND COMPANY 11 LAFAYETTE ROAD NORTH HAMPTON, NH 03862 TOTAL LOT AREA 29.9 ACRES ± HASING PLAN DRAWING No. Plai

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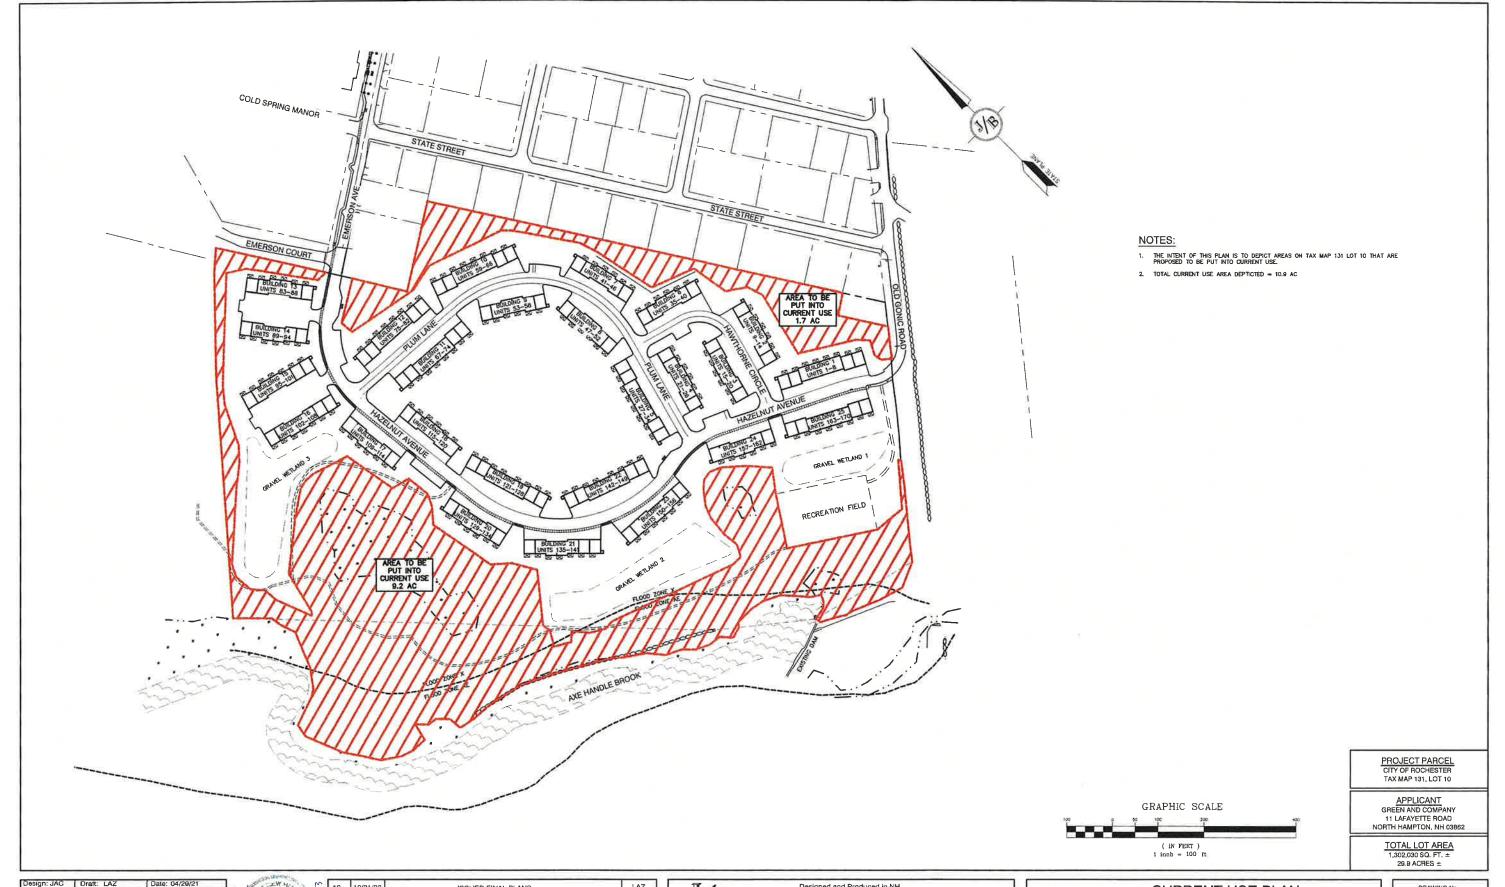
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BAYBERRY COMMONS 19 OLD GONIC ROAD, ROCHESTER, NH LEO P. LACOUTURE REV. TRUST & WILLIAM B. LACOUTURE

19 OLD GONIC RD., ROCHESTER, NH 03867 BK 4093 PG 148

WILSON STREET-

WAVERLY STREET



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15	5/23/23	REVISED PER CONDITIONS OF APPROVAL	LAZ
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Stratham, NH 03885

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Plan Name:	CURRENT USE PLAN
Project:	BAYBERRY COMMONS 19 OLD GONIC ROAD, ROCHESTER, NH
Owner of Record:	LEO P. LACOUTURE REV. TRUST & WILLIAM B. LACOUTURE 19 OLD GONIC RD., ROCHESTER, NH 03867 BK 4093 PG 148



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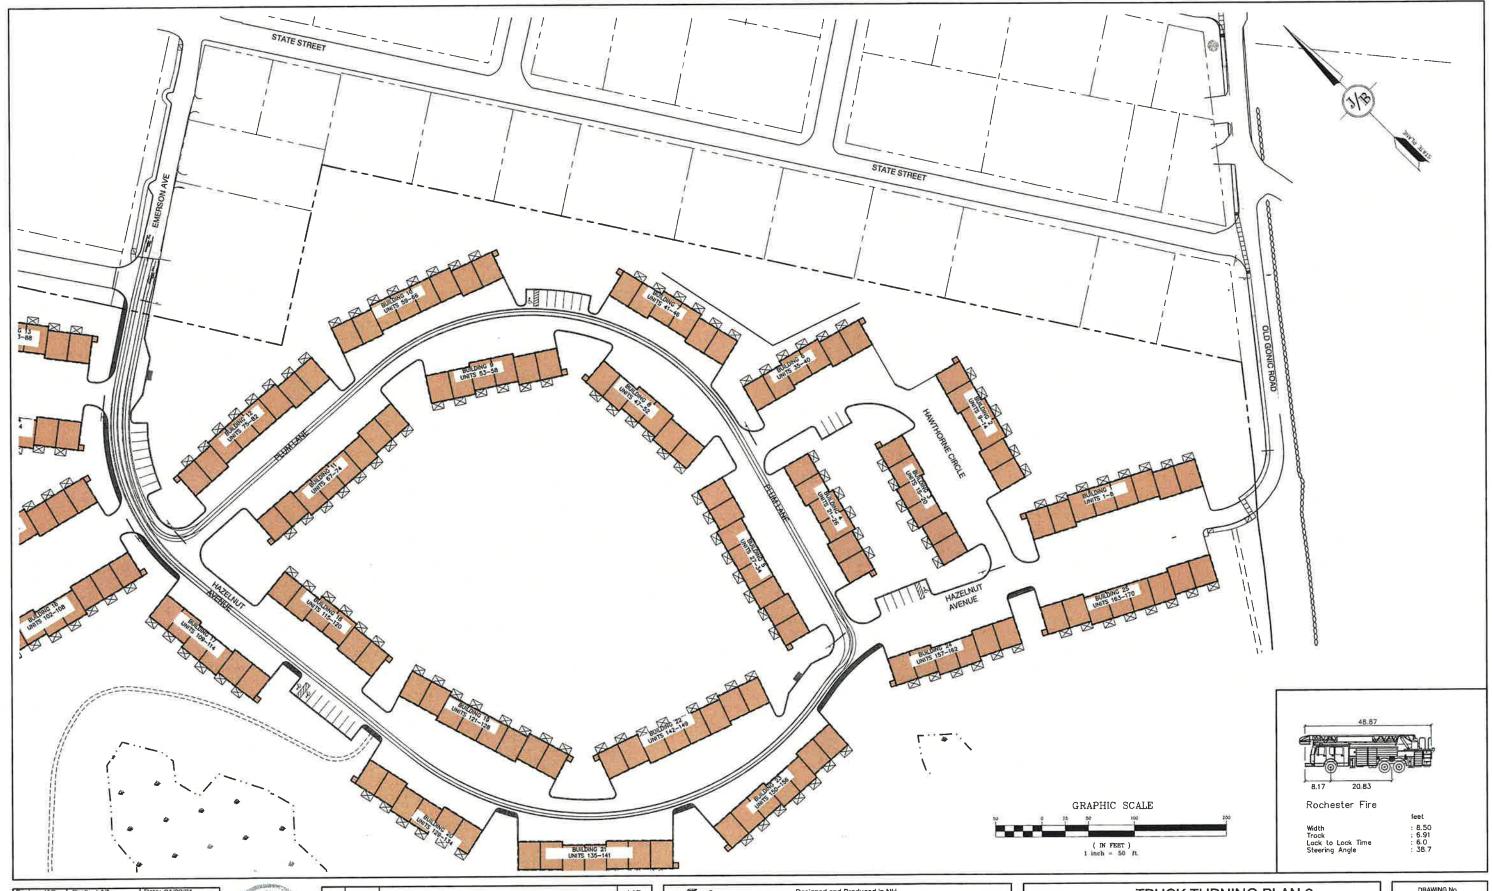


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17	8/24/23	REVISED PER TOWN COMMENTS	LAZ
16	6/14/23	REVISED OFFSITE PLANS	LAZ
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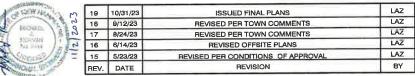
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Plan Name:	TRUCK TURNING PLAN 1
Project:	BAYBERRY COMMONS 19 OLD GONIC ROAD, ROCHESTER, NH
	O P. LACOUTURE REV. TRUST & WILLIAM B. LACOUTURE OLD GONIC RD., ROCHESTER, NH 03867 BK 4093 PG 148

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JBE PROJECT NO. 21090




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Plan Name:	TRUCK TURNING PLAN 2
Project:	BAYBERRY COMMONS 19 OLD GONIC ROAD, ROCHESTER, NH
Owner of Record:	LEO P. LACOUTURE REV. TRUST & WILLIAM B. LACOUTURE 19 OLD GONIC RD., ROCHESTER, NH 03867 BK 4093 PG 148





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Jones & Beach Engineers, Inc.

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FAX: 603-772-0227
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Plan Name:	TRUCK TURNING PLAN 3
Project:	BAYBERRY COMMONS 19 OLD GONIC ROAD, ROCHESTER, NH
Owner of Record:	LEO P. LACOUTURE REV. TRUST & WILLIAM B. LACOUTURE 19 OLD GONIC RD., ROCHESTER, NH 03867 BK 4093 PG 148

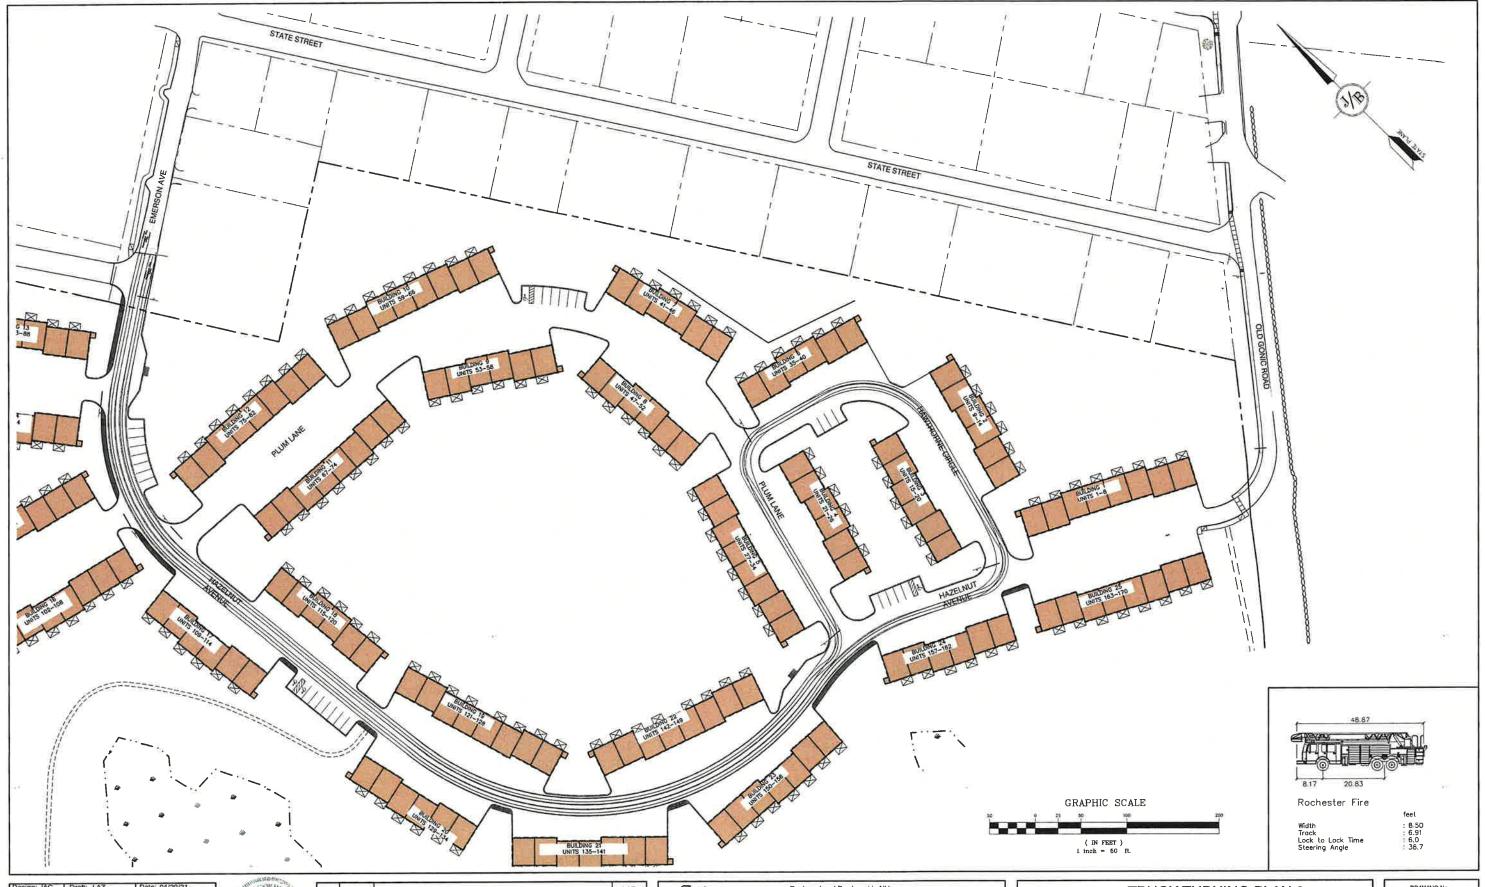TR3
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JBE PROJECT NO. 21090



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85 Portsmouth Ave. PO Box 219	Civil	Eng	ineering		ES FAX: 600	3-772-4746 3-772-0227
Stratham, NH 03885				E-MAIL: .	JBE@JONESANDBE	ACH.COM

	Plan Name:	CUT/FILL PLAN
	Project:	BAYBERRY COMMONS 19 OLD GONIC ROAD, ROCHESTER, NH
	Owner of Record:	LEO P. LACOUTURE REV. TRUST & WILLIAN B. LACOUTURE 19 OLD GONIC RD., ROCHESTER, NH 03867 BK 4093 PG 148

C/F
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JBE PROJECT NO. 21090