

PRELIMINARY SITE PLAN APPLICATION City of Rochester, New Hampshire

| Check one of the following: X Design Review C | onceptual (design review is strongly encouraged) |
|--|---|
| Property information | |
| Tax map #: 216 ; Lot #('s): 9 & 10 ; | Zoning district: Granite Ridge District |
| Property address/location: 68 & 76 Farmington Road | ; # acres:47.27 |
| Name of project (if applicable): The Ridge Marketplace - P | hase II |
| Proposed project Describe proposed project: Mixed-use development project and retail. | consisting of residential, entertainment spaces, restaurants, |
| Nonresidential: current bldg. size _0 s.f.; | total proposed bldg. size 83,678 s.f. |
| Residential: current # units _0; | total proposed # units 241 |
| City water? yes x no; how far is City water | er from the site? 300' |
| City sewer? yes x no ; how far is City sew | er from the site? 300' |
| Property owner | |
| Name (include name of individual): Farmington Associate | es Properties LLC |
| Mailing address: 250 First Ave, Suite 202, Needham, MA 02494 | -2886 |
| Telephone #: 781-559-3301 | Email: shaley@waterstonepg.com |
| Applicant/developer (if different from property of | wner) |
| Name (include name of individual): Scott Haley, Waterst | one Property Group |
| Mailing address: 117 Kendrick Street, Suite 325, Needham, MA | 02494 |
| Telephone #: 781-559-3301 | Email: shaley@waterstonepg.com |
| Engineer/surveyor | |
| Name (include name of individual): Erik Poulin, P.E., Jor | es & Beach Engineers, Inc. |
| Mailing address: PO Box 219, Stratham, NH 03885 | |
| Telephone #: 603-772-4746 | Fax #: |
| Email address: epoulin@jonesandbeach.com | Professional license #: 16669 |



Authorization to enter subject property

I hereby authorize members of the Rochester Planning Board, Zoning Board of Adjustment, Conservation Commission, Planning Department, and other pertinent City departments, boards and agencies to enter my property for the purpose of evaluating this application including performing any appropriate inspections during the application phase, review phase, post-approval phase, construction phase, and occupancy phase. This authorization applies specifically to those particular individuals legitimately involved in evaluating, reviewing, or inspecting this specific application/project. It is understood that these individuals must use all reasonable care, courtesy, and diligence when entering the property.

Signature of property owner:

VP HEAD OF COUSTRUCTIO

Date: 05/22/202

City of Rochester SCHEDULE OF FEES

(Updated by the Planning Board on July 19, 2010)

SITE PLAN FEES

Base fee: \$300.00

Per square foot:

0-1,000 sq. ft. \$.15 per sq. ft.

1,001-5,000 sq. ft. \$.12 per sq. ft. (\$150.00 + \$.12/sq. ft. over 1,000) 5,001-10,000 sq. ft. \$.09 per sq. ft. (\$630.00 + \$.09/sq. ft. over 5,000) 10,001 + sq. ft. \$.06 per sq. ft. (\$1,080 + \$.06/sq. ft. over 10,000)

Industrial projects

Base fee: \$300.00

Per square foot:

0-1,000 sq. ft. \$.08 per sq. ft.

1,001-5,000 sq. ft \$.07 per sq. ft. (\$80.00 + \$.07/sq. ft. over 1,000) 5,001-10,000 sq. ft. \$.05 per sq. ft. (\$360.00 + \$.05/sq. ft. over 5,000) 10,001 + sq. ft \$.03 per sq. ft. (\$610.00 + \$.03/sq. t. over 10,000)

Residential projects

Base fee: \$350.00 Per new unit: \$175.00

Other projects

Minor site plan review: \$300.00

Special Downtown: No fee

Home Occupation: \$50.00

Day Care –care of no more than 3 children in home: \$50.00

(requires Home Occupation review)

Day Care – Family Day Care in Home: \$300.00

(requires Minor Site review)

Day Care Center (requires Planning Board review): \$300.00

Farmers or flea market: \$125.00

Excavation: \$500.00

SUBDIVISION FEES

Subdivision without new street base fee: \$300.00

Subdivision without new street per lot fee: \$100.00

Subdivision with new street base fee: \$700.00

Subdivision with new street per lot fee: \$225.00

(Over)

(Schedule of Fees continued)

*Note that the per lot subdivision fee is based upon the number of additional building lots (whether vacant or already with a building/house) that will result; for example, if one new lot is carved out of a single lot that is a "2 lot subdivision" yielding one additional building lot

Lot line adjustment (per pair of lots affected): \$175.00

Lot combination: \$50.00

Condominium conversion: \$50.00 + City attorney fees for review, where applicable

OTHER FEES

Zoning Board of Adjustment fees (including variance, special exception, equitable waiver, and administrative appeal applications): \$175.00

Preliminary review (design review or conceptual): \$125.00

Fee for extensions to meet conditions when the request is submitted prior to the deadline for meeting conditions: \$100.00

Fee for extensions to meet conditions when the request is submitted after the deadline for meeting conditions: \$150.00

Amendments to approved site plans or subdivisions: \$125.00

Modifications to approved site plans or subdivisions that are reviewed by the Planning Board: \$125.00

Abutter's notification: The applicant pays the current postage fee for a certified letter for each abutter. (Please contact the Planning Department)

17 Abutters x \$4.75 = \$80.75

Inspections shall be billed at an hourly rate as determined by the City of Rochester Public Works Department.

Planned Unit Development: \$50.00 per gross acre (\$500 due at preliminary review and balance at regular review)

Historic District Commission review: No Fee

Monumentation fees: table of fees available upon request

TOTAL = \$205.75

Letter of Authorization

I, Scott Haley of Waterstone Property Group, 117 Kendrick Street, Suite 325, Needham, MA 02494, developer of property located in Rochester, NH, known as Tax Map 216, Lot 9, do hereby authorize Jones & Beach Engineers, Inc., PO Box 219, Stratham, NH, to act on my behalf concerning the previously mentioned property. The parcel is located at 68 Farmington Road in Rochester, NH.

I hereby appoint Jones & Beach Engineers, Inc., as my agent to act on my behalf in the review process, to include any required signatures.

Witness

Waterstone Property Group

Date

Letter of Authorization

Farmington Associates Properties, LLC, 250 First Avenue, Suite 202, Needham, MA 02494-2886, owner of property located in Rochester, NH, known as Tax Map 216, Lot 9, do hereby authorize Jones & Beach Engineers, Inc., PO Box 219, Stratham, NH, to act on my behalf concerning the previously mentioned property. The parcel is located at 68 Farmington Road in Rochester, NH.

I hereby appoint Jones & Beach Engineers, Inc., as my agent to act on my behalf in the review process, to include any required signatures.

Witness

Farmington Associates

Property Group

Date

Doc # 0019415 Dec 23, 2016 3:48 PM Book 4445 Page 0474 Page 1 of 3 Register of Deeds, Strafford County





WARRANTY DEED

KNOW ALL MEN BY THESE PRESENTS that **ROUTE 11 INVESTMENTS**, **INC.**, (f/k/a Stratham Industrial Properties, Inc.), a New Hampshire corporation with a place of business at 142 Portsmouth Avenue, Stratham, New Hampshire 03885

For consideration paid, grants to **FARMINGTON ASSOCIATES PROPERTIES**, **LLC**, a Delaware limited liability company with a place of business at 322 Reservoir Street, Needham Massachusetts 02494

With WARRANTY COVENANTS, the following described premises:

A certain parcel of land located on the westerly side of NH Route 11 (a/k/a Farmington Road), in the City of Rochester, County of Strafford, State of New Hampshire, shown as Tax Map 216, Lot 9 on a plan of land entitled "ALTA/ACSM Land Title Survey for Copper Creek Capital Partners, Land of Stratham Industrial Properties, Inc. (Tax Map 216, Lot 9), and Packy's Investment Properties, LLC (Tax Map 216, Lot 8), Route 11 (A.K.A. Farmington Road), Rochester, New Hampshire" dated October 23, 2014 and revised to January 26, 2016 by Doucet Survey, Inc. (the "Plan"), said plan being recorded herewith, and being more particularly bounded and described as follows:

Beginning at a rebar at the northwesterly corner of land now or formerly of Packy's Investment Properties, LLC and the northeasterly corner of the parcel herein described; thence along land of said Packy's Investment Properties, LLC the following courses and distances;

S 36°04'28" WW, a distance of 106.69' to a drill hole in a stone wall; thence,

S 38°54'04" W, a distance of 54.92'; thence,

S 33°23'25" W, a distance of 79.98' to a rebar; thence,

S 36°31'25" W, a distance of 199.97' to a rebar; thence,

S 36°25'56" W, a distance of 536.63' to a drill hole in the beginning of a stone wall; thence,

S 36°01'02" W, a distance of 69.92' to the end of said stone wall; thence,

S 36°01'02" W, a distance of 41.87' to the beginning of a stone wall; thence, along said stone wall the following courses and distances;

S 36°01'02" W, a distance of 64.70' to a drill hole; thence,

S 36°07'01" W, a distance of 113.03'; thence,

S 36°12'55" W, a distance of 81.70' to a drill hole; thence,

S 35°37'49" W, a distance of 117.89' to a drill hole at the end of said stone wall at land now or formerly of Richard Melanson; thence,

along said Melanson land the following courses and distances;

N 55°03'56" W, a distance of 90.70' to a drill hole at the beginning of a stone wall; thence,

N 55°22'24" W, a distance of 87.27' along said stone wall to an intersection of stone walls; thence,

N 56°33'45" W, a distance of 21.78' to a drill hole at the end of said stone wall; thence,

N 53°52'00" W, a distance of 331.06' to a drill hole at the beginning of a stone wall; thence,

N 54°26'17" W, a distance of 79.68' to a rebar at the end of said stone wall at land now or formerly of Public Service Company of New Hampshire; thence, N 40°21'48" E, a distance of 1726.61' along land of said Public Service Company of New Hampshire to the westerly side of NH Route 11 (a/k/a Farmington Road), said point being S 40°21'48" W, a distance of 2.48' from a concrete bound; thence S 26°41'36" E, a distance of 544.75' along the westerly side of NH Route 11 (a/k/a Farmington Road) to the point of beginning.

Said parcel having an area of 880,798 square feet or 20.22 acres, more or less.

Meaning and intending to describe and convey a portion of the premises conveyed in a deed of Roger E. Page, Trustee under the Will of Olive Page Tufts to Stratham Industrial Properties, Inc. (n/k/a Route 11 Investments, Inc.) dated November 27, 1985, recorded in the Strafford County Registry of Deeds at Book 1199, Page 640.

The above conveyance and property is subject to or with the benefit of the following:

- 1) Including a 50-foot right of access from Route 11 to the aforesaid property as reserved in deed from Earl R. Tufts and Olive P. Tufts to the State of New Hampshire dated October 5, 1957, recorded in the Strafford County Registry of Deeds at Book 680, Page 445.
- 2) With the benefit of an Easement Deed recorded in the Strafford County Registry of Deeds at Book 4422, Page 72, together with all right, title and interest in said easement for the benefit of Lot 8 as shown on the Plan.
- With the benefit of an easement reserved for the benefit of the parcel in the deed to Waterstone Rochester, LLC recorded in Volume 4238, Page 739.
- 4) With the benefit of an easement over land n/f of PSNH reserved in deed to PSNH recorded at Book 851, Page 488, provided that the use of such easement does not interfere with the use of the property for public utility purposes.

[End of Page. Signatures appear on next Page.]

WARRANTY DEED Route 11 Investments, Inc.

to

Grantor's Signature Page

EXECUTED AND DELIVERED as a sealed instrument as of this 21 day of December, 2016.

GRANTOR:

ROUTE 11 INVESTMENTS, INC., a New

Hampshire compration

Bv:

STATE OF NEW HAMPSHIRE COUNTY OF ROCKINGHAM

On this, the day of December, 2016 before me, the undersigned officer, personally appeared Mark Stevens who acknowledged himself to be the duly authorized President of Route 11 Investments, Inc., a New Hampshire corporation, and that he as such officer, being authorized so to do, executed the foregoing instrument for the purposes therein contained. Before me,

Justice of the Peace/Notary Public

Commission Expires:

LEE PALADINO Notary Public - New Hampshire

My Commission Expires December 2, 2020

ABUTTERS LIST (DIRECT) AS OF MAY 22, 2023 FOR

68 & 76 FARMINGTON ROAD, ROCHESTER, NH JBE PROJECT No. 21173.1

OWNER OF RECORD:

TAX MAP 216/ LOT 9 FARMINGTON ASSOCIATES PROPERTIES LLC 250 FIRST AVE, SUITE 202 NEEDHAM, MA 02494-2886 BK 4445/PG 474

TAX MAP 216/LOT 10 – SUBJECT PARCEL TAX MAP 216/LOT 19 – ABUTTING PARCEL TAX MAP 220/LOT 22 - ABUTTING PARCEL PUBLIC SERVICE CO OF NH DBA EVERSOURCE ENERGY PO BOX 270 HARTFORD, CT 06141-0270

APPLICANT:

WATERSTONE PROPERTY GROUP ATTN. SCOTT HALEY 117 KENDRICK STREET SUITE 325 NEEDHAM, MA 02494

ABUTTERS:

216/6 48 FARMINGTON LLC 48 FARMINGTON RD ROCHESTER, NH 03867

216/11 & 11-1 WATERSTONE ROCHESTER LLC % WATERSTONE RETAIL DEVELOPMENT 250 1ST AVE, STE 202 NEEDHAM HEIGHTS, MA 02494 216/18-2 ROCHESTER HOSPITALITY LLC % RAICHE & CO CPAS PA 680 CENTRAL AVE, STE 101 DOVER, NH 03820

216/20 CRANE DRIVE LLC 151 PORTSMOUTH AVE EXETER, NH 03833

216/24 BLACK MARBLE REALTY TRUST % SEACOAST MOTORCYCLES INC PO BOX 1740 NORTH HAMPTON, NH 03862-1740

217/1 ROBERT L GUSTAFSON TRUST % ROBERT L GUSTAFSON TRUSTEE 144 N WASHINGTON DR SARASOTA, FL 34236-1418

217/59 ANDREA MANK SCOTT LAFFEY 125 TEN ROD RD ROCHESTER, NH 03867

217/60 POMROY FAMILY REVOC TRUST % MERLE 1. & BARBARA G. POMROY 12 ADAMS AVE ROCHESTER, NH 03867

220/28 RONALD & LISA GRENIER 110 TEN ROD RD ROCHESTER, NH 03867

220/30 MICHAEL & ALBERTA KEDDY 111 TEN ROD RD ROCHESTER, NH 03867 220/32-3 RICHARD MELANSON 99 TEN ROD RD ROCHESTER, NH 03867

220/32-4 ROBERT FORCIER JR 107 TEN ROD RD ROCHESTER, NH 03867

220/32-5 JEFFREY & KAREN LABRECQUE 109 TEN ROD RD ROCHESTER, NH 03867

ENGINEERS/SURVEYORS:

JONES & BEACH ENGINEERS, INC. ATTN: ERIK POULIN, P.E. PO BOX 219 STRATHAM, NH 03885

FARMINGTON ASSOCIATES PROPERTIES LLC 250 FIRST AVE, SUITE 202 NEEDHAM, MA 02494-2886

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> PUBLIC SERVICE CO OF NH DBA EVERSOURCE ENERGY **PO BOX 270**

PUBLIC SERVICE CO OF NH DBA EVERSOURCE ENERGY PO BOX 270 HARTFORD, CT 06141-0270

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JONES & BEACH ENGINEERS, INC. ATTN: ERIK POULIN, P.E. PO BOX 219 STRATHAM, NH 03885 JONES & BEACH ENGINEERS, INC. ATTN: ERIK POULIN, P.E. PO BOX 219 STRATHAM, NH 03885 JONES & BEACH ENGINEERS, INC. ATTN: ERIK POULIN, P.E. PO BOX 219 STRATHAM, NH 03885



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Tax Parcels

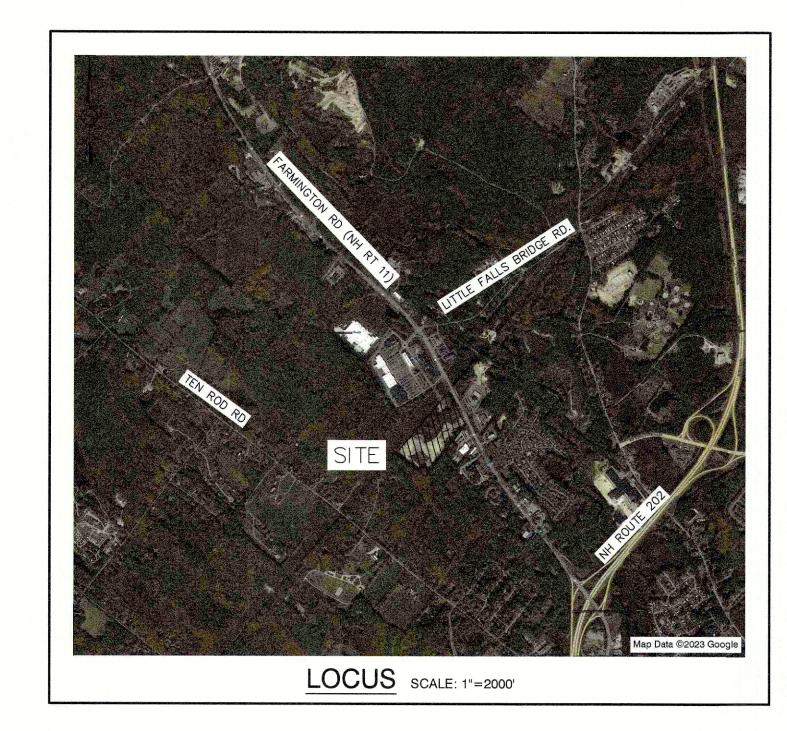
0 0.07 0.15 0.3 km Esr, HERE, Garmin, INCREMENT P, Intermap, NGA, USGS, Esri Community Maps Contributors, Rochester GIS, © OpenStreetMap, Microsoft, 0.2 mi 1:9,028 0.1 0.05

GENERAL LEGEND CAPE COD BERM POURED CONCRETE CURB FIRE PROTECTION LINE THRUST BLOCK IRON PIPE/IRON ROD DRILL HOLE IRON ROD/DRILL HOLE STONE/GRANITE BOUND 100x0 100x0 SPOT GRADE × 100.00 PAVEMENT SPOT GRADE CURB SPOT GRADE BENCHMARK (TBM) DOUBLE POST SIGN _0_0 SINGLE POST SIGN TEST PIT FAILED TEST PIT MONITORING WELL PERC TEST PHOTO LOCATION TREES AND BUSHES UTILITY POLE LIGHT POLES DRAIN MANHOLE SEWER MANHOLE HYDRANT WATER GATE WATER SHUT OFF REDUCER SINGLE GRATE CATCH BASIN DOUBLE GRATE CATCH BASIN \overline{H} TRANSFORMER CULVERT W/WINGWALLS)---- D ----CULVERT W/FLARED END SECTION D-D-CULVERT W/STRAIGHT HEADWALL ├── D ── **(23338)** STONE CHECK DAM ~> ~~ DRAINAGE FLOW DIRECTION 4K SEPTIC AREA WETLAND IMPACT XXXXX VEGETATED FILTER STRIP RIPRAP OPEN WATER नीर नीर नीर FRESHWATER WETLANDS TIDAL WETLANDS STABILIZED CONSTRUCTION **ENTRANCE** CONCRETE GRAVEL SNOW STORAGE RETAINING WALL

RIDGE MARKETPLACE PHASE II MARKETPLACE BLVD, ROCHESTER, NH



TAX MAP 216 LOTS 9, 10 68 FARMINGTON RD, ROCHESTER, NH



SHEET INDEX

COVER SHEET

EXISTING CONDITIONS PLAN

OVERALL SITE PLAN

SITE PLANS

OVERALL GRADING AND DRAINAGE PLAN

GRADING AND DRAINAGE PLANS

OVERALL UTILITY PLAN

C4-1 - C4-3 UTILITY PLANS

D1 - D5 DETAIL SHEETS

LP1 LIGHTING PLAN

E1 **EROSION AND SEDIMENT CONTROL DETAILS**

TRAFFIC ENGINEER VANASSE & ASSOCIATES, INC. 10 N.E. BUSINESS CENTER DRIVE, SUITE 314 ANDOVER, MA 01810 (978) 474-8800

CONTACT: JEFFREY DIRK

WETLAND CONSULTANT GOVE ENVIRONMENTAL SERVICES, INC. 8 CONTINENTAL DRIVE BLDG 2, UNIT H EXETER, NH 03833 (603) 778-0644

CONTACT: JAMES GOVE

LANDSCAPE DESIGNER TERRAIN PLANNING & DESIGN, LLC 311 KAST HILL ROAD HOPKINTON, NH 03229 (603) 746-3512 CONTACT: ERIC BUCK

WATER AND SEWER

DEPARTMENT OF PUBLIC WORKS 209 CHESTNUT HILL RD ROCHESTER, NH 03867 (603) 332-3110

ELECTRIC EVERSOURCE 740 N COMMERCIAL ST PO BOX 330 MANCHESTER, NH 03105-0330 (603) 662-7764

ELECTRIC UNITIL NEW HAMPSHIRE **6 LIBERTY LANE WEST** HAMPTON, NH 03842 (603) 772-0775

TELEPHONE CONSOLIDATED COMMUNICATIONS 100 TRI CITY ROAD SOMERWORTH, NH 03878 ATTN: DAVE KESTNER (603) 743-1114

CABLE TV COMCAST COMMUNICATION CORPORATION 334-B CALEF HIGHWAY EPPING, NH 03042-2325 (603) 679-5695

| PROJECT PARCEL TOWN OF ROCHESTER, NH TAX MAP 216, LOTS 9, 10 | APPROVED — ROCHESTER, NH PLANNING BOARD |
|---|--|
| APPLICANT WATERSTONE PROPERTIES GROUP 117 KENDRIK ST, SUITE 325 NEEDHAM, MA 02494 | |
| TOTAL LOT AREA LOT 9 1,144,321± SQ. FT. 26.27± ACRES 21.00± ACRES | DATE: |


| Design: EMF | Draft: | EJH | Date: 05/23/2023 |
|--------------|-------------|----------------|-------------------------|
| Checked: EM | IP Scale: | AS SHOWN | Project No.: 21173 |
| Drawing Name | : 21173.1 | -PHASE2-PLAN | N.DWG |
| THIS PLAN SH | ALL NOT BE | MODIFIED WITH | IOUT WRITTEN |
| PERMISSION F | ROM JONES | & BEACH ENG | INEERS, INC. (JBE). ANY |
| ALTERATIONS | , AUTHORIZE | ED OR OTHERW | ISE, SHALL BE AT THE |
| USER'S SOLE | RISK AND WI | THOUT LIABILIT | Y TO JBE. |


| 0 | 05/23/23 | ISSUED FOR REVIEW | GDR |
|------|----------|-------------------|-----|
| REV. | DATE | REVISION | BY |

| Designed and Produced in NH | | | | | |
|-----------------------------|-------|----|-----------|-----------|-------------|
| \mathbb{R} | Jones | & | Beach | Engineers | , Inc. |
| 85 Portsmouth A | Civil | En | gineering | Services | 03-772-4746 |

| | V | | | STATE OF THE PARTY |
|-----------------------|----------|-------------|-----------------|--|
| 85 Portsmouth Ave. | Civil | Engineering | Services | 603-772-4746 |
| PO Box 219, Stratham, | NH 03885 | - | E-MAIL: JBE@JON | IESANDBEACH.COM |

| Plan Name: | COVER SHEET | |
|---------------------|--|--|
| Project: | RIDGE MARKETPLACE PHASE II MARKETPLACE BLVD, ROCHESTER, NH | |
| Owner of Record: | FARMINGTON ASSOCIATES PROPERTIES, LLC 322 RESERVOIR ST, NEEDHAM, MA 02494 | |

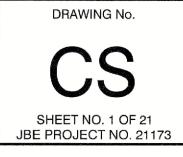

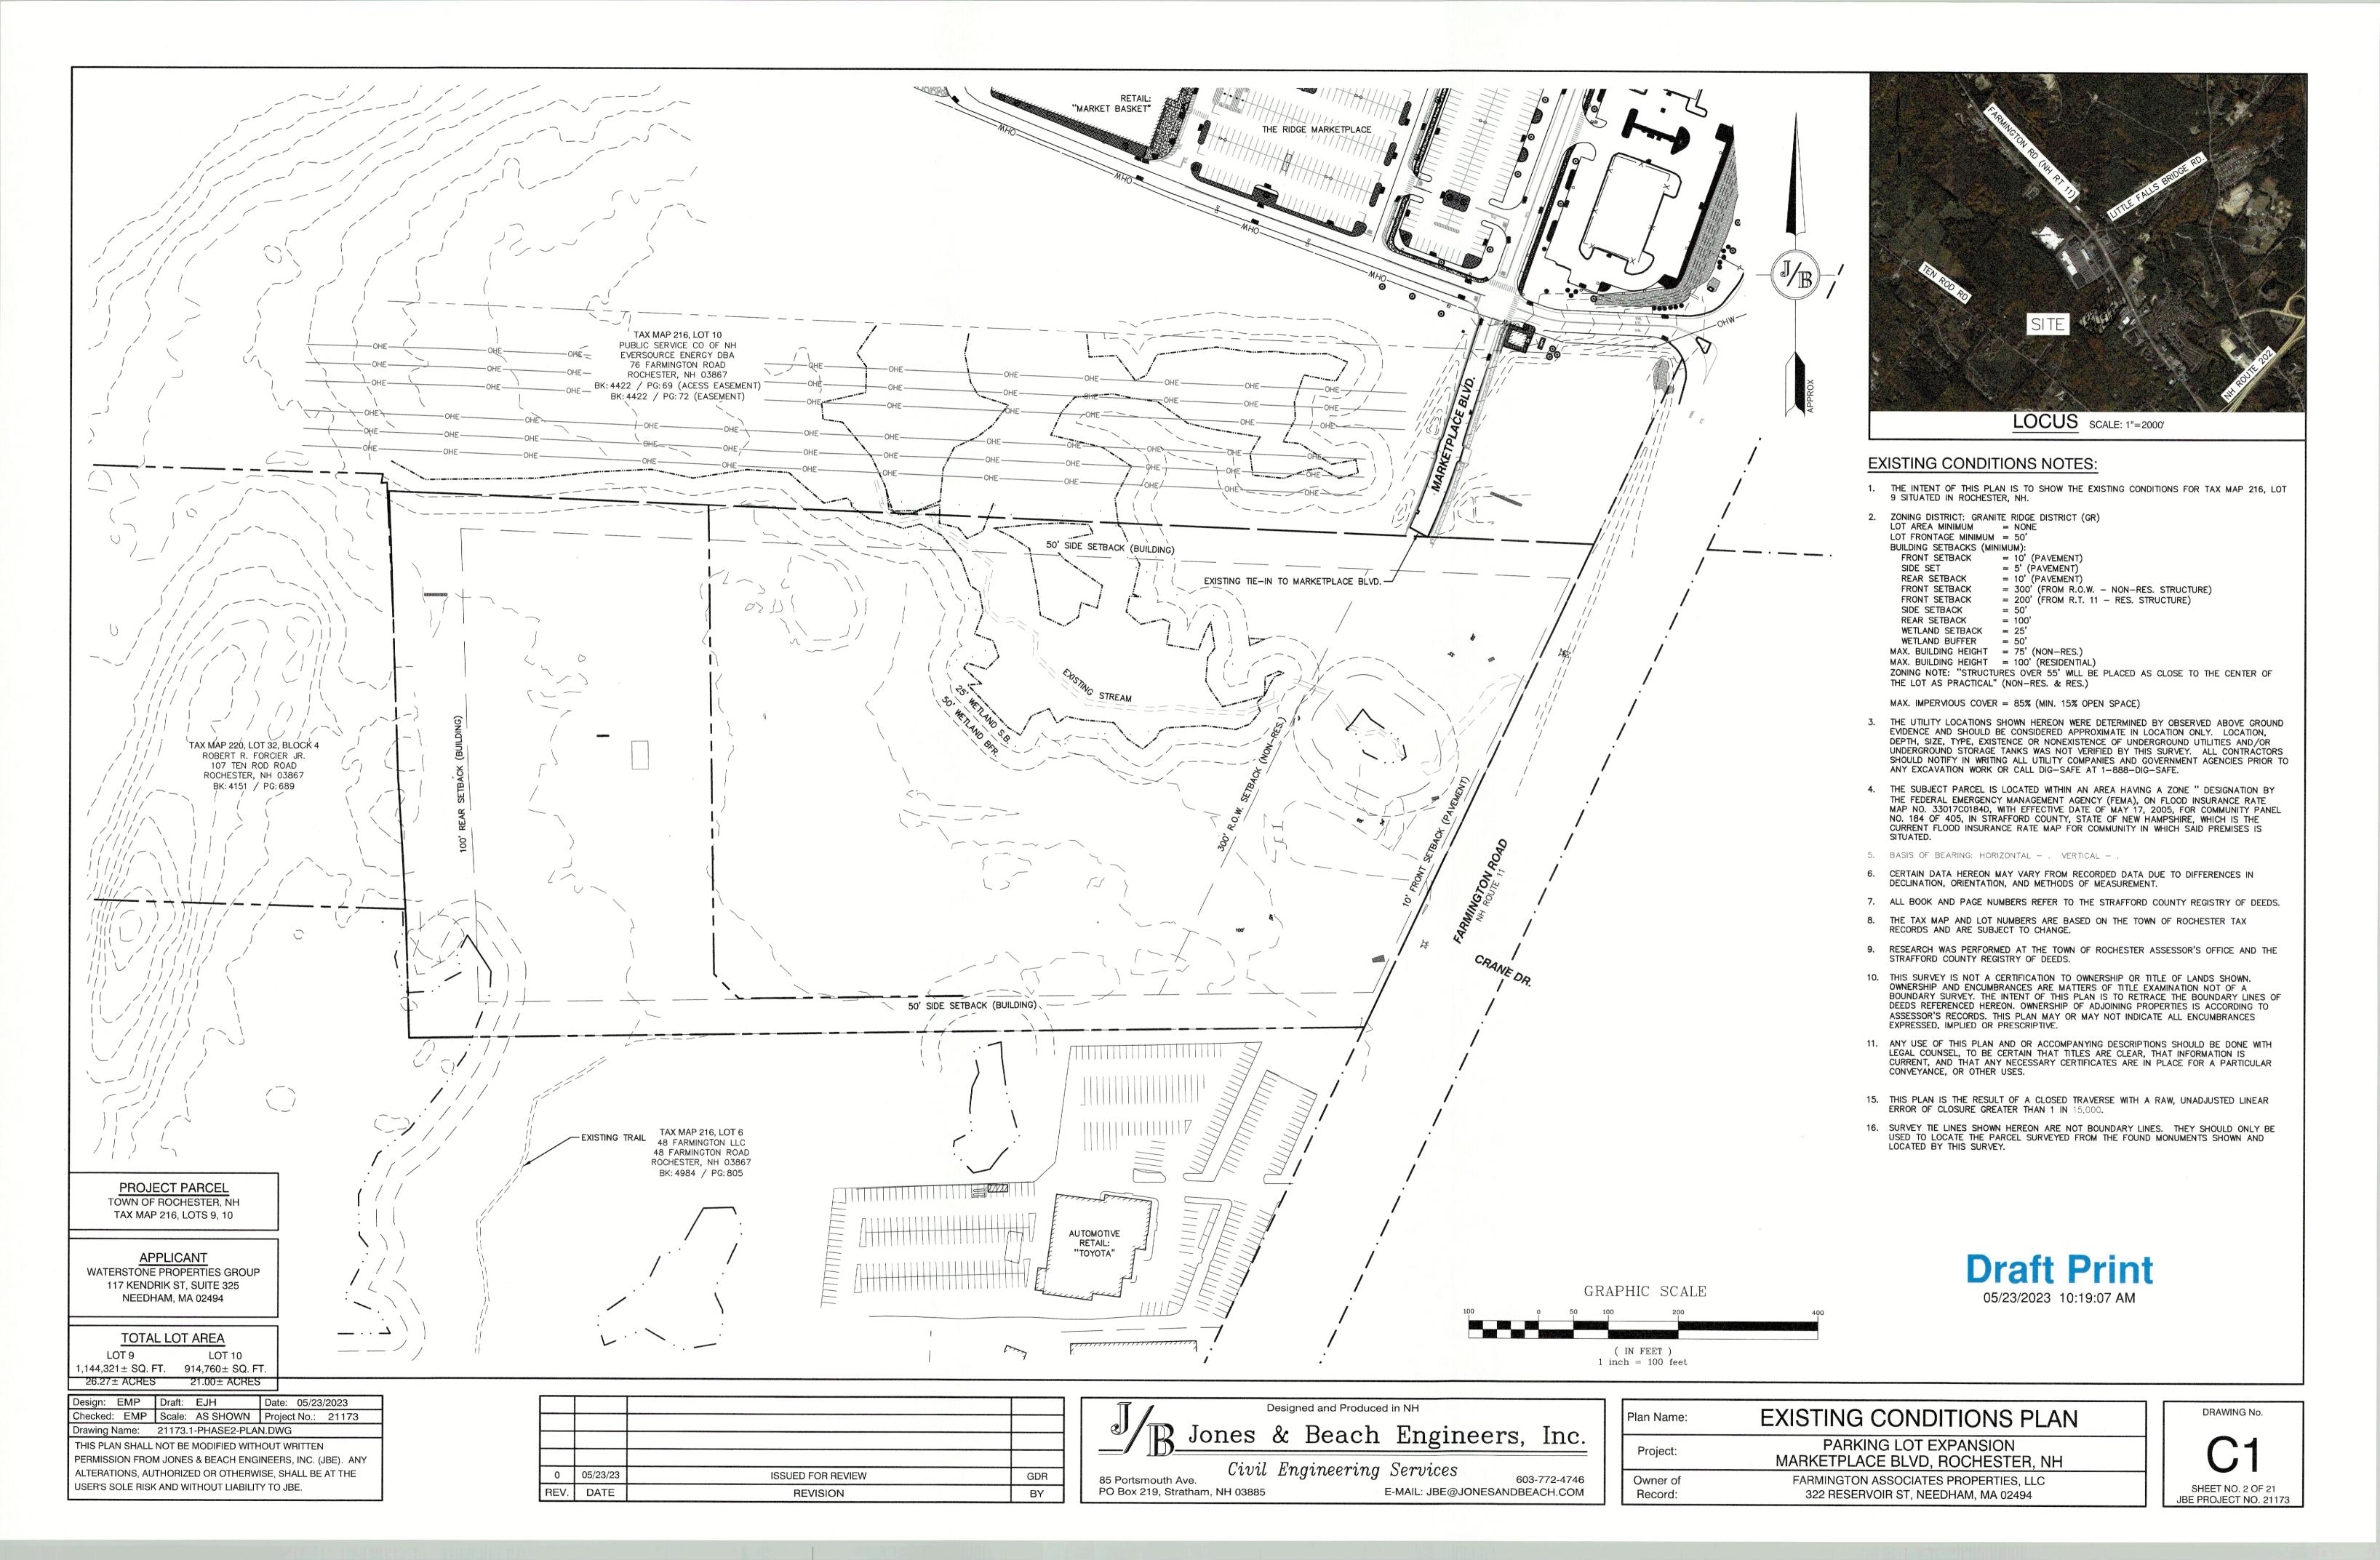

SITE NOTES:

- THE INTENT OF THIS PLAN IS TO SHOW A MIXED-USE COMMERICAL AND RESIDENTIAL DEVELOPMENT CONSISTING OF
- ZONING DISTRICT: GRANITE RIDGE DISTRICT (GR) LOT AREA MINIMUM = NONE LOT FRONTAGE MINIMUM = 50'
- BUILDING SETBACKS (MINIMUM): FRONT SETBACK = 10' (PAVEMENT) SIDE SET = 5' (PAVEMENT) REAR SETBACK = 10' (PAVEMENT) FRONT SETBACK = 300' (FROM R.O.W. - NON-RES. STRUCTURE) FRONT SETBACK = 200' (FROM R.T. 11 - RES. STRUCTURE)
- SIDE SETBACK = 100' REAR SETBACK WETLAND SETBACK = 25' WETLAND BUFFER = 50'
- MAX. BUILDING HEIGHT = 75' (NON-RES.) MAX. BUILDING HEIGHT = 100' (RESIDENTIAL) ZONING NOTE: "STRUCTURES OVER 55" WILL BE PLACED AS CLOSE TO THE CENTER OF THE LOT AS PRACTICAL" (NON-RES. & RES.)
- MAX. IMPERVIOUS COVER = 85% (MIN. 15% OPEN SPACE) PROP. IMPERVIOUS COVER= 538,747 S.F. (26.16%)
- TOTAL BUILDING FOOTPRINT (COMMERCIAL) = 83,678 S.F. (55%) TOTAL BUILDING FOOTPRINT (RESIDENTIAL) = 68,555 S.F.(45%) TOTAL DISTURBANCE = 935569 S.F.
- THIS PLAN SET HAS BEEN PREPARED BY JONES & BEACH ENGINEERS,

- BASED ON DATA OBTAINED FROM ON-SITE FIELD SURVEY AND EXISTING 18. MUNICIPAL RECORDS. THROUGHOUT THE CONSTRUCTION PROCESS, THE CONTRACTOR SHALL INFORM THE ENGINEER IMMEDIATELY OF ANY FIELD DISCREPANCY FROM DATA AS SHOWN ON THE DESIGN PLANS, INCLUDING ANY UNFORESEEN CONDITIONS, SUBSURFACE OR OTHERWISE, FOR EVALUATION AND RECOMMENDATIONS. ANY CONTRADICTION BETWEEN ITEMS ON THIS PLAN/PLAN SET, OR BETWEEN THE PLANS AND ON-SITE CONDITIONS, MUST BE RESOLVED BEFORE RELATED CONSTRUCTION HAS
- 5. THE SUBJECT PARCEL IS NOT LOCATED WITHIN AN AREA HAVING A SPECIAL FLOOD HAZARD ZONE DESIGNATION BY THE FEDERAL EMERGENCY MANAGEMENT AGENCY (FEMA) AS SHOWN ON FLOOD INSURANCE RATE MAP NO. 33017C0184D, WITH EFFECTIVE DATE OF MAY 17, 2005.

BEEN INITIATED.

- 13. LANDOWNERS ARE RESPONSIBLE FOR COMPLYING WITH ALL APPLICABLE LOCAL, STATE AND FEDERAL WETLAND REGULATIONS, INCLUDING PERMITTING REQUIRED UNDER THESE REGULATIONS.
- 14. ALL CONSTRUCTION ACTIVITIES SHALL BE PERFORMED IN ACCORDANCE WITH THE STORMWATER POLLUTION PREVENTION PLAN (S.W.P.P.P.). THIS DOCUMENT IS TO BE KEPT ONSITE AT ALL TIMES AND UPDATED AS
- 15. PRIOR TO THE START OF CONSTRUCTION, THE CONTRACTOR SHALL COORDINATE WITH THE ENGINEER, ARCHITECT AND/OR OWNER, IN ORDER TO OBTAIN AND/OR PAY ALL THE NECESSARY LOCAL PERMITS, FEES AND
- 16. ALL CONSTRUCTION WILL CONFORM TO TOWN STANDARDS AND REGULATIONS, AND NHDOT STANDARD SPECIFICATIONS FOR ROAD AND BRIDGE CONSTRUCTION, WHICHEVER IS MORE STRINGENT.
- 17. ALL CONSTRUCTION ACTIVITIES SHALL CONFORM TO LABOR OCCUPATIONAL SAFETY AND HEALTH ADMINISTRATION (OSHA) RULES AND REGULATIONS.

- LANDOWNERS ARE RESPONSIBLE FOR COMPLYING WITH ALL APPLICABLE 22. LOCAL, STATE AND FEDERAL WETLAND REGULATIONS, INCLUDING PERMITTING REQUIRED UNDER THESE REGULATIONS.
- 14. ALL PROPOSED SIGNAGE SHALL CONFORM WITH THE TOWN ZONING REGULATIONS, UNLESS A VARIANCE IS OTHERWISE REQUESTED.
- ALL SIGNAGE AND PAVEMENT MARKINGS SHALL BE IN ACCORDANCE WITH THE LATEST EDITION OF THE MANUAL ON UNIFORM TRAFFIC CONTROL DEVICES (M.U.T.C.D.) AND NHDOT STANDARDS AND SPECIFICATIONS (NON-REFLECTORIZED PAVEMENT MARKINGS), UNLESS OTHERWISE NOTED.
- ALL PARKING STALLS SHALL BE SEPARATED USING 4" WIDE SOLID STRIPES. STRIPING SHALL BE 100% ACRYLIC TYPE, LOW VOC, FAST DRYING, IN A COLOR OF WHITE.
- 17. ALL STOP BARS SHALL BE 18" IN WIDTH IN A COLOR OF WHITE; ALL TRAFFIC ARROWS SHALL BE PAINTED IN A COLOR OF WHITE.
- 18. ALL CURBING TO BE VERTICAL GRANITE WITH A MINIMUM RADIUS OF 2', UNLESS OTHERWISE NOTED.
- 19. ALL BUILDING DIMENSIONS SHALL BE VERIFIED WITH THE ARCHITECTURAL AND STRUCTURAL PLANS PROVIDED BY THE OWNER. ANY DISCREPANCIES SHOULD BE BROUGHT TO THE ATTENTION OF THE ENGINEER AND OWNER PRIOR TO THE START OF CONSTRUCTION. BUILDING DIMENSIONS AND
- 20. SNOW TO BE STORED AT EDGE OF PAVEMENT AND IN AREAS SHOWN ON THE PLANS, OR TRUCKED OFFSITE TO AN APPROVED SNOW DUMPING

AREAS TO BE TO OUTSIDE OF MASONRY, UNLESS OTHERWISE NOTED.

21. ROOF TOP HEATING AND AIR CONDITIONING UNITS (RTU's) SHALL BE DESIGNED TO VENT UPWARDS AND AIR INTAKES SHALL BE DIRECTED AWAY

- NO OVERNIGHT TRACTOR TRAILER PARKING SHALL BE ALLOWED ON THE PREMISES. NO TRUCK HORN BLOWING SHALL BE ALLOWED ON THE
- 23. ALL ARCHITECTURAL BLOCK RETAINING WALLS ARE TO BE DESIGNED AND STAMPED BY THE MANUFACTURER'S STRUCTURAL ENGINEER. CONTRACTOR TO COORDINATE WITH APPROVED MANUFACTURER PRIOR TO INSTALLATION.
- DUMPSTERS AND/OR ROLL-OFFS ARE NOT TO BE PICKED UP BETWEEN 7:00 PM AND 7:00 AM.
- 25. ALL CONSTRUCTION ACTIVITIES SHALL CONFORM TO LABOR OCCUPATIONAL SAFETY AND HEALTH ADMINISTRATION (OSHA) RULES AND REGULATIONS.
- 26. ALL PRECAST CONCRETE PRODUCTS WILL BE SOURCED FROM MANUFACTURING FACILITIES IN COMPLIANCE WITH THE NATIONAL PRECAST CONCRETE ASSOCIATION (NPCA) PLANT CERTIFICATION PROGRAM. EVIDENCE OF COMPLIANCE WILL BE PROVIDED FOR THE CURRENT CALENDAR YEAR THE PRODUCTS WERE MANUFACTURED WITHIN.

PARKING TABLES:

RESIDENTIAL:


| ILOID | LIVIIAL. | | | | |
|--------|-------------|------------|----------------|-------|-------|
| BLDG # | USE | SIZE | SPACES FORMULA | REQ'D | PROP. |
| 1 | RESIDENTIAL | 55 UNITS | | 110 | |
| 2 | RESIDENTIAL | 55 UNITS | 2 PER UNIT | 110 | 287 |
| 3 | RESIDENTIAL | 55 UNITS | | 110 | 28/ |
| 4 | CLUBHOUSE | 5,000 S.F. | NONE | NONE | |

NON-RESIDENTIAL. WEST OF CIRCLE:

| BLDG # | USE | SIZE | SPACES FORMULA | REQ'D | PROP. |
|--------|----------------------|-------------|------------------|-------|-------|
| 5 (1) | RETAIL/ENTERTAINMENT | 34,000 S.F. | | 102 | |
| 5 (2) | RETAIL/ENTERTAINMENT | 13,490 S.F. | | 40.5 | - |
| 6 | RETAIL/OFFICE | 5,000 S.F. | 3 PER 1,000 S.F. | 15 | 345 |
| 7 | RETAIL/OFFICE | 7,000 S.F. | 3 FER 1,000 3.F. | 21 | 343 |
| 8 | RETAIL/RESTAURANT | 9,500 S.F. | | 28.5 | |
| 9 | RESTAURANT | 3,000 S.F. | | 9 | |

NON-RESIDENTIAL, STAND ALONE:

| BLDG # | USE | SIZE | SPACES FORMULA | REQ'D | PROP. |
|--------|------------|------------|------------------|-------|-------|
| 10 | RESTAURANT | 2,805 S.F. | | 8.4 | |
| 11 | RESTAURANT | 2,340 S.F. | 3 PER 1,000 S.F. | 7 | 156 |
| 12 | RESTAURANT | 5,000 S.F. | 1 | 15 | 1 |

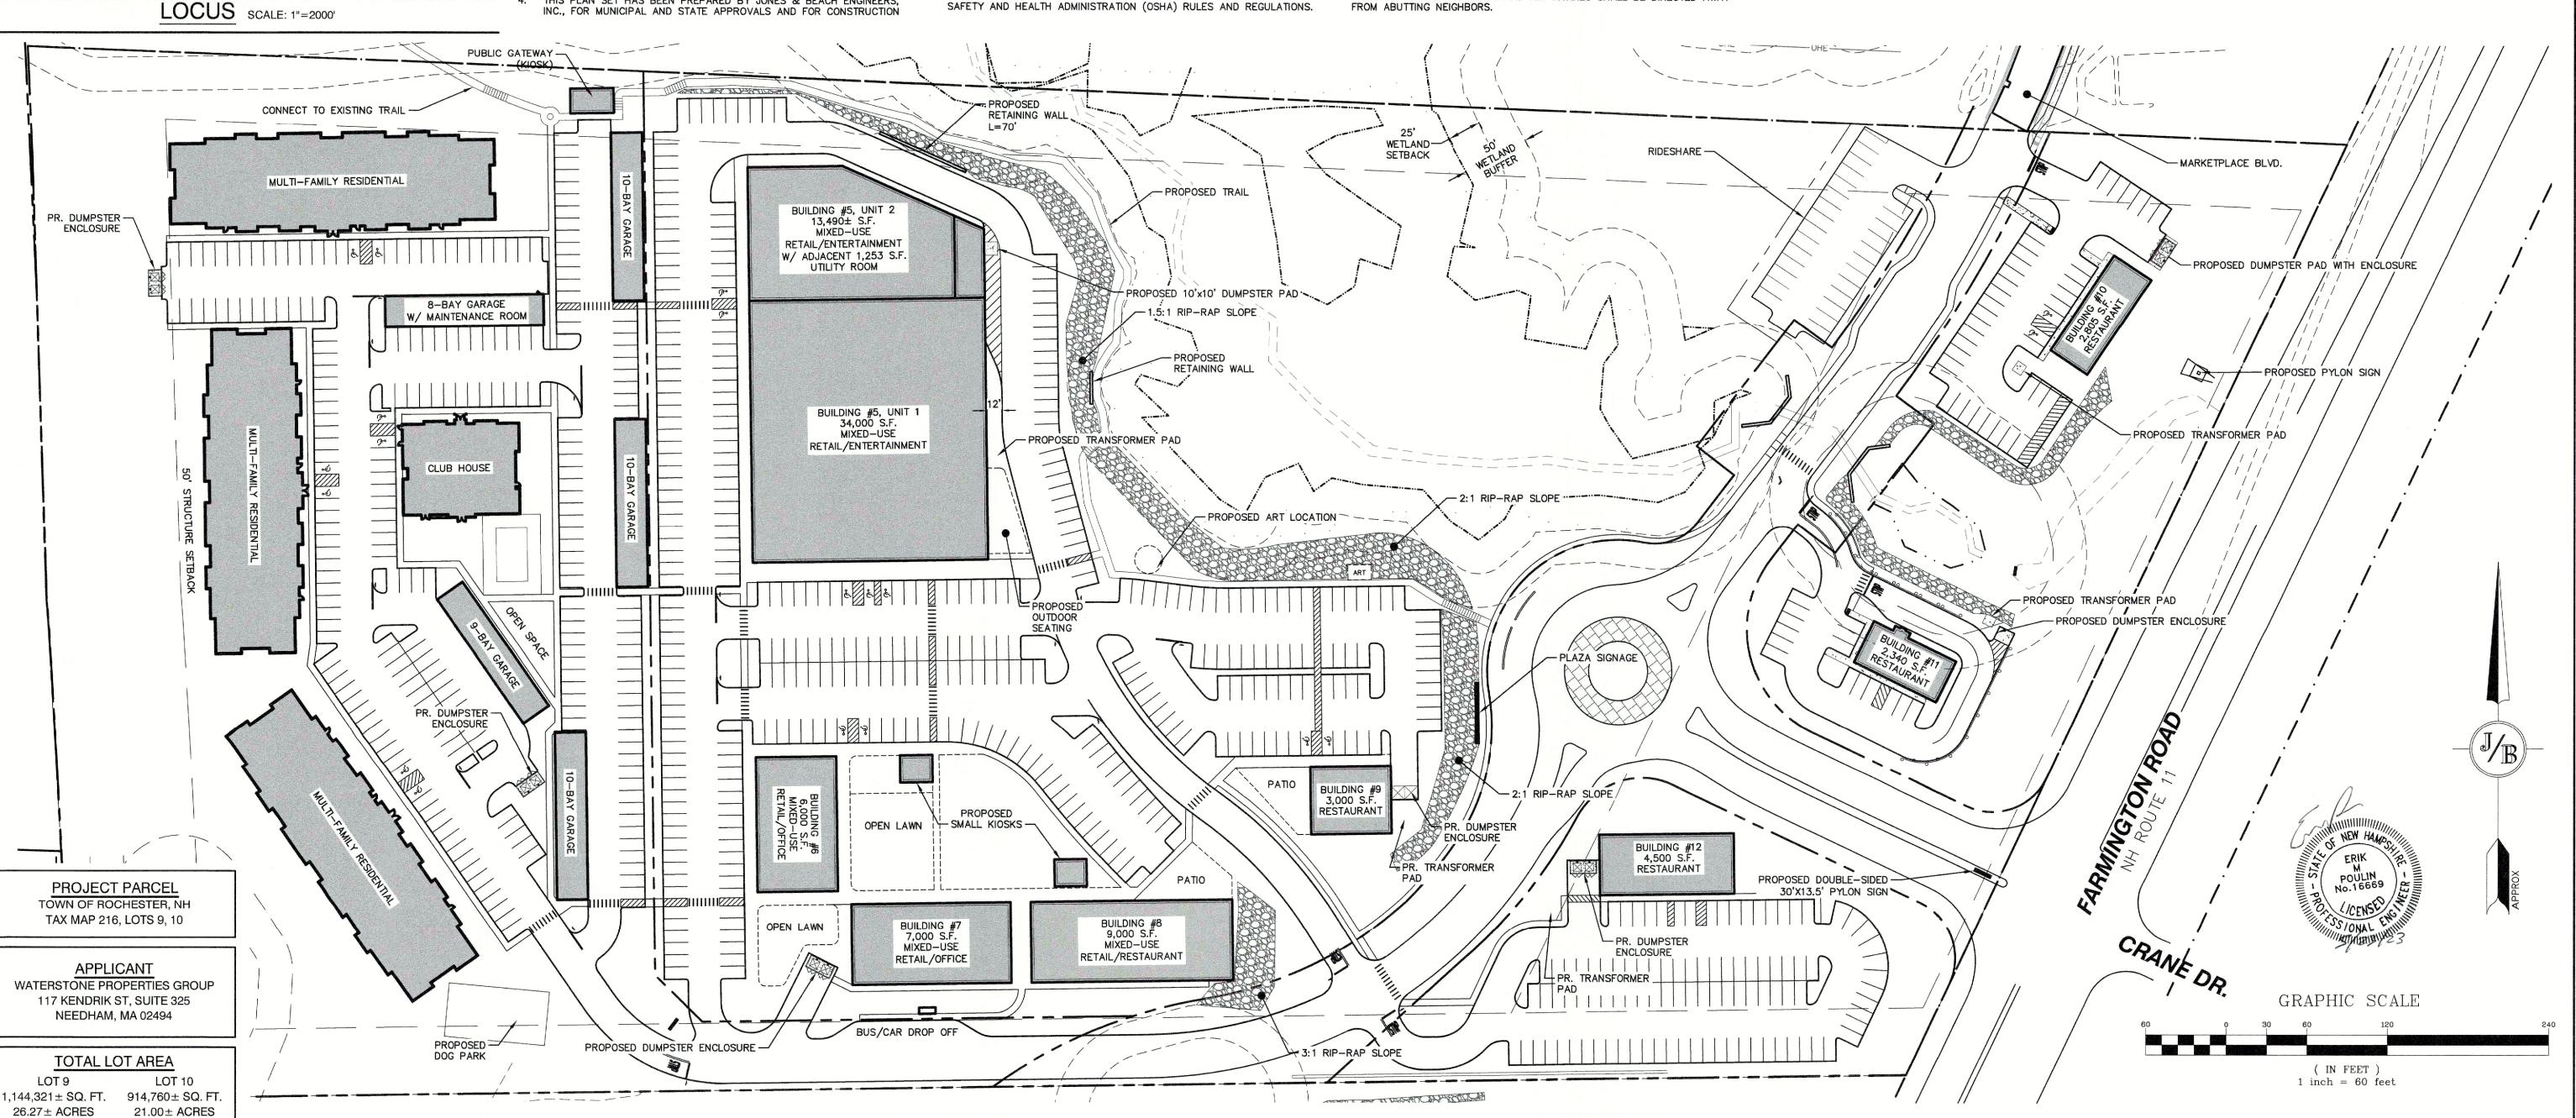

85 Portsmouth Ave.

PO Box 219, Stratham, NH 03885

Design: EMP Draft: EJH Date: 05/23/2023 Checked: EMP | Scale: AS SHOWN | Project No.: 21173 Drawing Name: 21173.1-PHASE2-PLAN.DWG THIS PLAN SHALL NOT BE MODIFIED WITHOUT WRITTEN PERMISSION FROM JONES & BEACH ENGINEERS, INC. (JBE). ANY ALTERATIONS, AUTHORIZED OR OTHERWISE, SHALL BE AT THE

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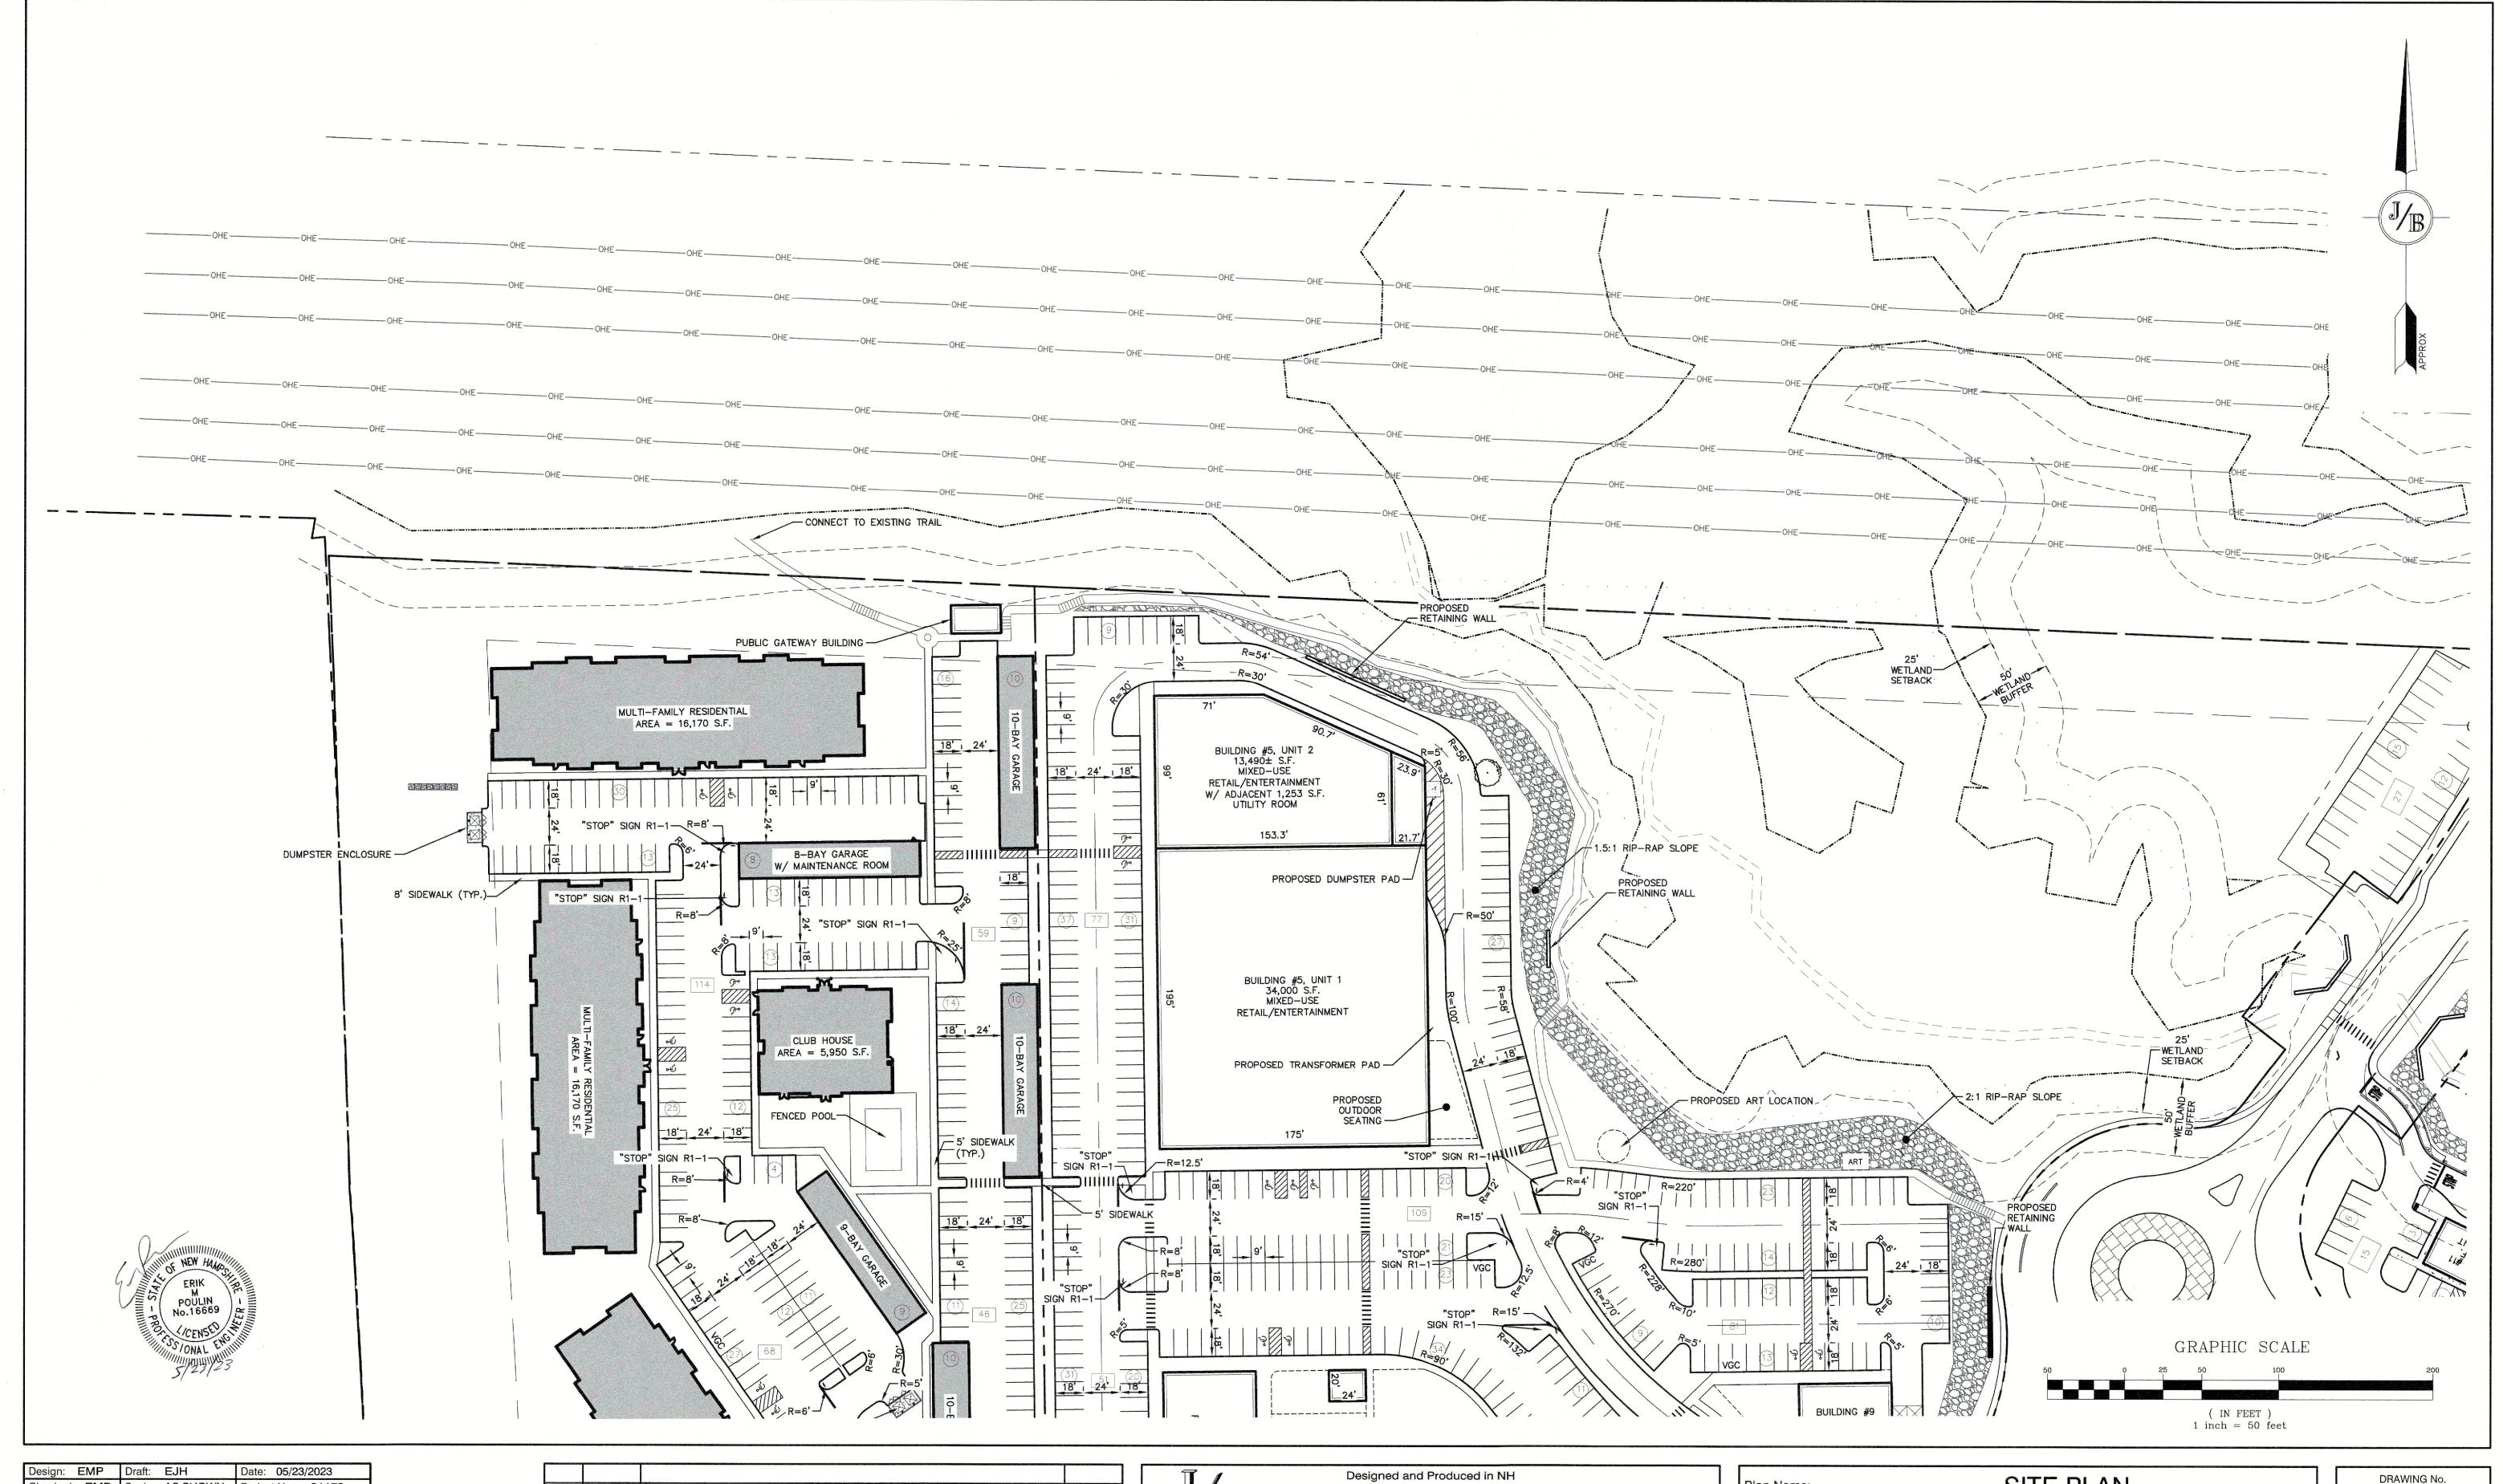
603-772-4746

E-MAIL: JBE@JONESANDBEACH.COM

OVERALL SITE PLAN Plan Name: PROPOSED PARKING LOT EXPANSION Project: MARKETPLACE BLVD, ROCHESTER, NH FARMINGTON ASSOCIATES PROPERTIES, LLC Owner of 322 RESERVOIR ST, NEEDHAM, MA 02494 Record:

DRAWING No. SHEET NO. 3 OF 21

JBE PROJECT NO. 21173



Design: EMP Draft: EJH Date: 05/23/2023

Checked: EMP Scale: AS SHOWN Project No.: 21173

Drawing Name: 21173.1-PHASE2-PLAN.DWG

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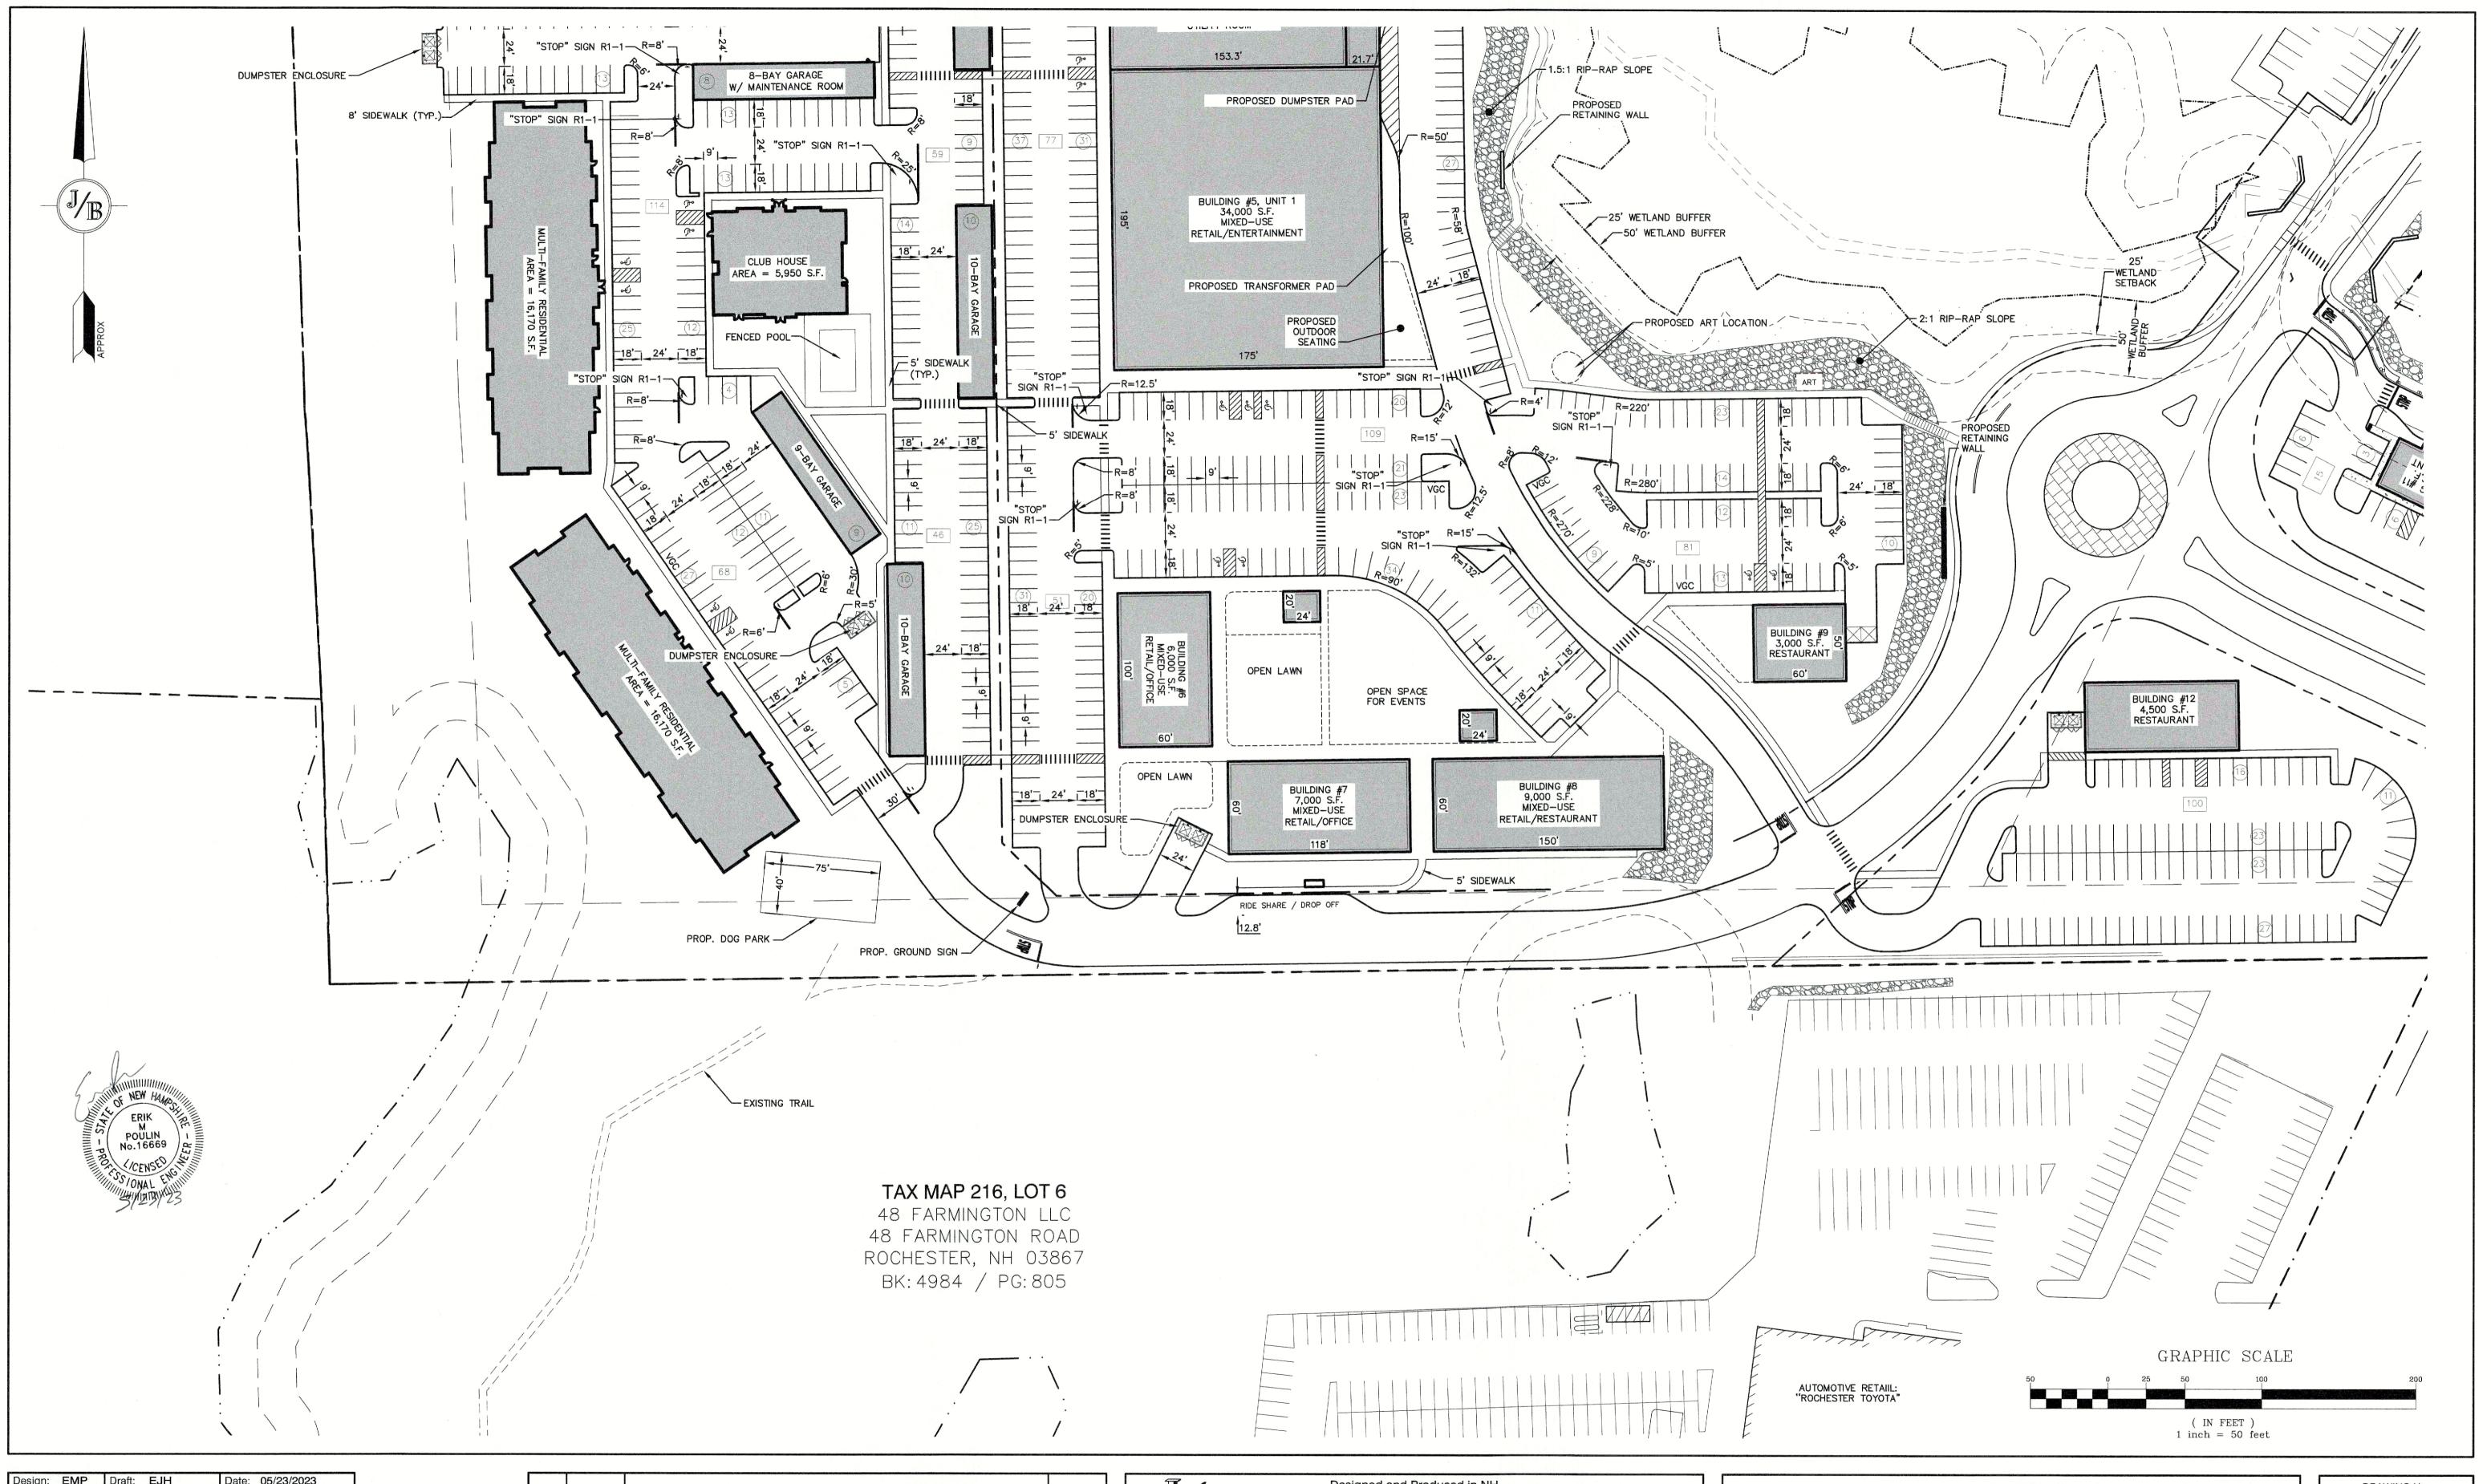
| 85 Portsmouth Ave. | Civil | Engineering | Services | 603-772-4746 |
|-----------------------|----------|-------------|-----------------|-----------------|
| PO Box 219, Stratham, | NH 03885 | | E-MAIL: JBE@JON | IESANDBEACH.COM |

| Plan Name: | SITE PLAN | |
|------------------|--|--|
| Project: | PROPOSED PARKING LOT EXPANSION MARKETPLACE BLVD, ROCHESTER, NH | |
| Owner of Record: | FARMINGTON ASSOCIATES PROPERTIES, LLC 322 RESERVOIR ST, NEEDHAM, MA 02494 | |

DRAWING No.

C2-1

SHEET NO. 4 OF 21
JBE PROJECT NO. 21173



| Design: EMP | Draft: EJH | Date: 05/23/2023 |
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| Drawing Name: | 21173.1-PHASE2-PLAI | N.DWG |
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| | THORIZED OR OTHERW | |
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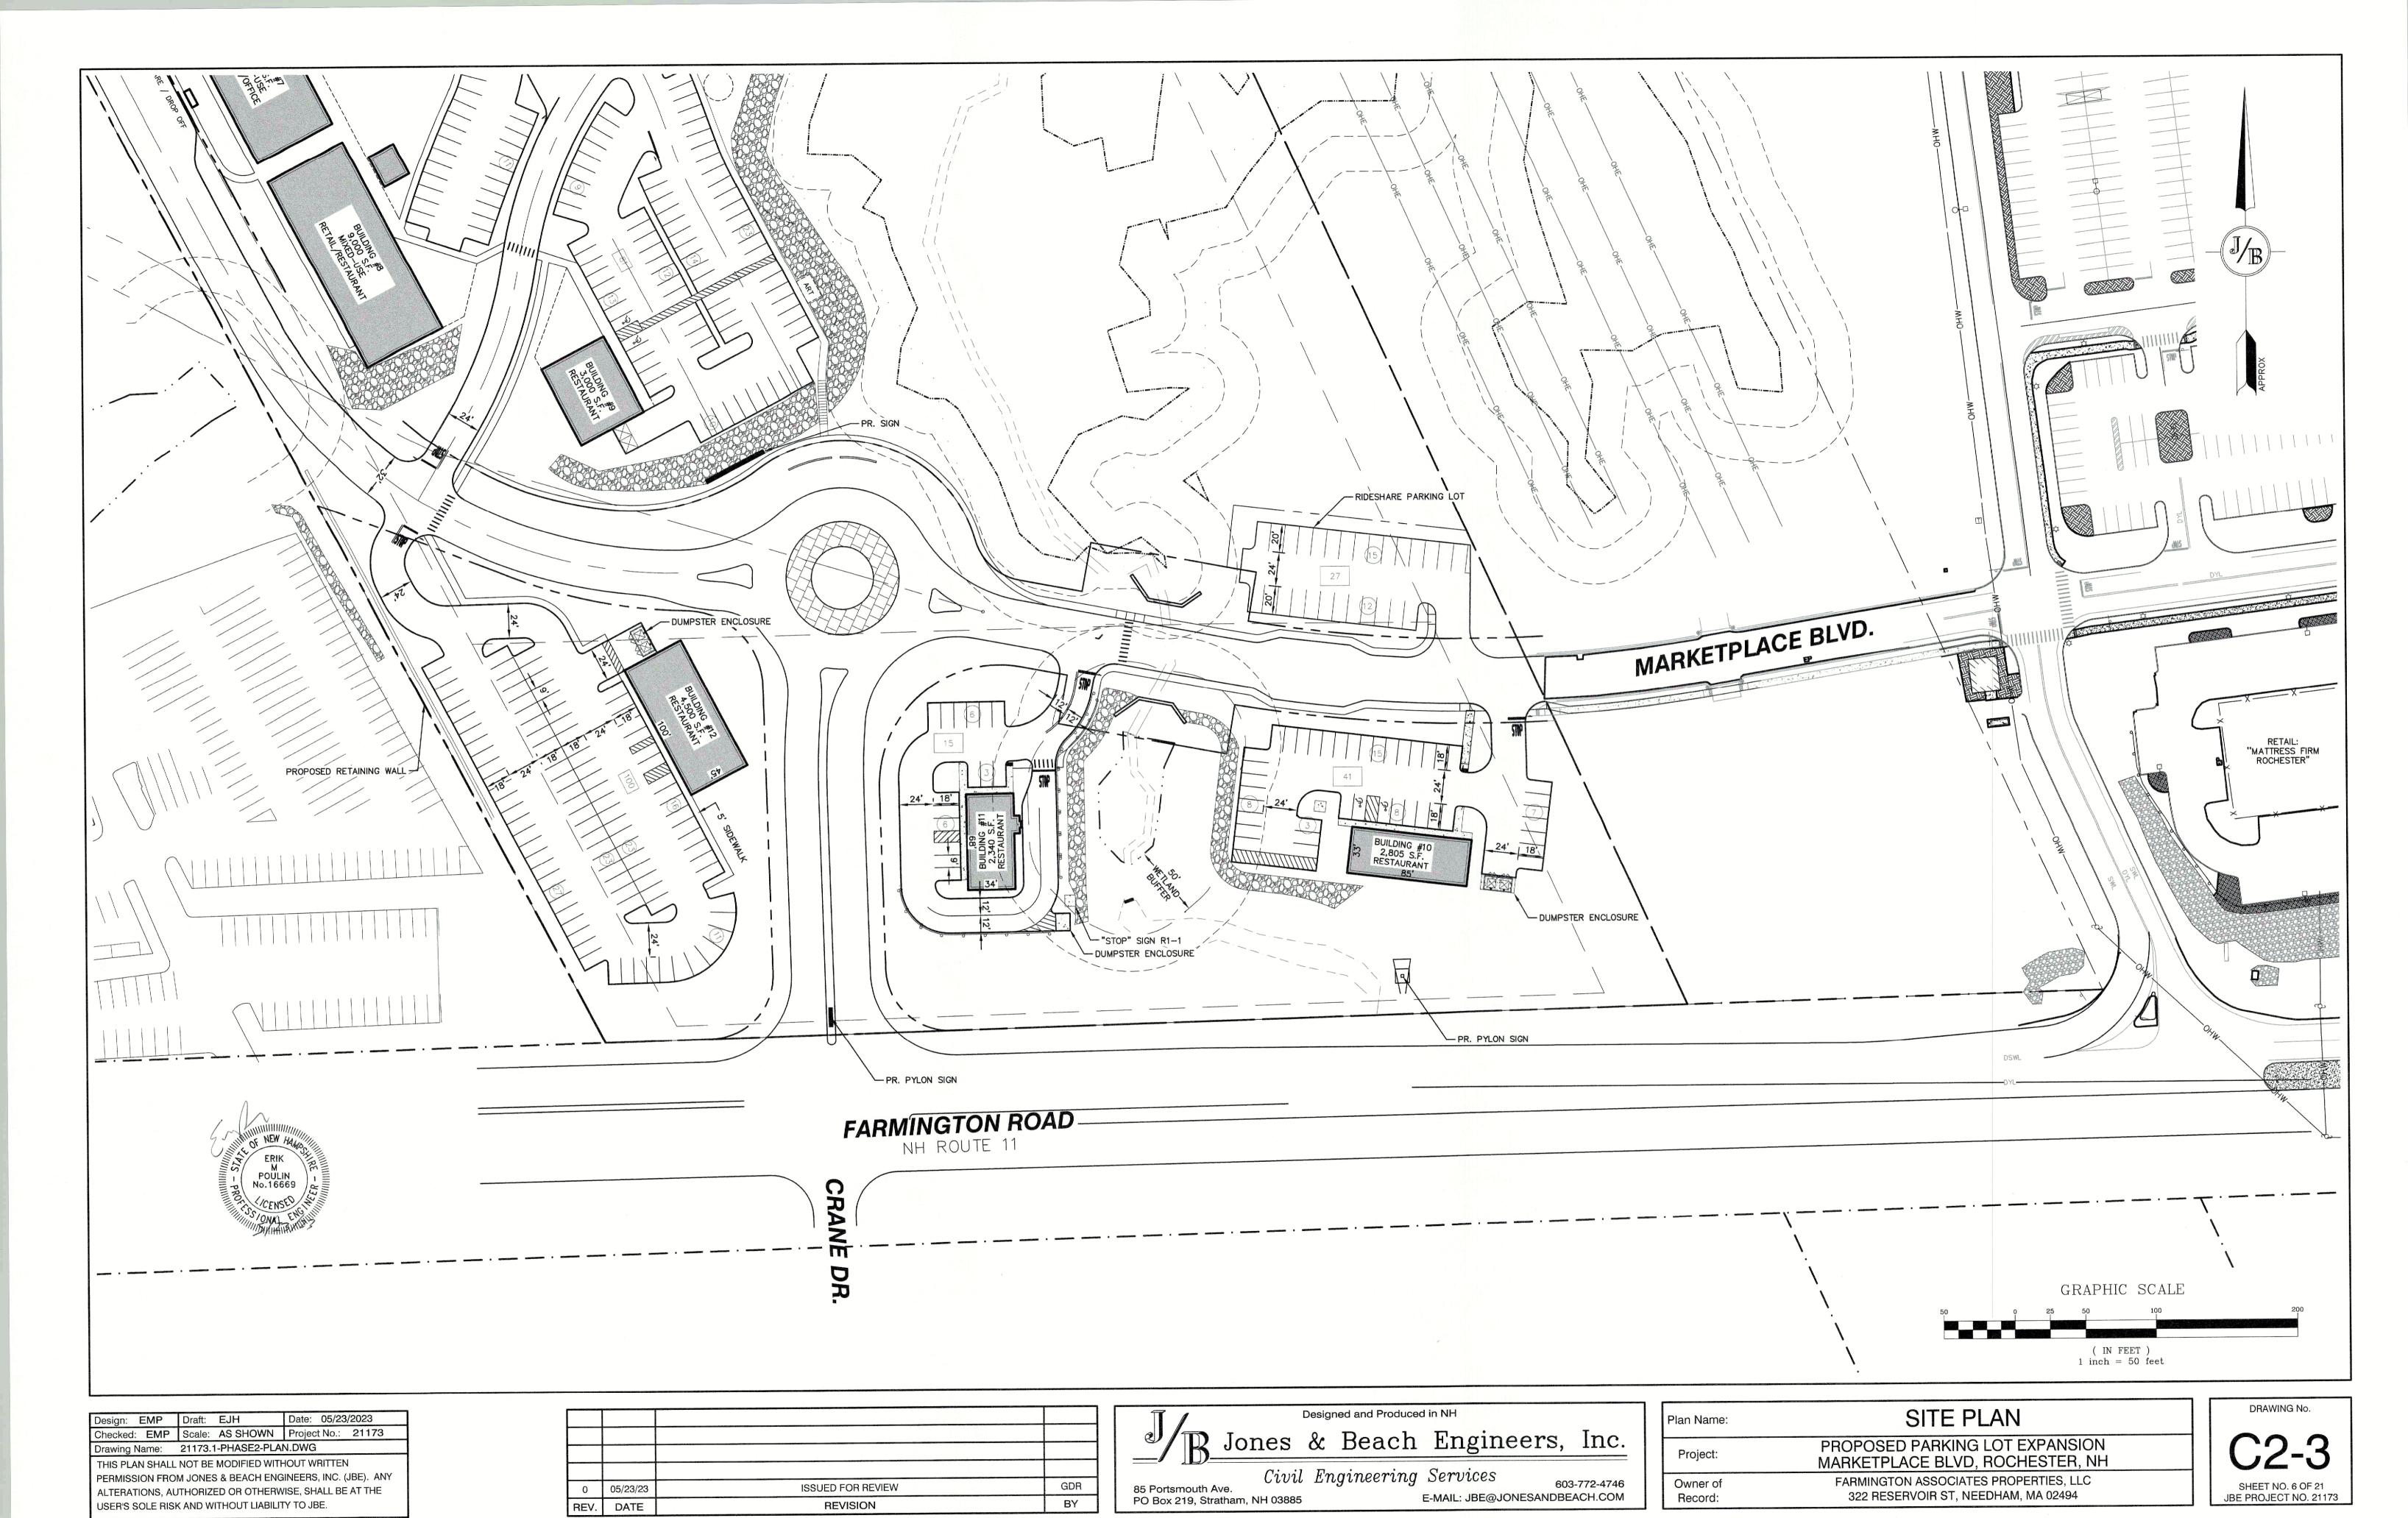
| 85 Portsmouth Ave. | Engineering | Services | 603-772-4746 |
|--------------------------------|-------------|---------------------|--------------|
| PO Box 219, Stratham, NH 03885 | | E-MAIL: JBE@JONESAN | DBEACH.COM |


| Plan Name: | SITE PLAN |
|---------------------|--|
| Project: | PROPOSED PARKING LOT EXPANSION MARKETPLACE BLVD, ROCHESTER, NH |
| Owner of Record: | FARMINGTON ASSOCIATES PROPERTIES, LLC 322 RESERVOIR ST, NEEDHAM, MA 02494 |


DRAWING No.

C2-2

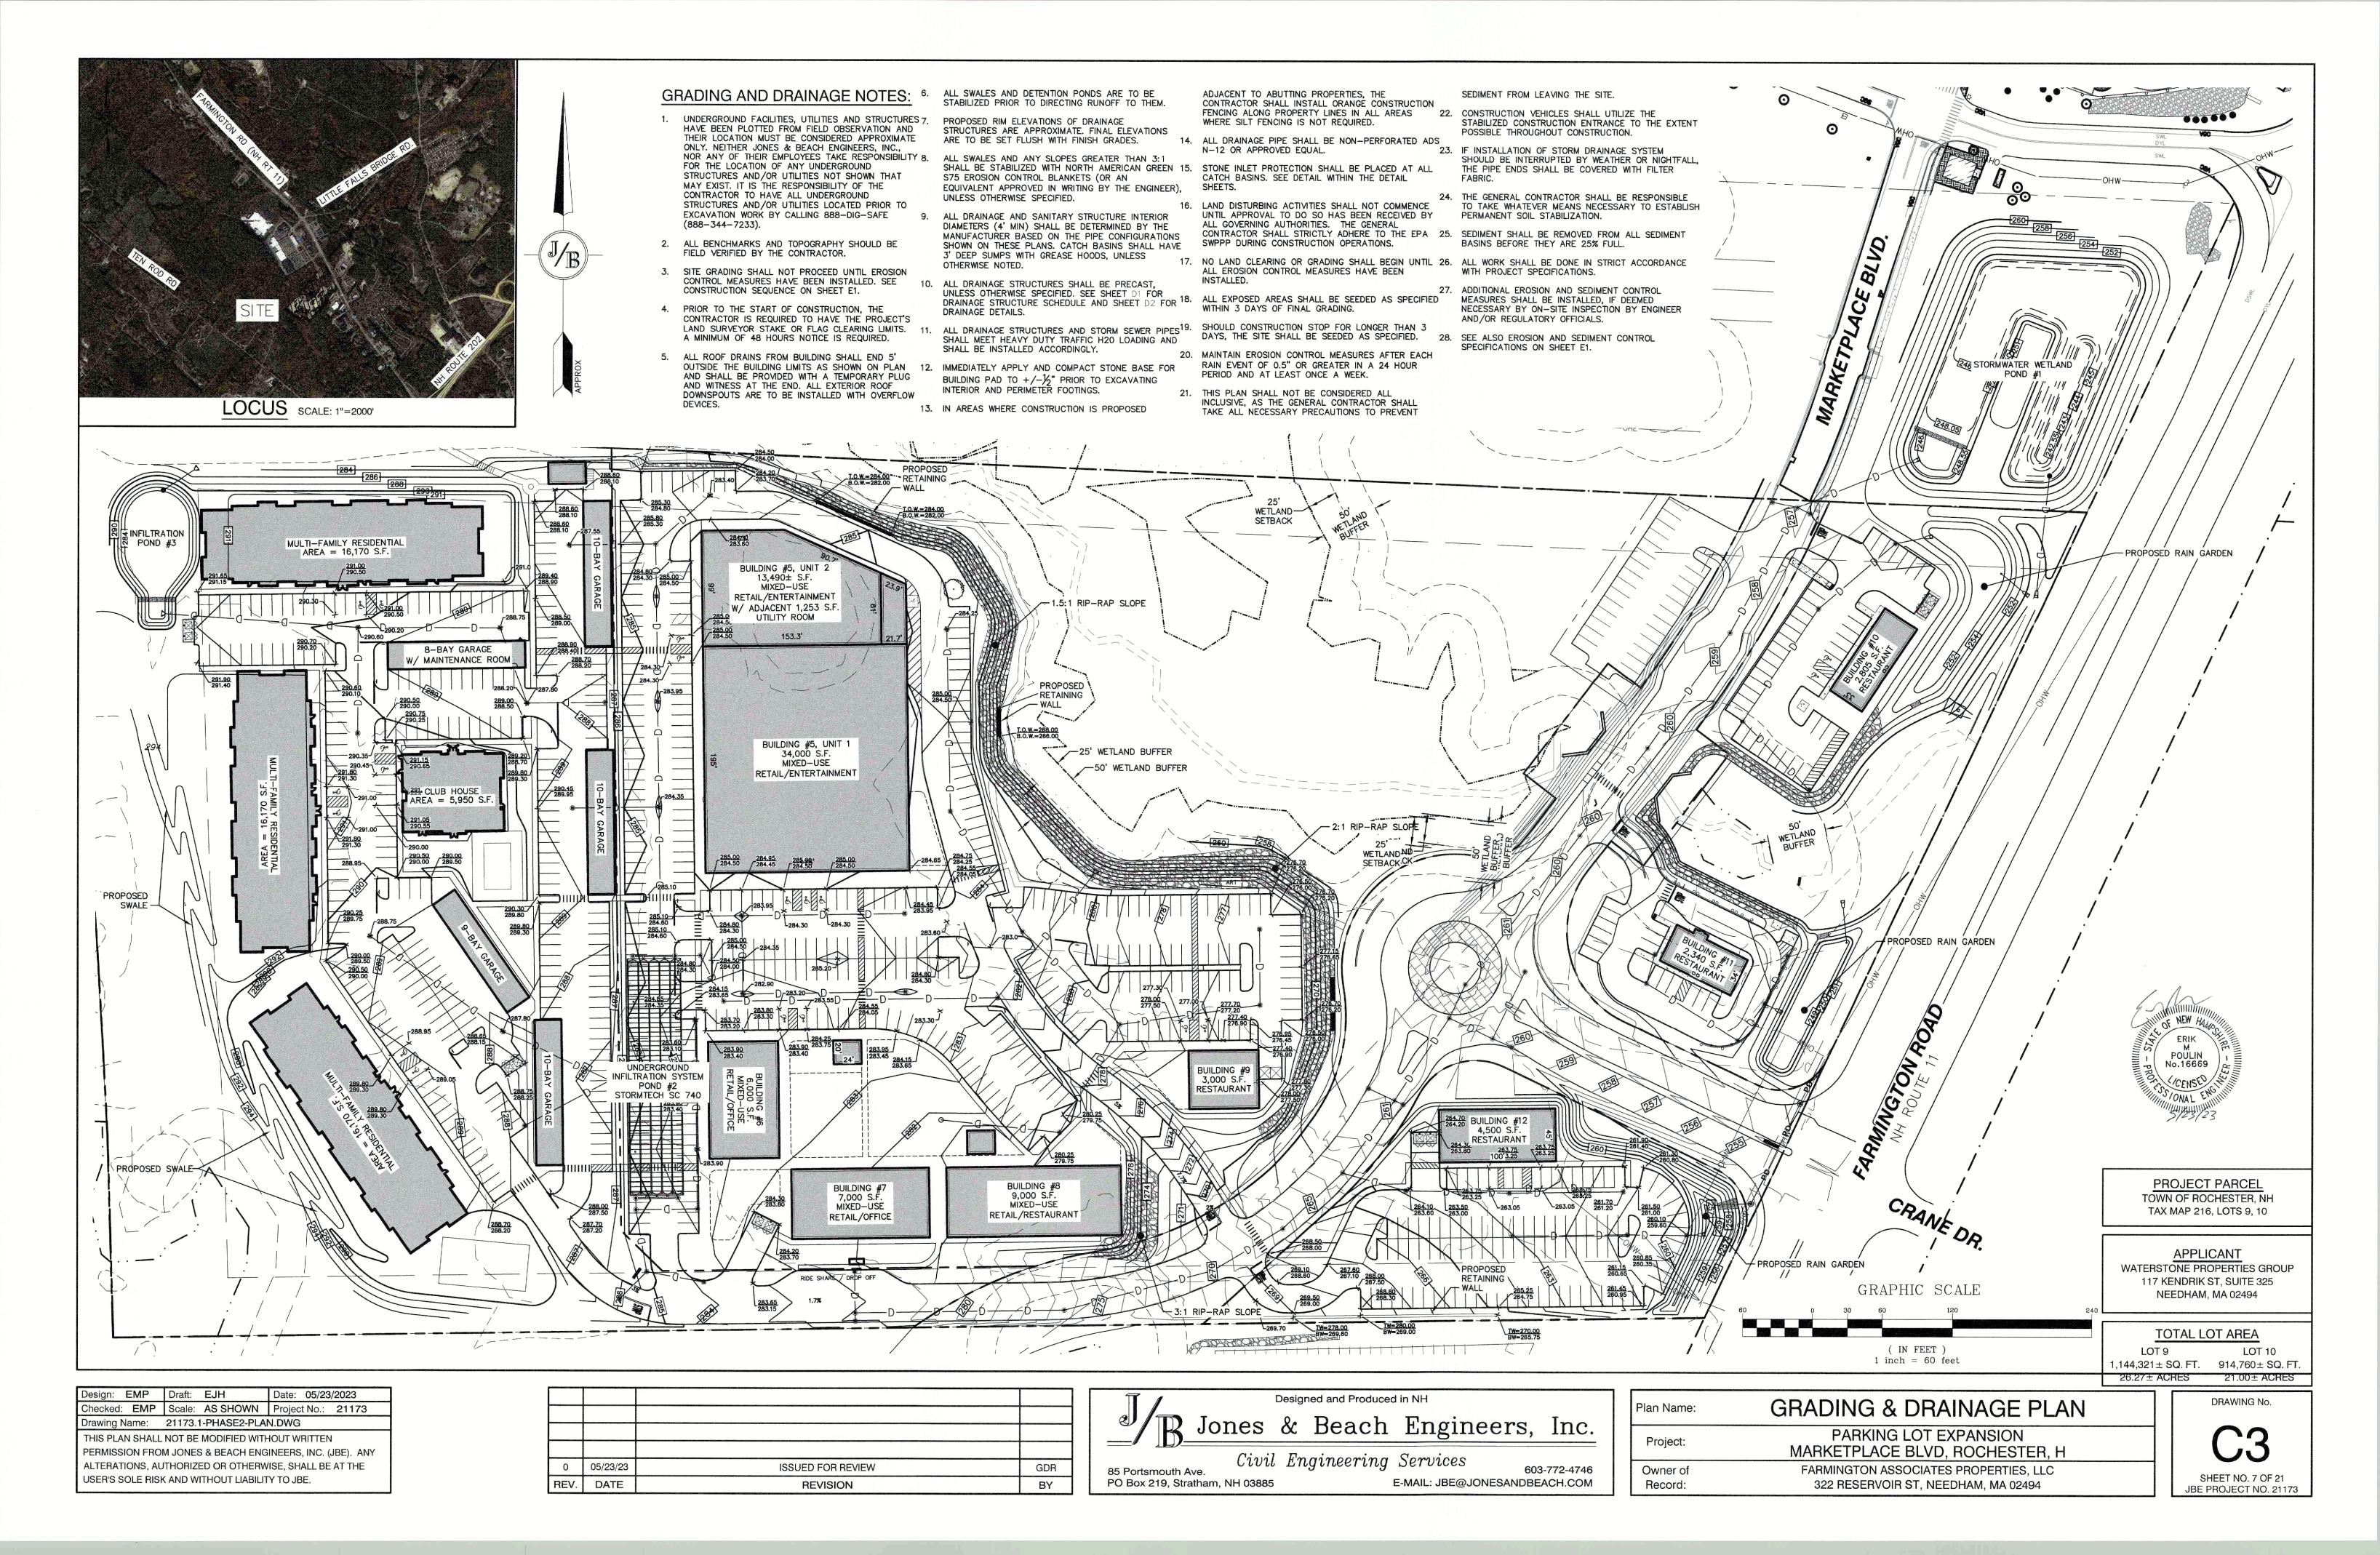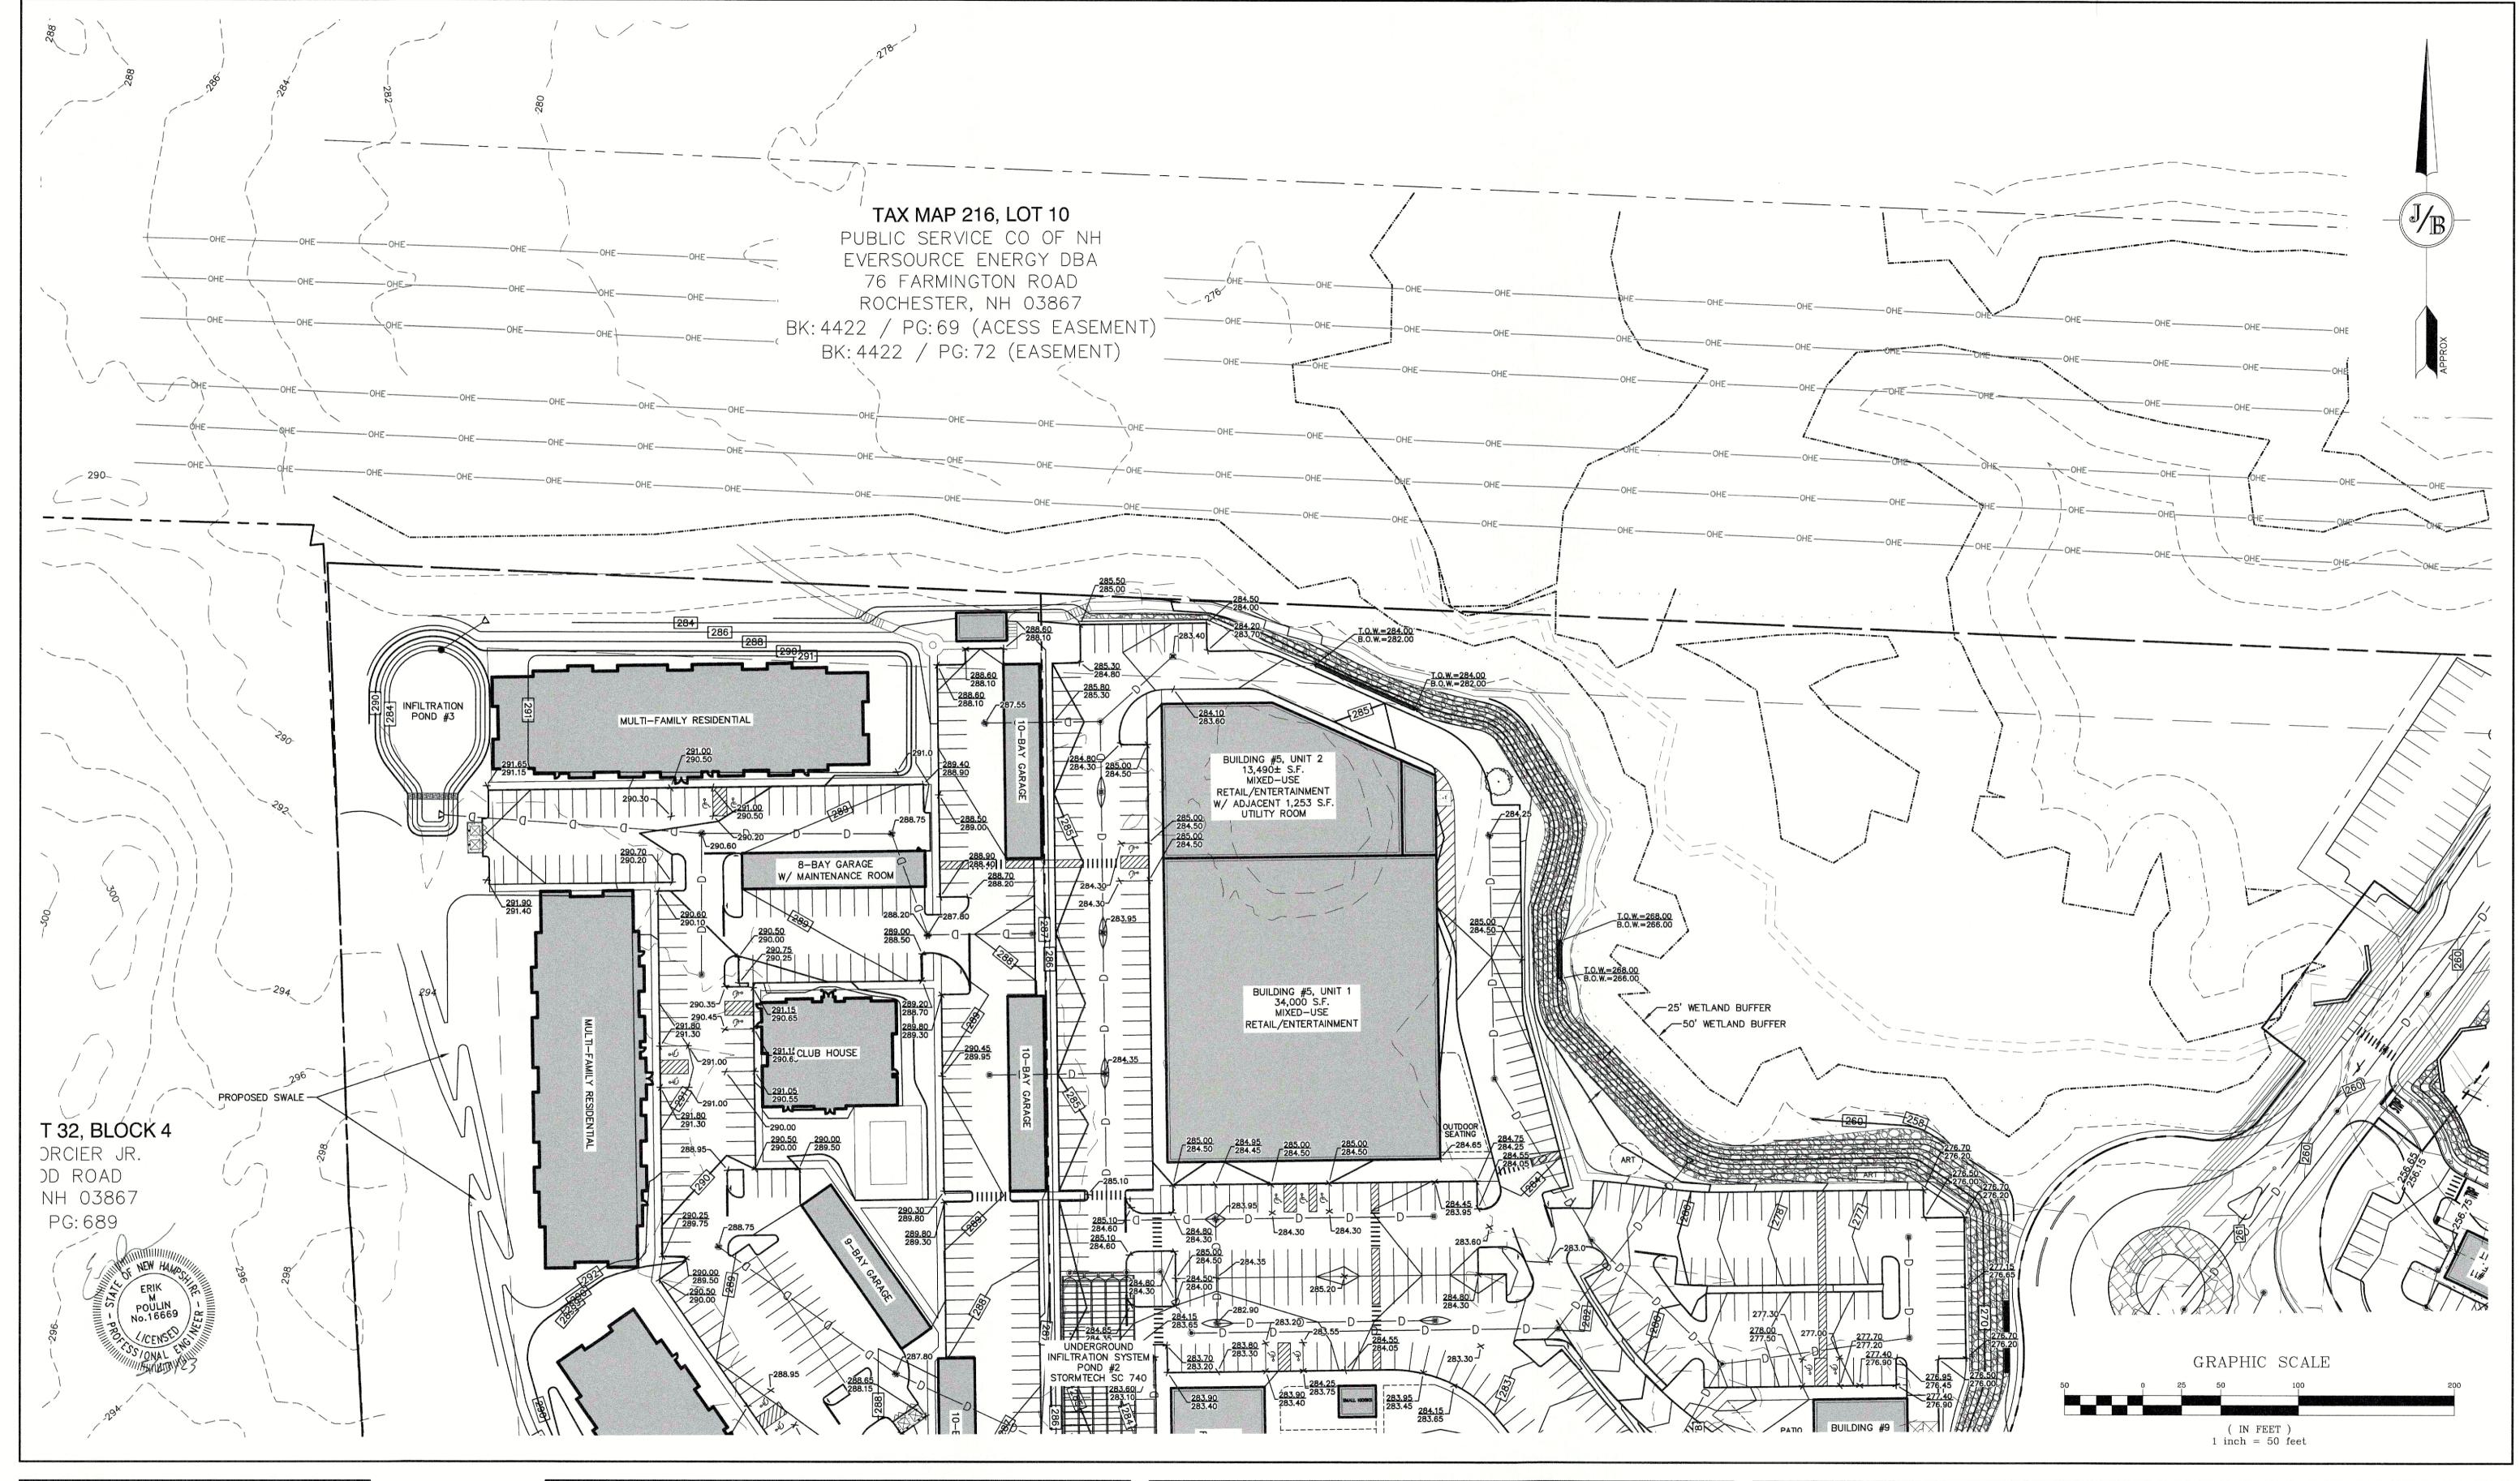SHEET NO. 5 OF 21
JBE PROJECT NO. 21173







85 Portsmouth Ave.

PO Box 219, Stratham, NH 03885

| Design: EMP | Draft: EJH | Date: 05/23/2023 | | |
|--|---------------------|-----------------------|--|--|
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| Drawing Name: | 21173.1-PHASE2-PLA | N.DWG | | |
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| ALTERATIONS, AU | THORIZED OR OTHERV | VISE, SHALL BE AT THE | | |

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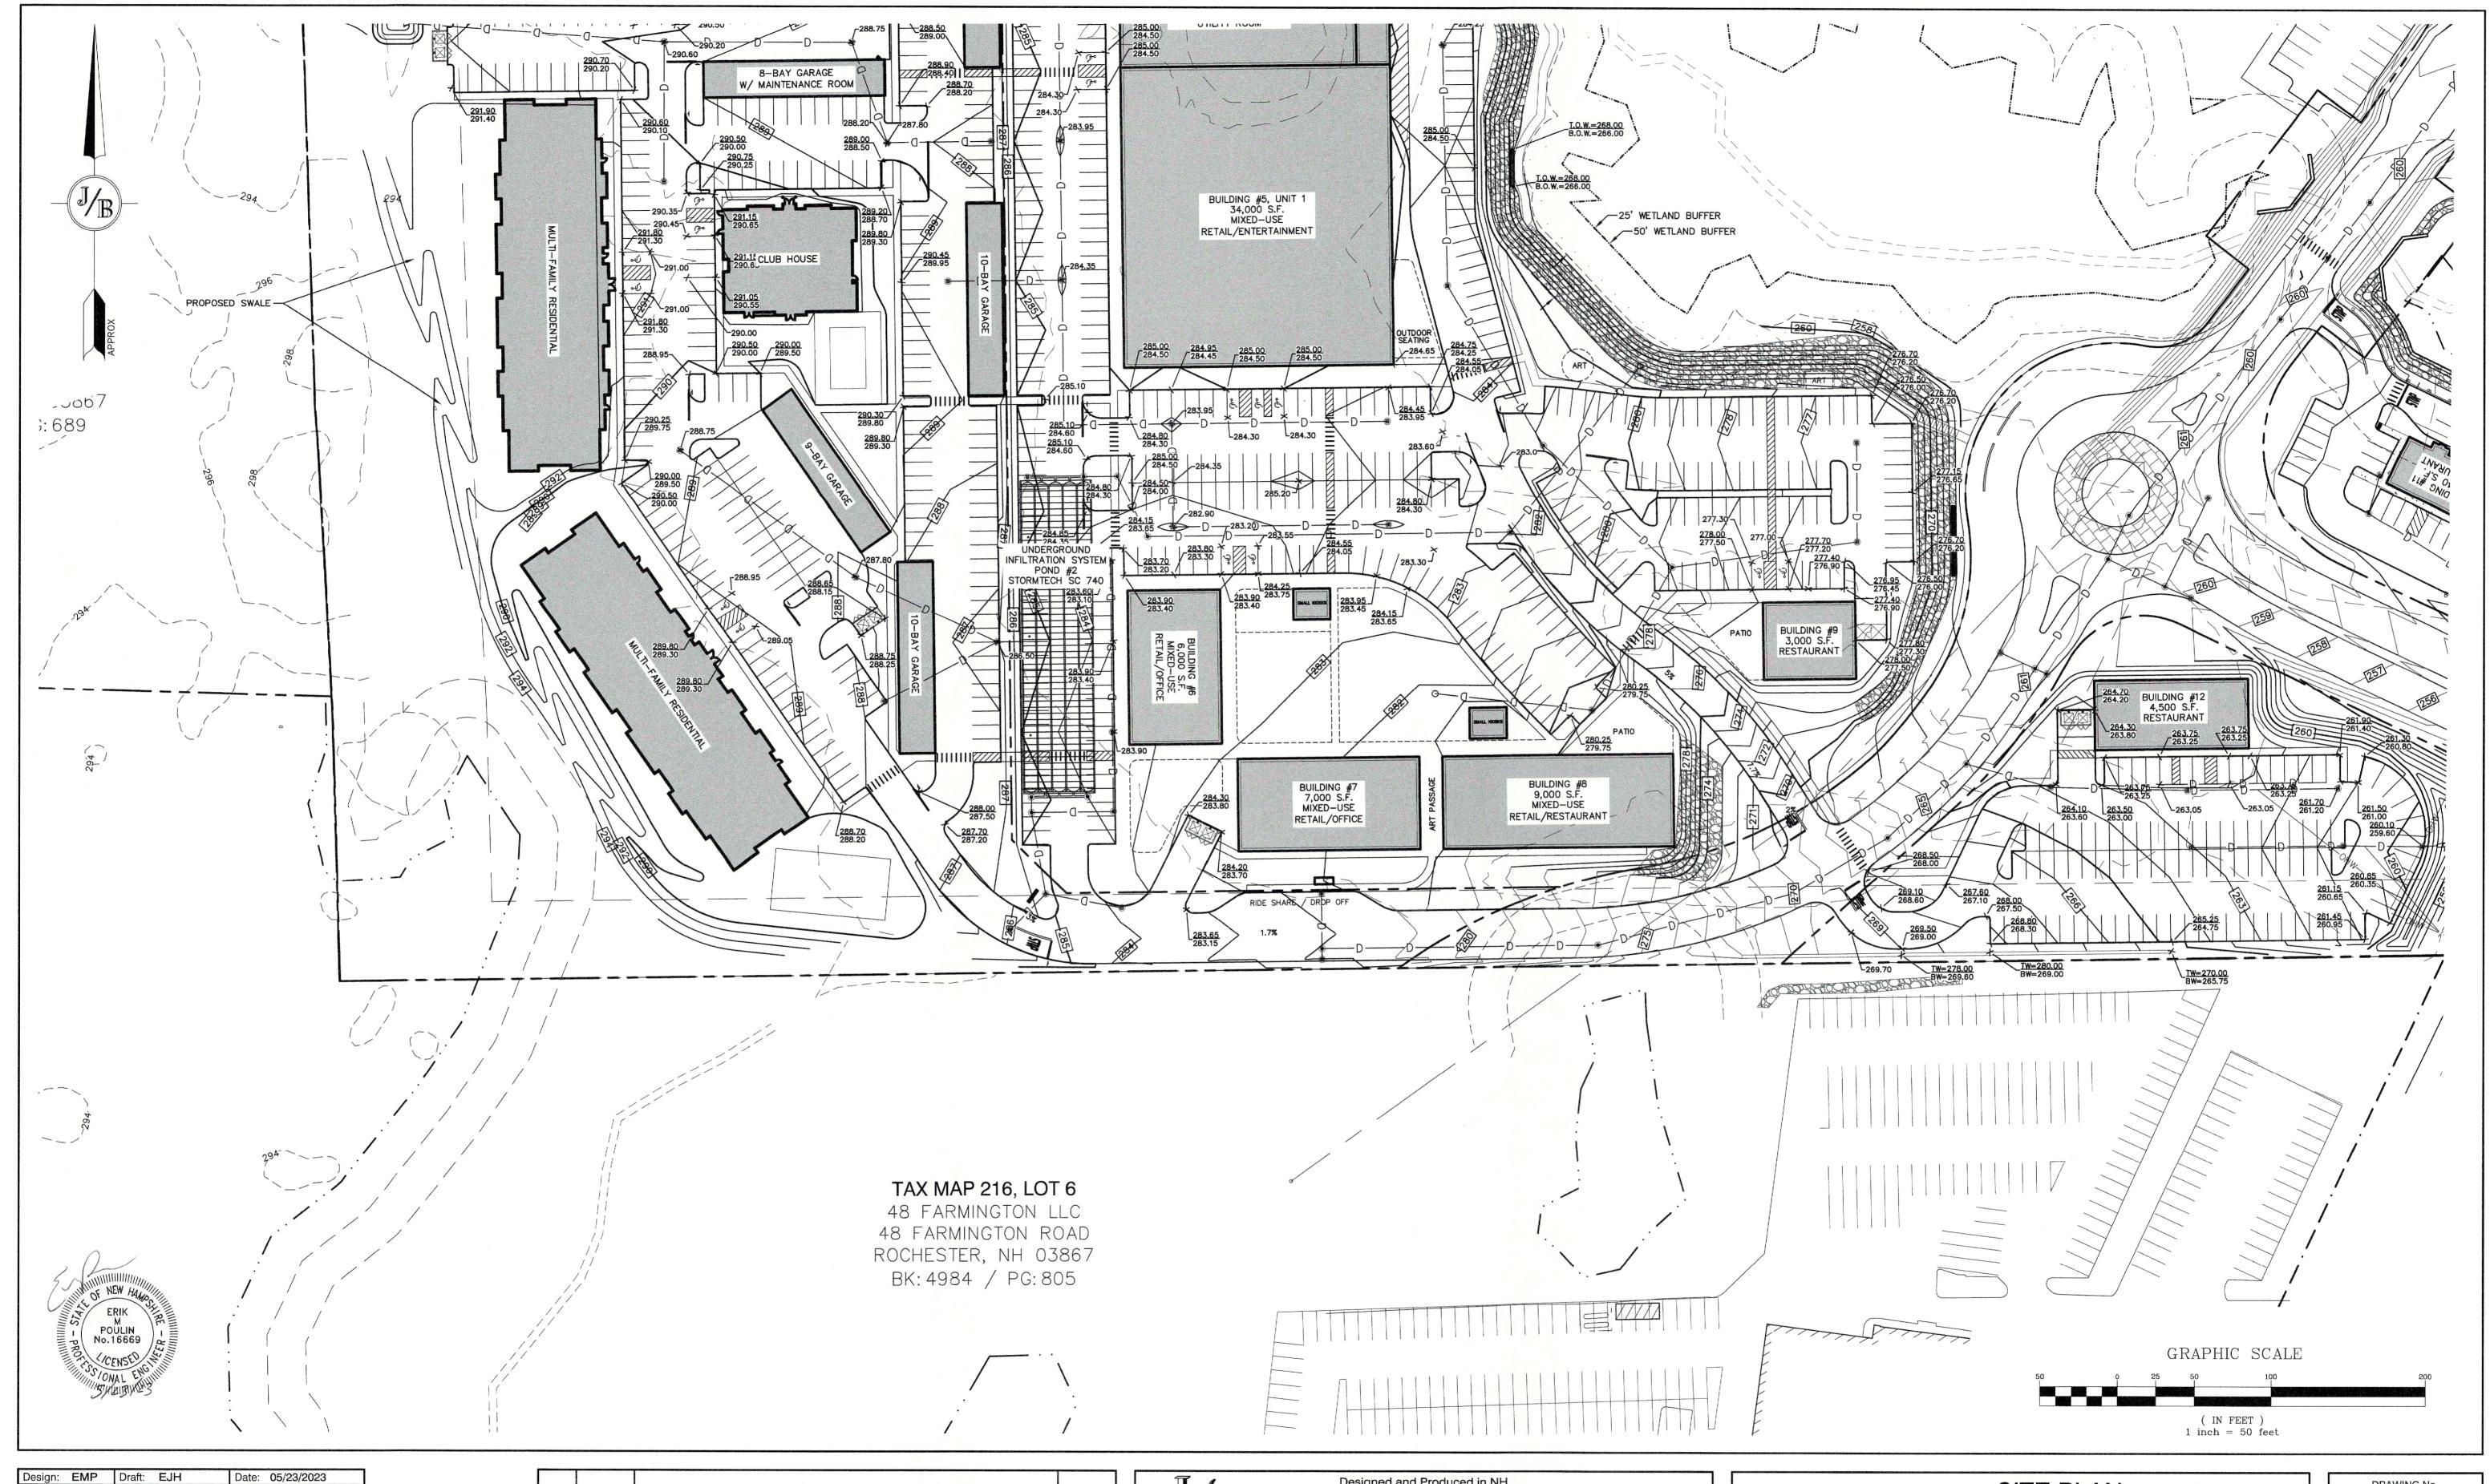
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| 1 | | Desig | ned and Produce | d in NH | ************************************** |
|------------------|-------|-------|-----------------|-----------|--|
| _ / R_ | Jones | & | Beach | Engineers | , Inc. |
| 85 Portsmouth Av | Civil | En | gineering | Services | 03-772-4746 |

E-MAIL: JBE@JONESANDBEACH.COM

| Plan Name: | SITE PLAN | |
|---------------------|--|--|
| Project: | PROPOSED PARKING LOT EXPANSION MARKETPLACE BLVD, ROCHESTER, NH | |
| Owner of Record: | FARMINGTON ASSOCIATES PROPERTIES, LLC 322 RESERVOIR ST, NEEDHAM, MA 02494 | |

DRAWING No. SHEET NO. 8 OF 21 JBE PROJECT NO. 21173



| Design: EMP | Draft: EJH | Date: 05/23/2023 | | |
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| Drawing Name: 21173.1-PHASE2-PLAN.DWG | | | | |
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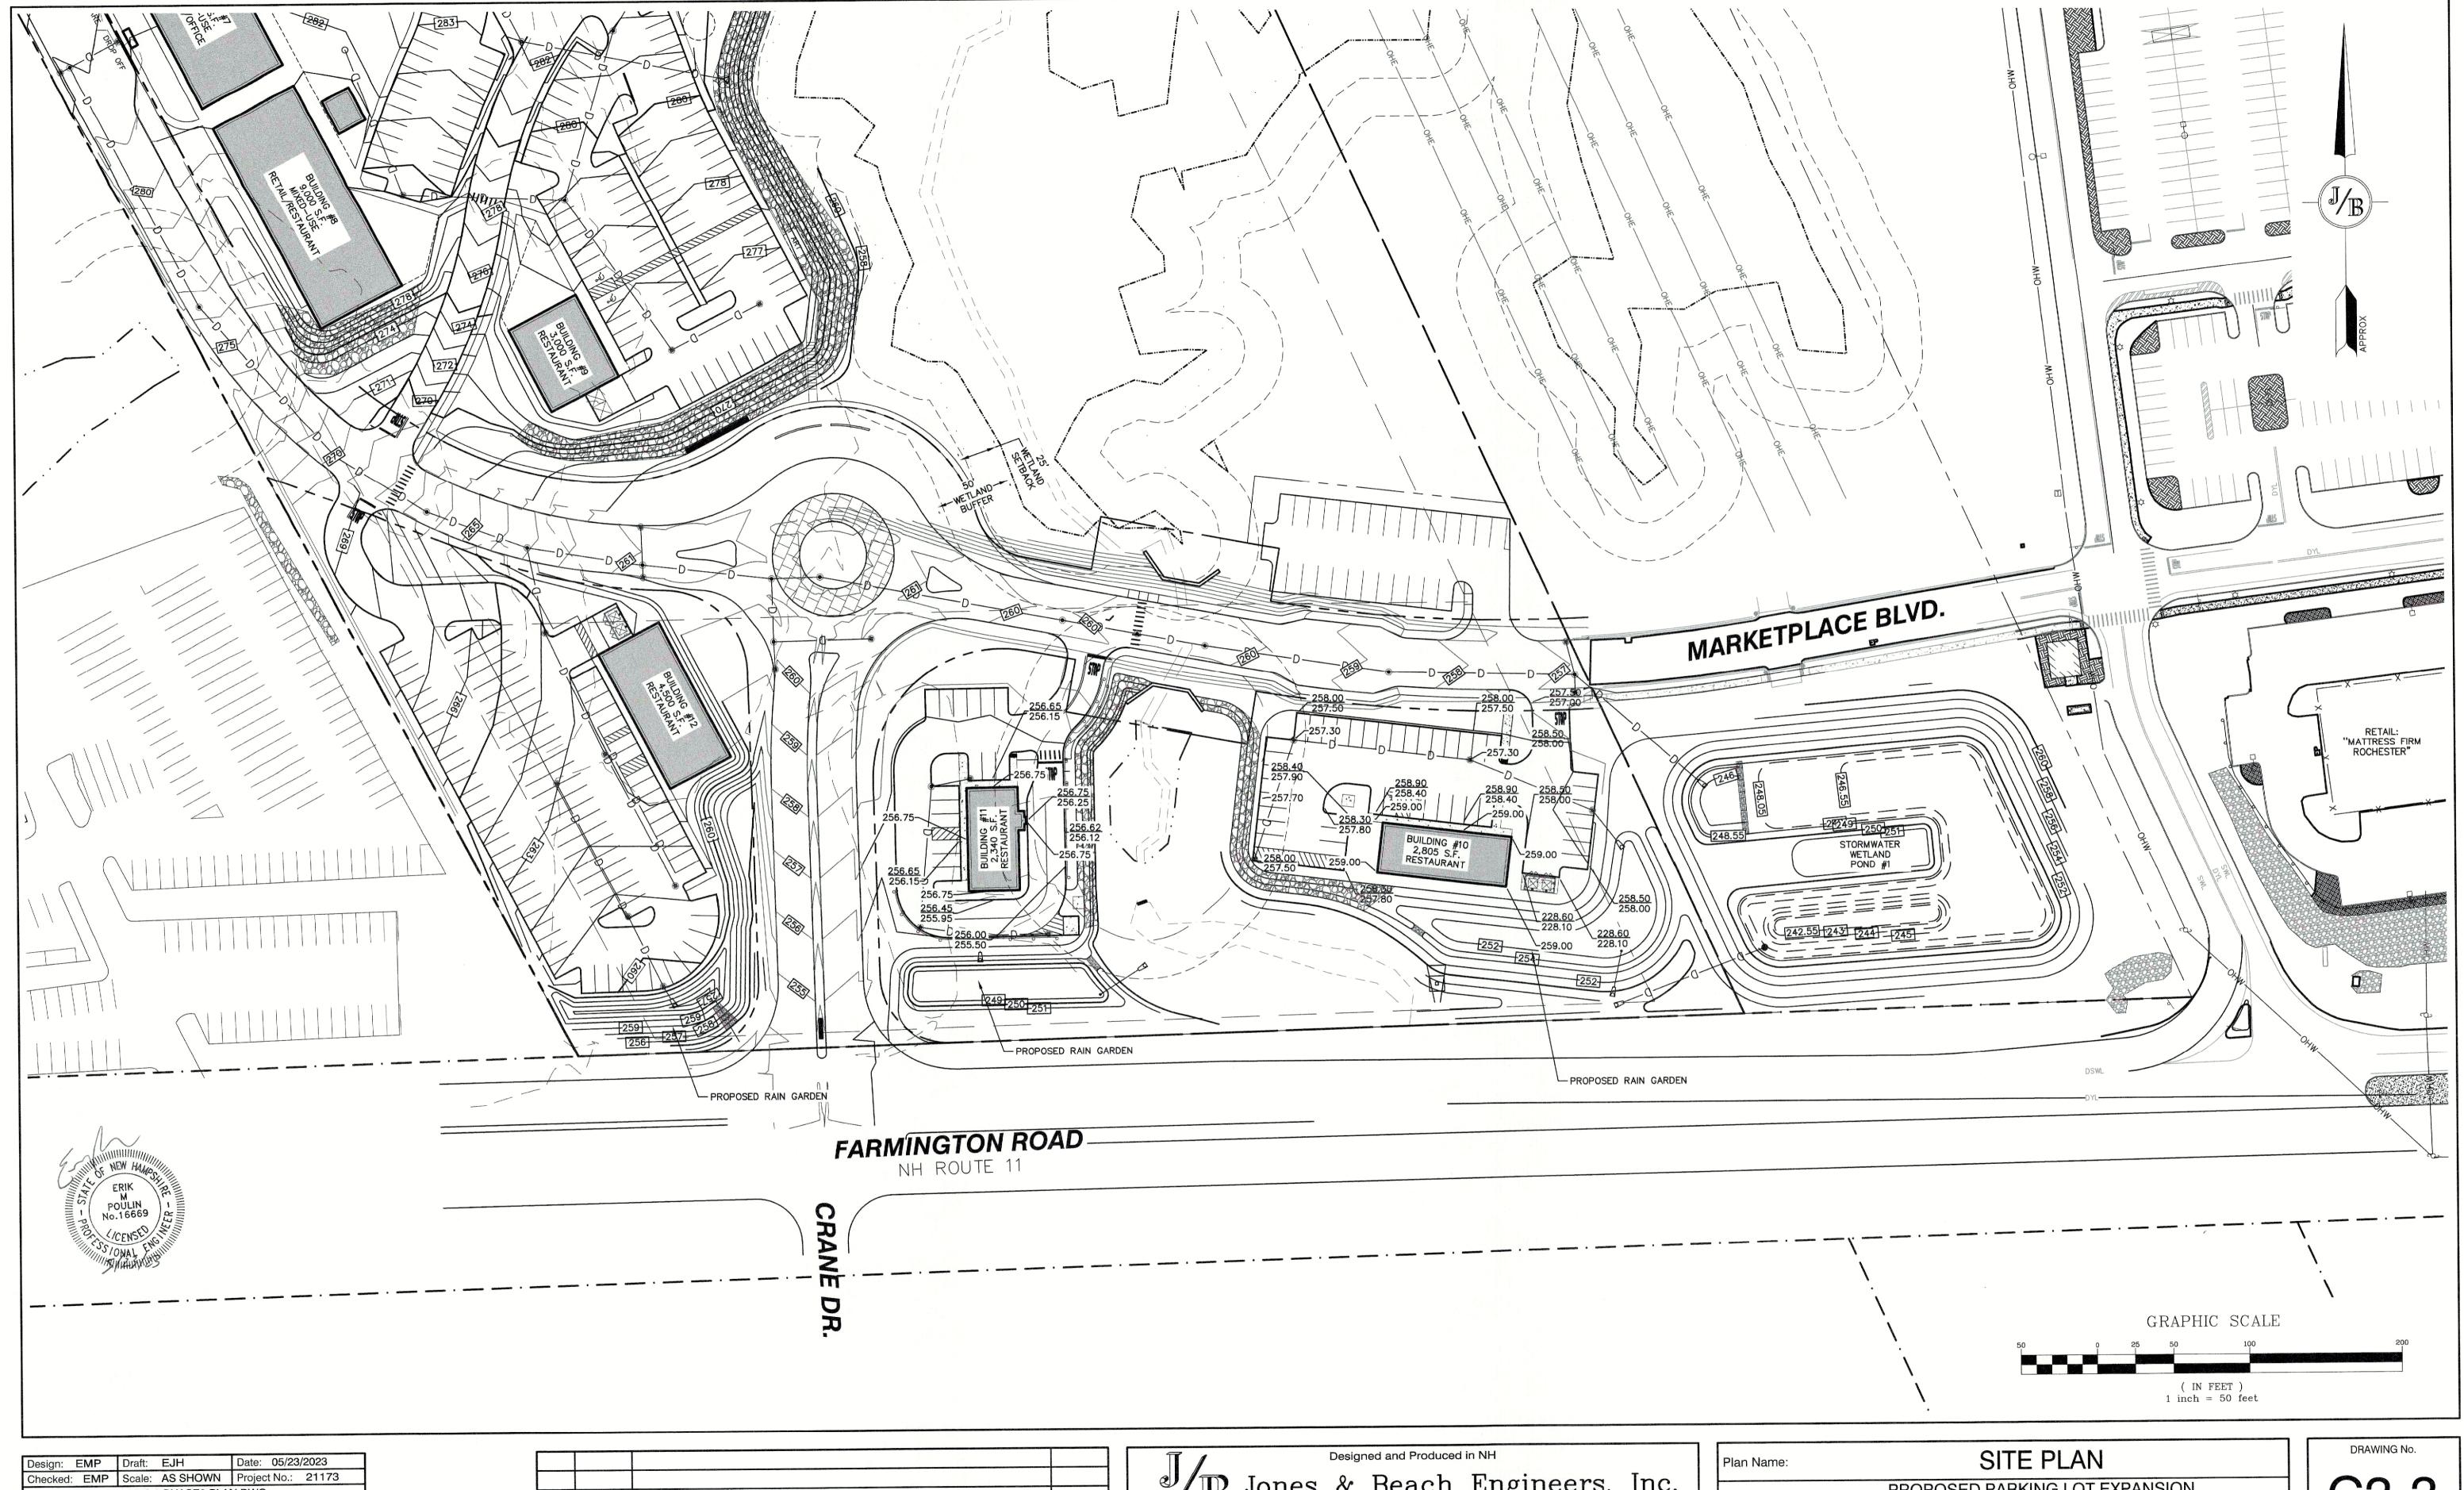
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|--------------------------|-------|---------------|-----------------|-----------------|
| 85 Portsmouth Ave. | | 2.090.000.009 | 201000 | 603-772-4746 |
| PO Box 219, Stratham, NH | 03885 | | E-MAIL: JBE@JON | NESANDBEACH.COM |

| Plan Name: | SITE PLAN |
|---------------------|--|
| Project: | PROPOSED PARKING LOT EXPANSION MARKETPLACE BLVD, ROCHESTER, NH |
| Owner of Record: | FARMINGTON ASSOCIATES PROPERTIES, LLC 322 RESERVOIR ST, NEEDHAM, MA 02494 |

DRAWING No.

C3-2

SHEET NO. 9 OF 21
JBE PROJECT NO. 21173



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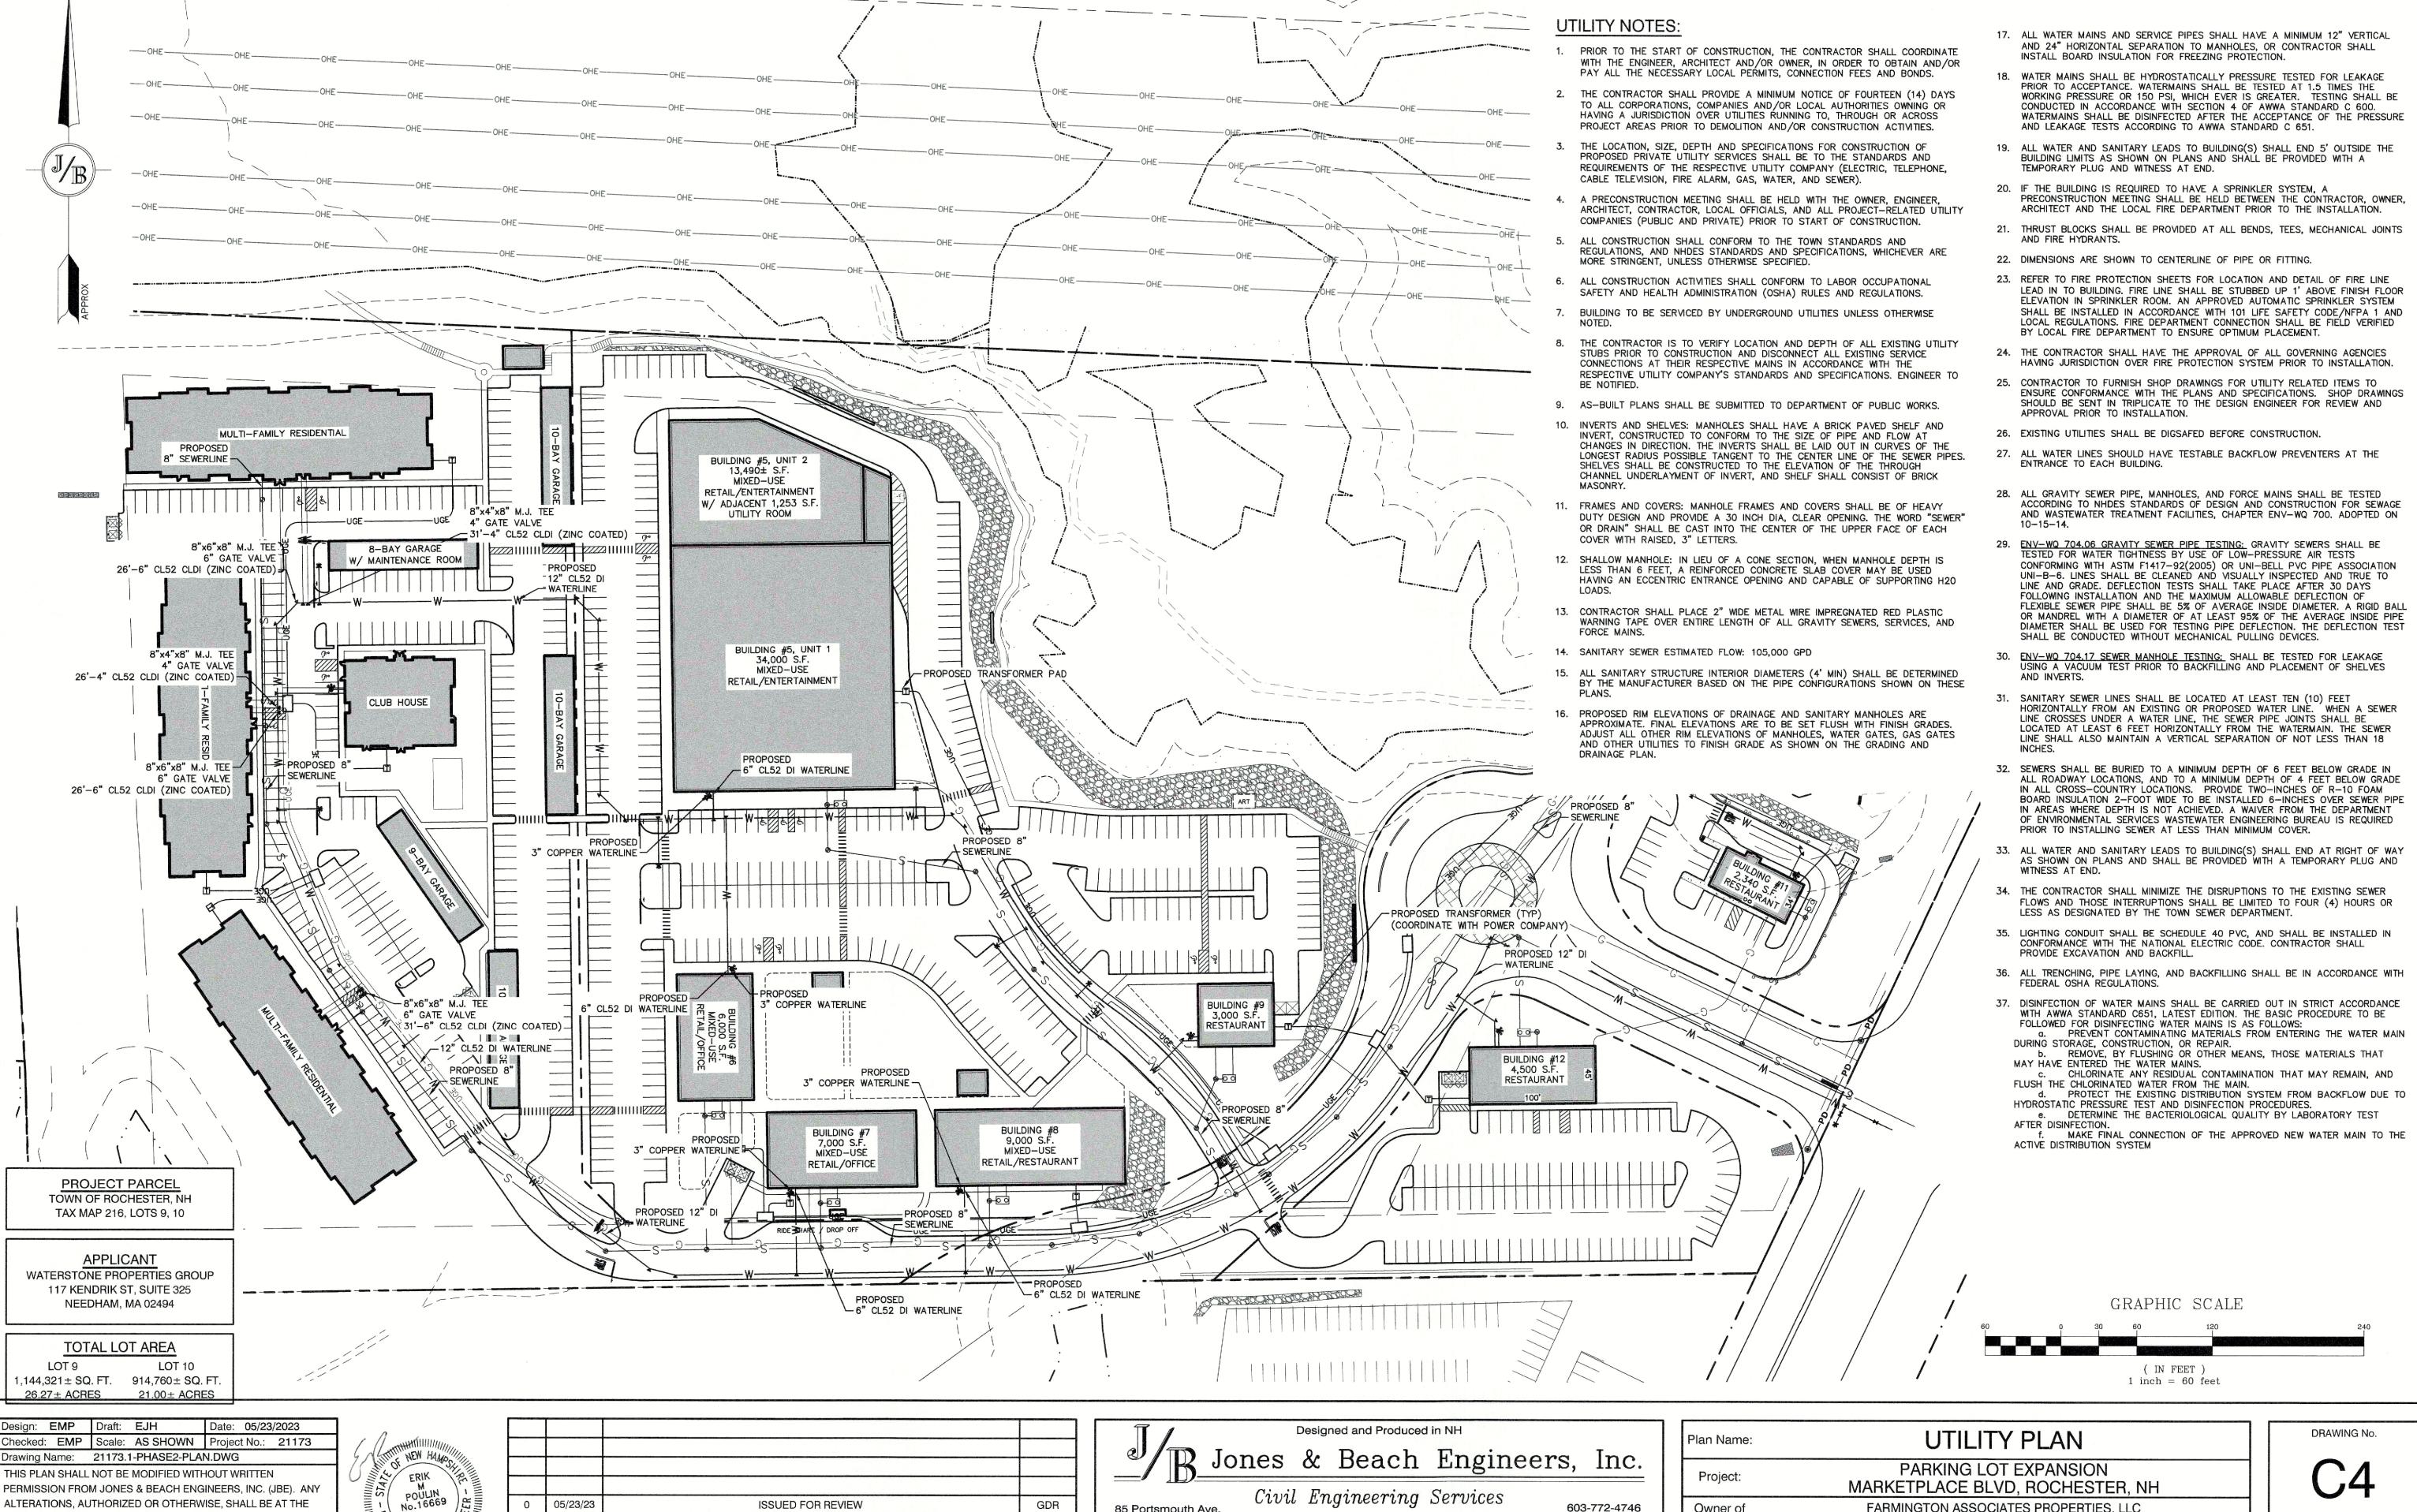
GDR ISSUED FOR REVIEW 0 05/23/23 REV. DATE **REVISION**

B Jones & Beach Engineers, Inc.

Civil Engineering Services 603-772-4746 85 Portsmouth Ave. PO Box 219, Stratham, NH 03885 E-MAIL: JBE@JONESANDBEACH.COM

| Plan Name: | SITE PLAN |
|------------------|--|
| Project: | PROPOSED PARKING LOT EXPANSION MARKETPLACE BLVD, ROCHESTER, NH |
| Owner of Record: | FARMINGTON ASSOCIATES PROPERTIES, LLC 322 RESERVOIR ST, NEEDHAM, MA 02494 |

SHEET NO. 10 OF 21 JBE PROJECT NO. 21173



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Owner of

Record:

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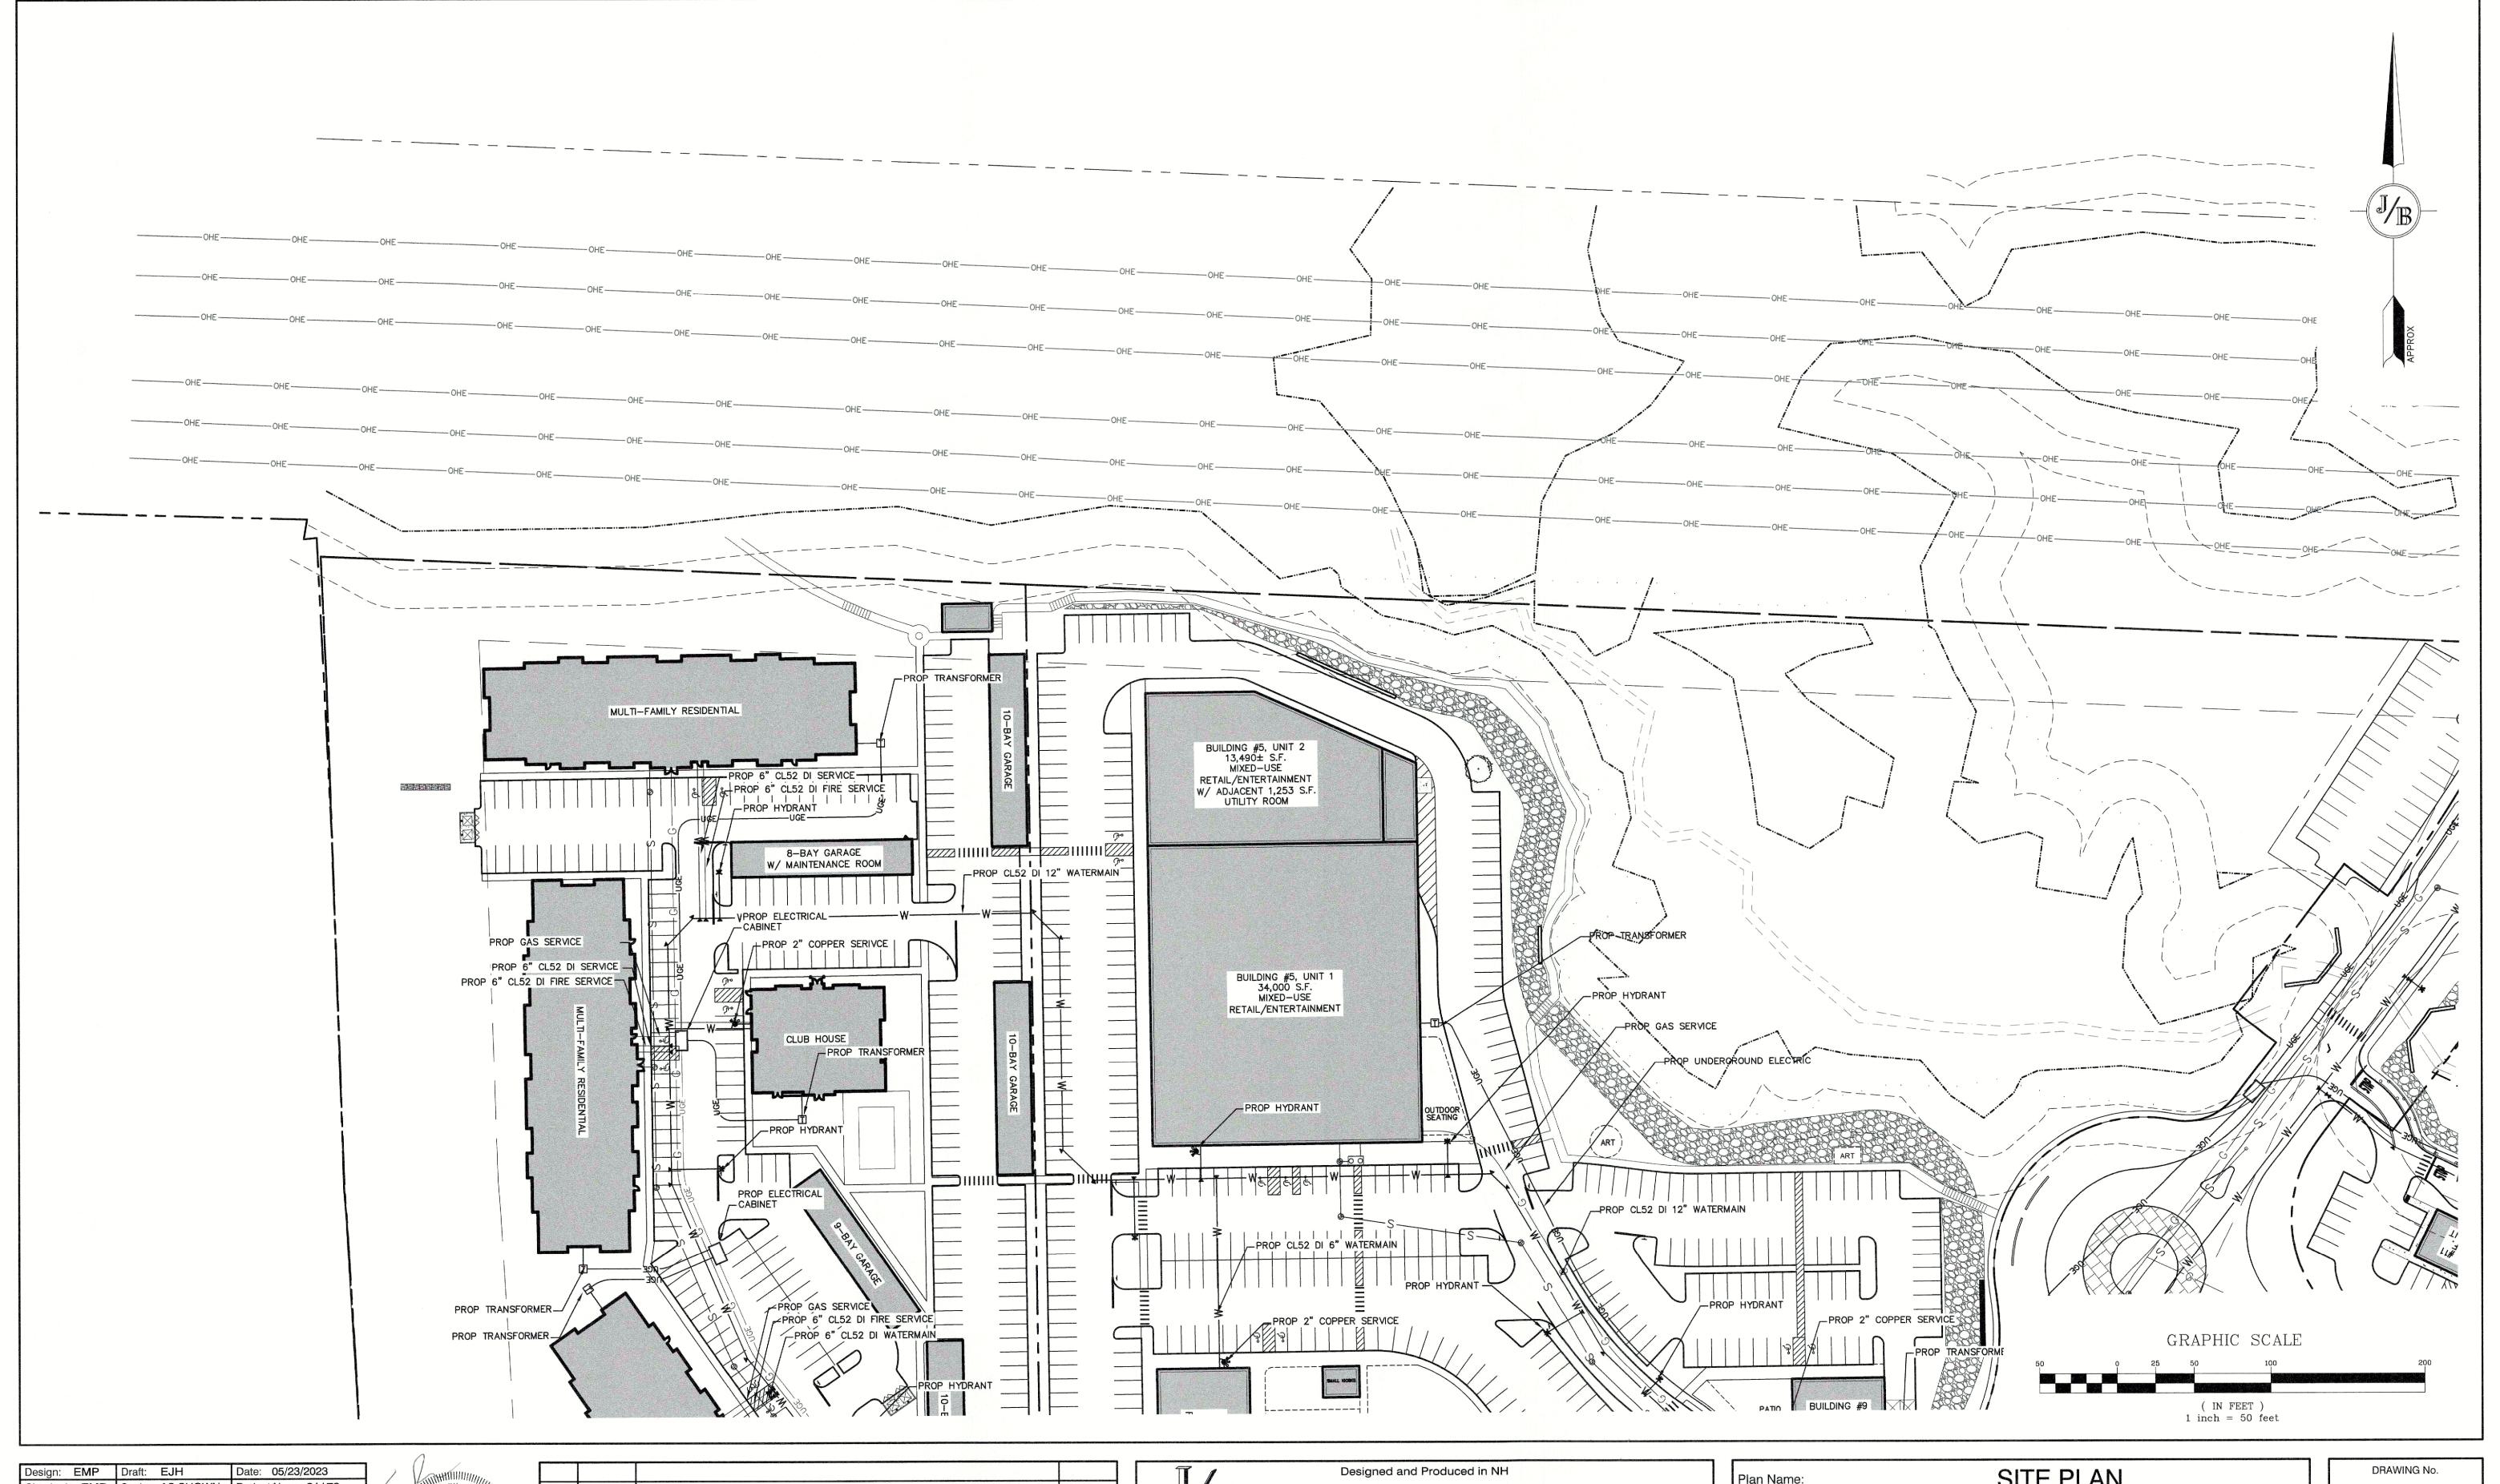
85 Portsmouth Ave.

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SHEET NO. 11 OF 21 21173

FARMINGTON ASSOCIATES PROPERTIES, LLC

322 RESERVOIR ST, NEEDHAM, MA 02494



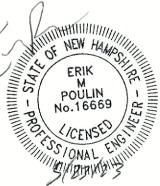
Design: EMP Draft: EJH Date: 05/23/2023

Checked: EMP Scale: AS SHOWN Project No.: 21173

Drawing Name: 21173.1-PHASE2-PLAN.DWG

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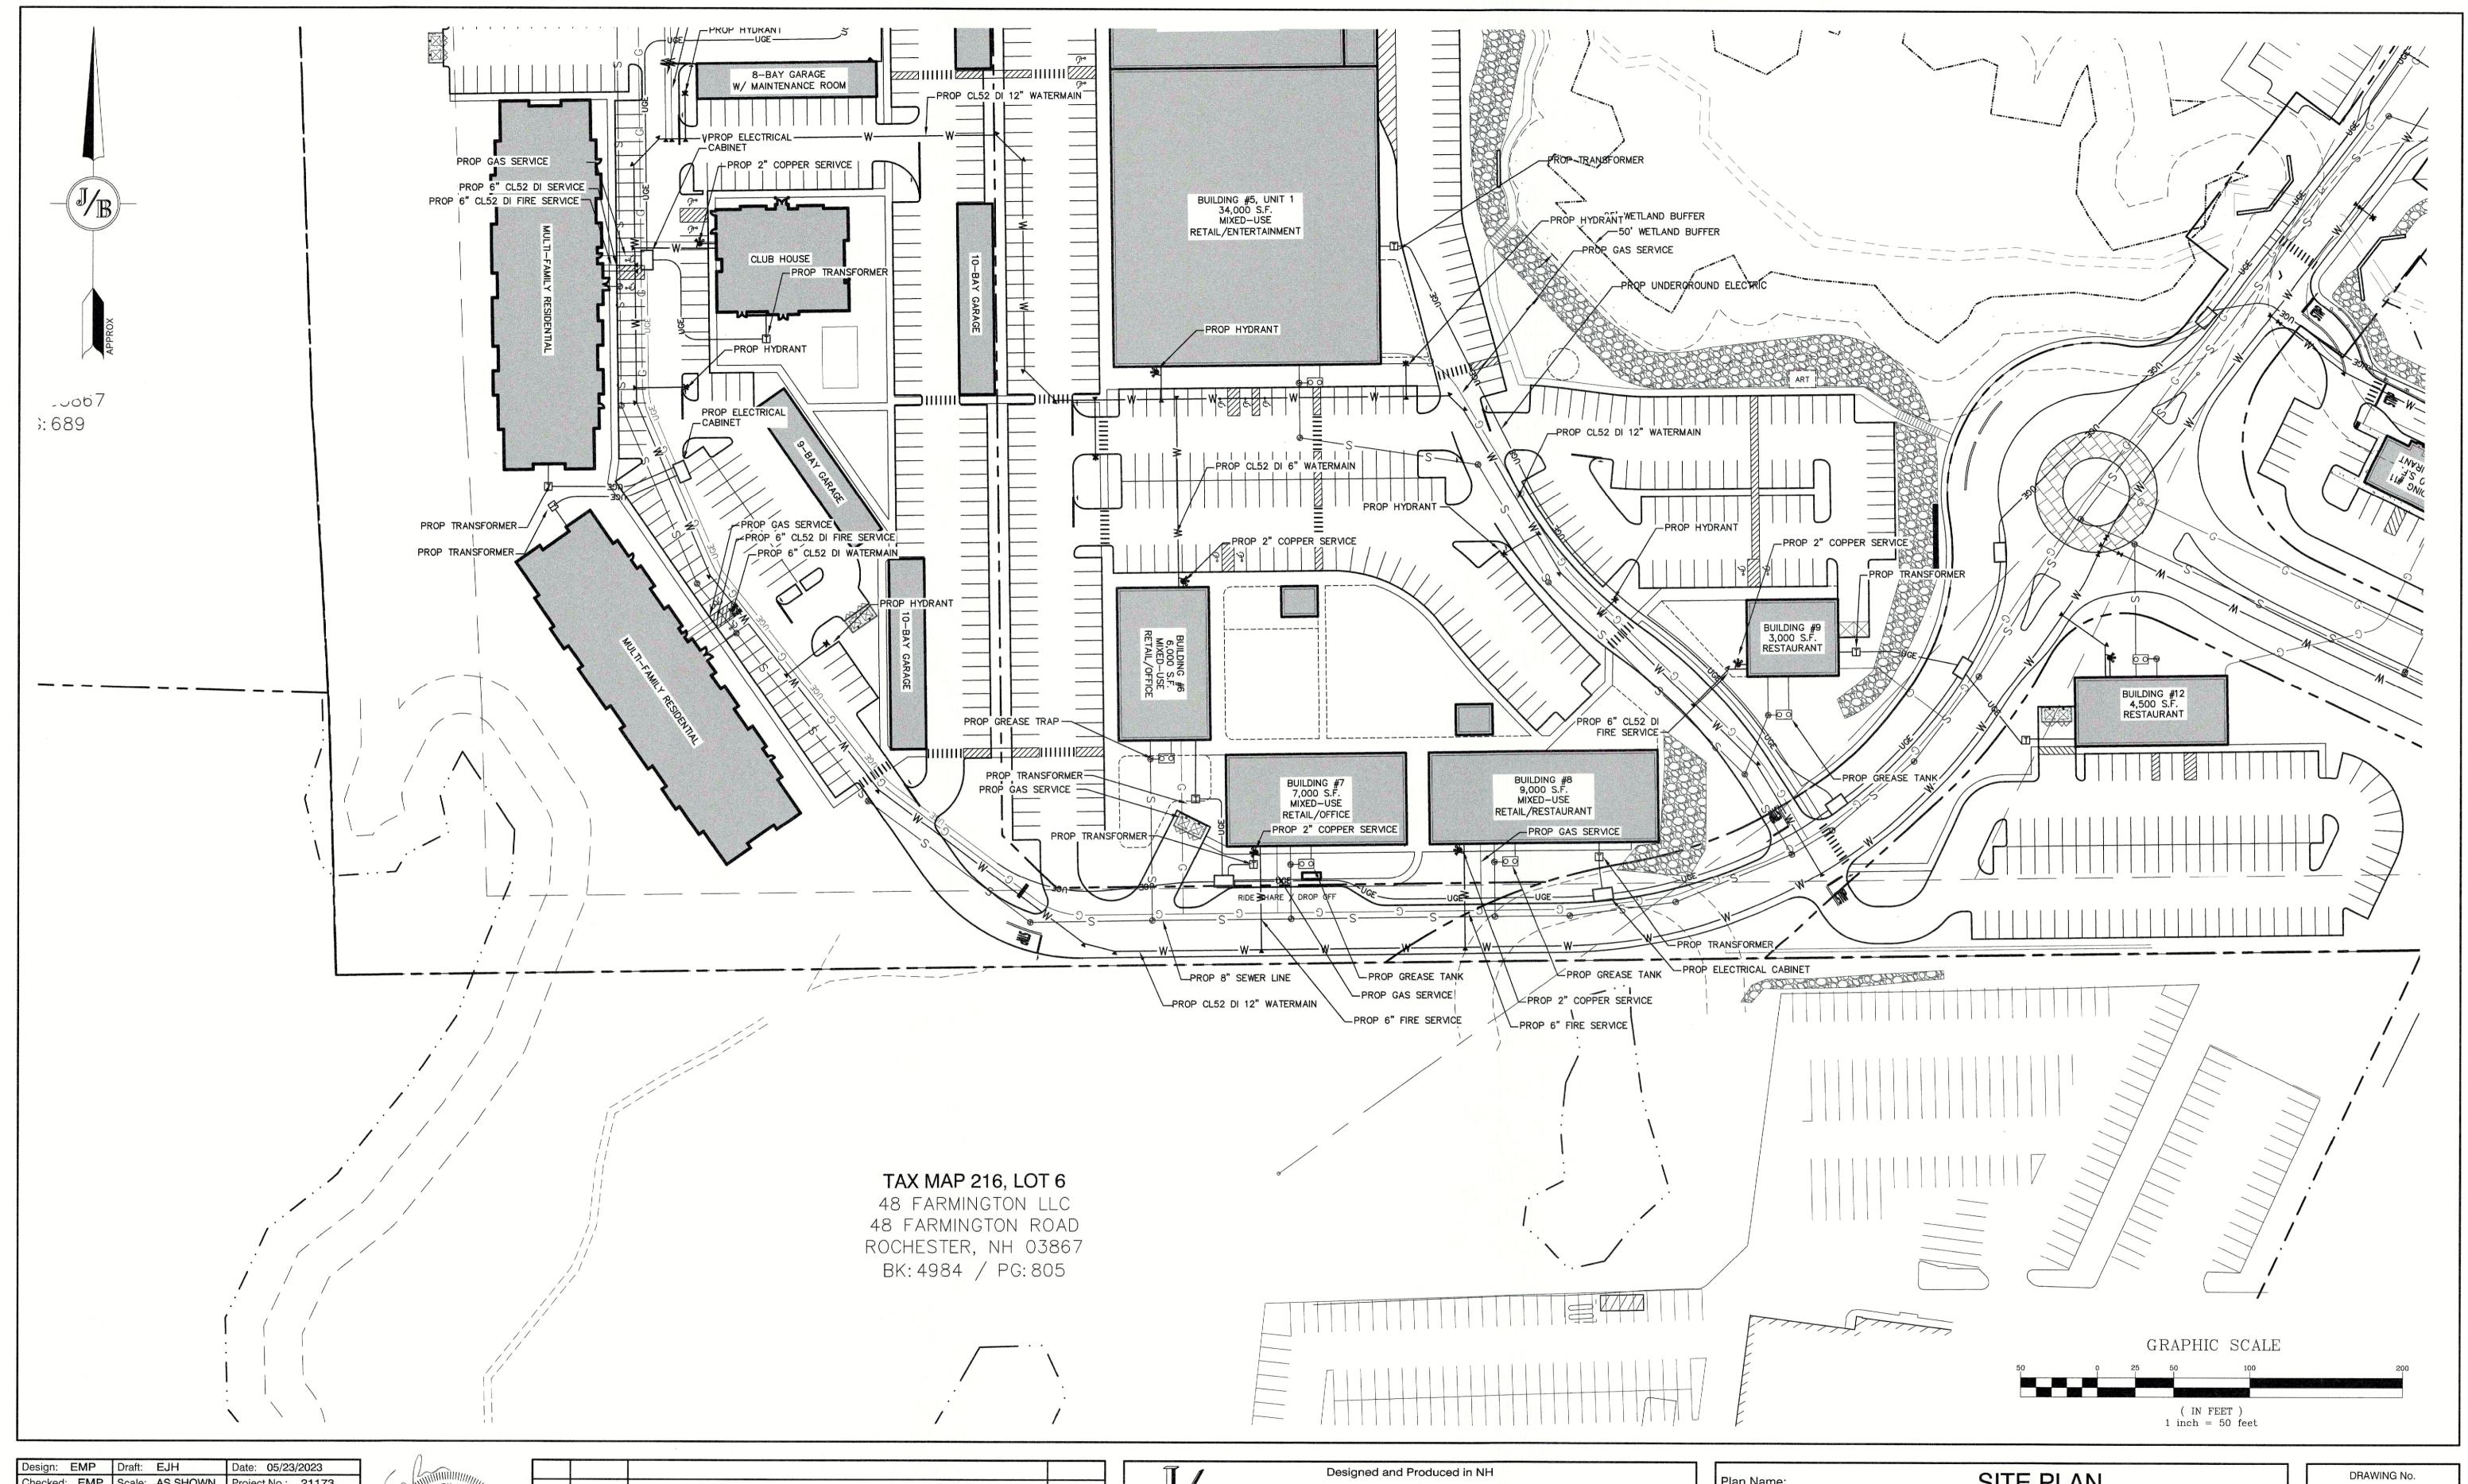
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603-772-4746
E-MAIL: JBE@JONESANDBEACH.COM

| Plan Name: | SITE PLAN |
|------------------|--|
| Project: | PROPOSED PARKING LOT EXPANSION MARKETPLACE BLVD, ROCHESTER, NH |
| Owner of Record: | FARMINGTON ASSOCIATES PROPERTIES, LLC 322 RESERVOIR ST, NEEDHAM, MA 02494 |

DRAWING No.

C4-1

SHEET NO. 12 OF 21
JBE PROJECT NO. 21173



Design: EMP Draft: EJH Date: 05/23/2023

Checked: EMP Scale: AS SHOWN Project No.: 21173

Drawing Name: 21173.1-PHASE2-PLAN.DWG

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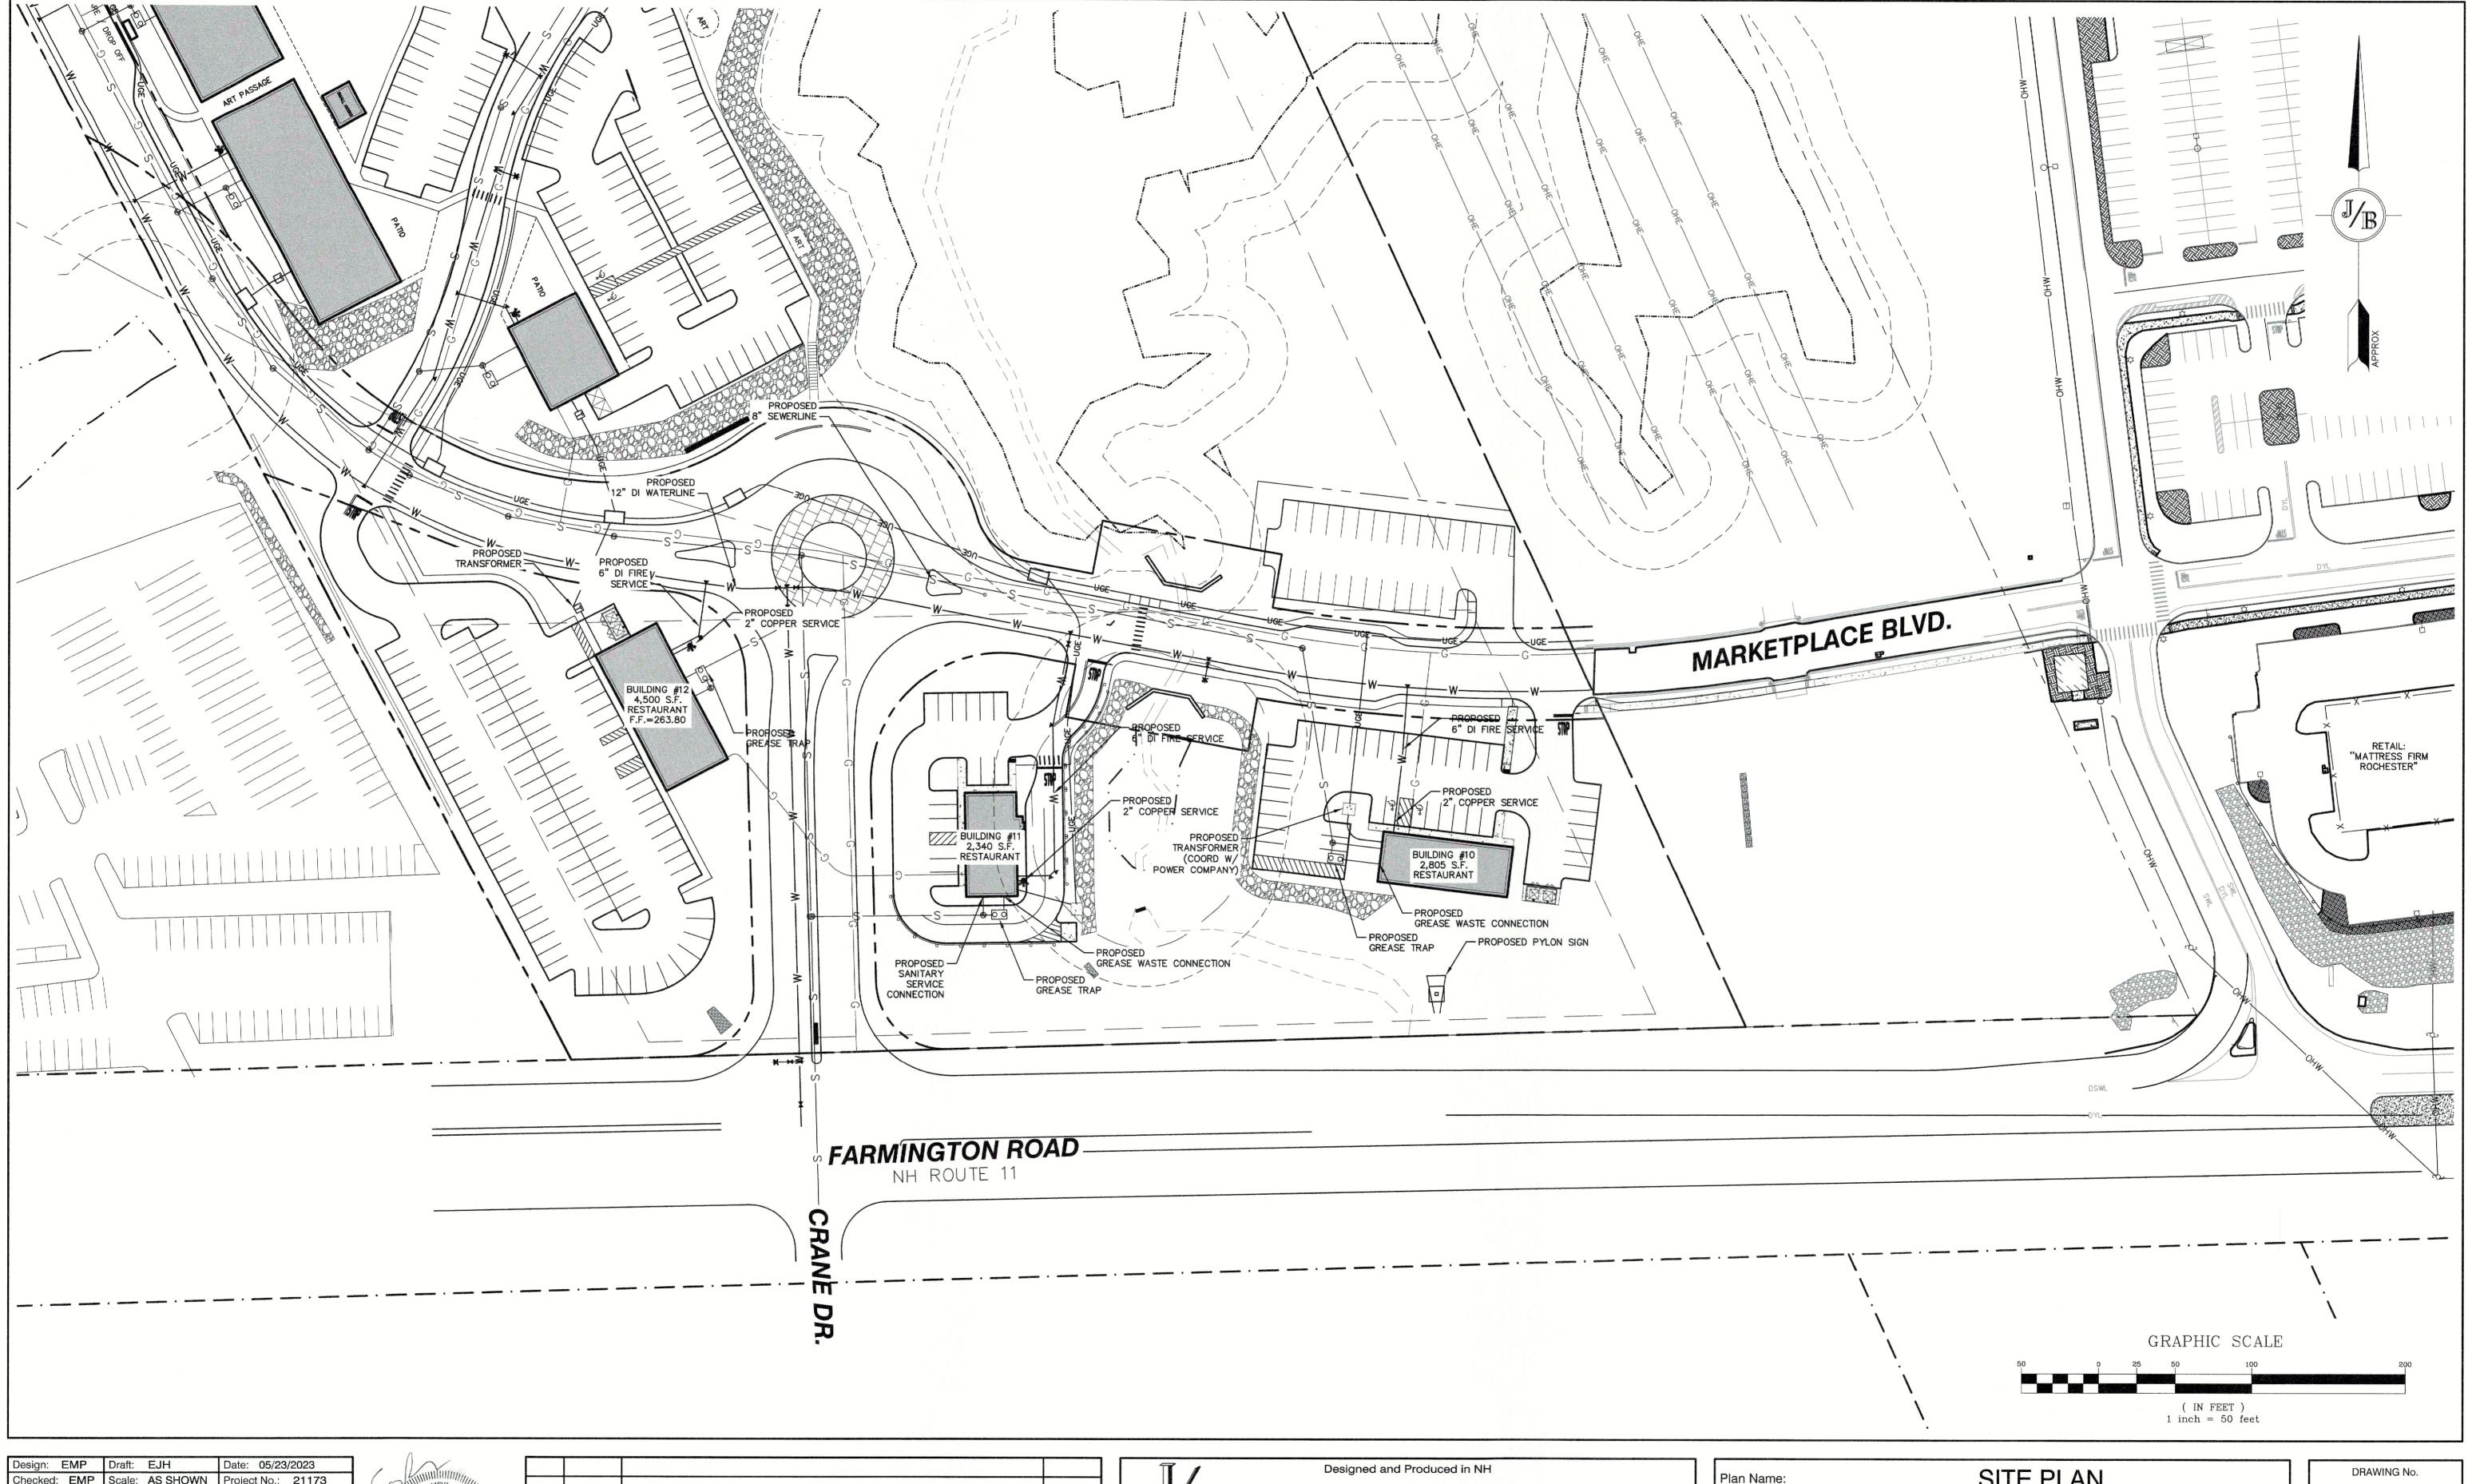
B Jones & Beach Engineers, Inc.

Civil Engineering Services
85 Portsmouth Ave.
PO Box 219, Stratham, NH 03885

Civil Engineering Services
603-772-4746
E-MAIL: JBE@JONESANDBEACH.COM

| Plan Name: | SITE PLAN | |
|---------------------|--|--|
| Project: | PROPOSED PARKING LOT EXPANSION MARKETPLACE BLVD, ROCHESTER, NH | |
| Owner of Record: | FARMINGTON ASSOCIATES PROPERTIES, LLC 322 RESERVOIR ST, NEEDHAM, MA 02494 | |

SHEET NO. 13 OF 21
JBE PROJECT NO. 21173



| Design: EMP | Draft: EJH | Date: 05/23/2023 |
|-----------------|----------------------|-------------------------|
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| Drawing Name: | 21173.1-PHASE2-PLAN | N.DWG |
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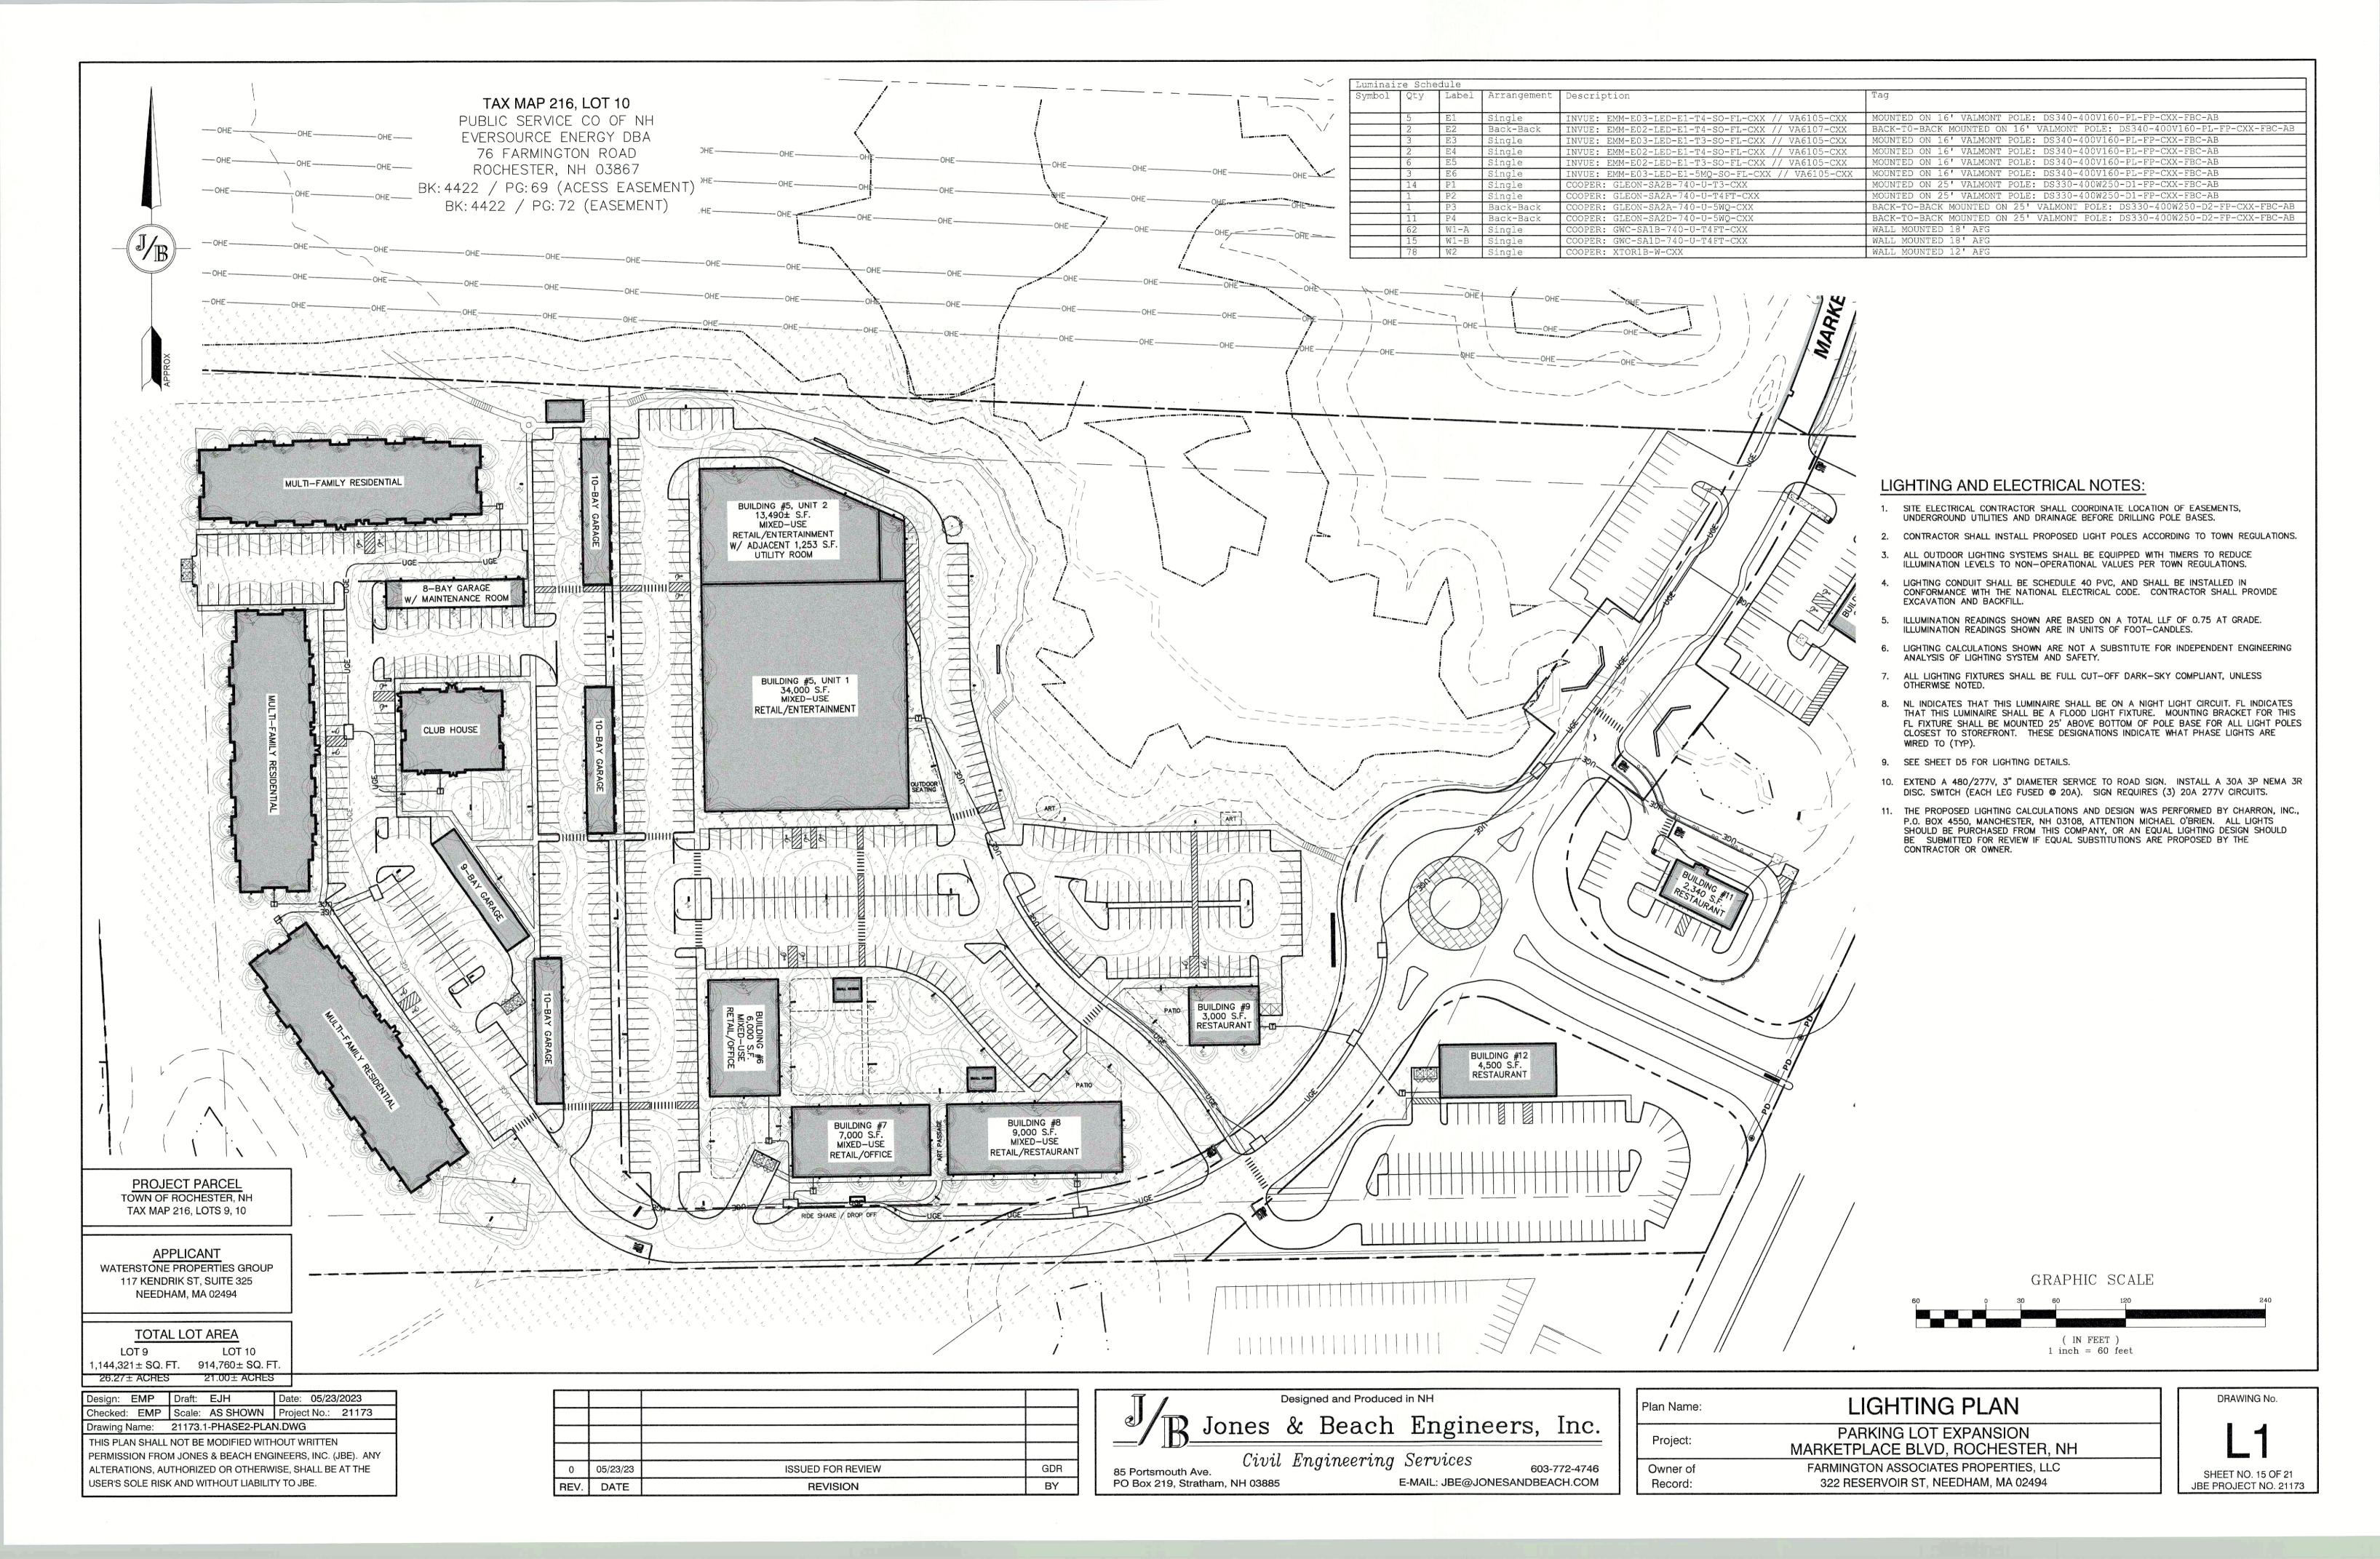
Civil Engineering Services
603-772-4746
E-MAIL: JBE@JONESANDBEACH.COM


| Plan Name: | SITE PLAN | |
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| Project: | PROPOSED PARKING LOT EXPANSION MARKETPLACE BLVD, ROCHESTER, NH | Aviano anterior processor de communes |
| Owner of Record: | FARMINGTON ASSOCIATES PROPERTIES, LLC 322 RESERVOIR ST, NEEDHAM, MA 02494 | |

DRAWING No.

C4-3

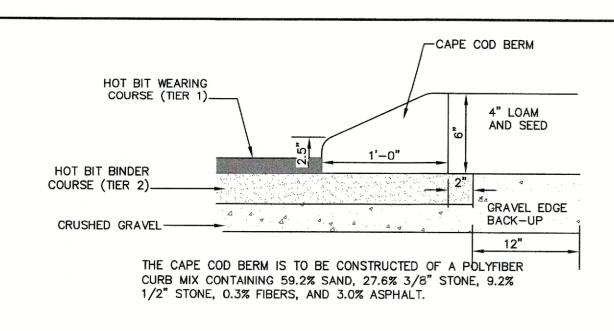
SHEET NO. 14 OF 21
JBE PROJECT NO. 21173






CAPE COD BERM

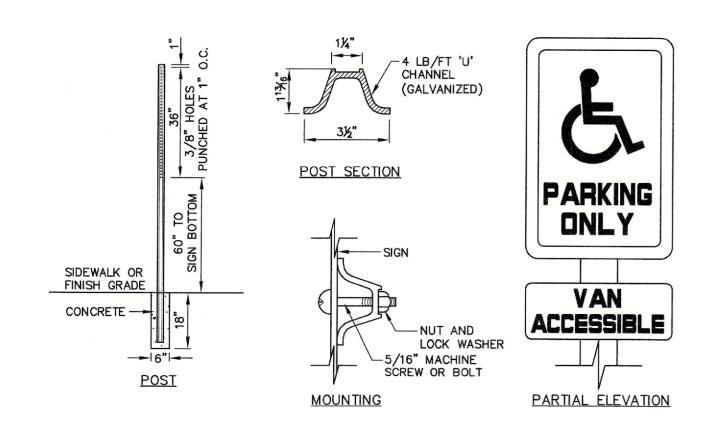NOT TO SCALE



HANDICAP SIGN DETAILS

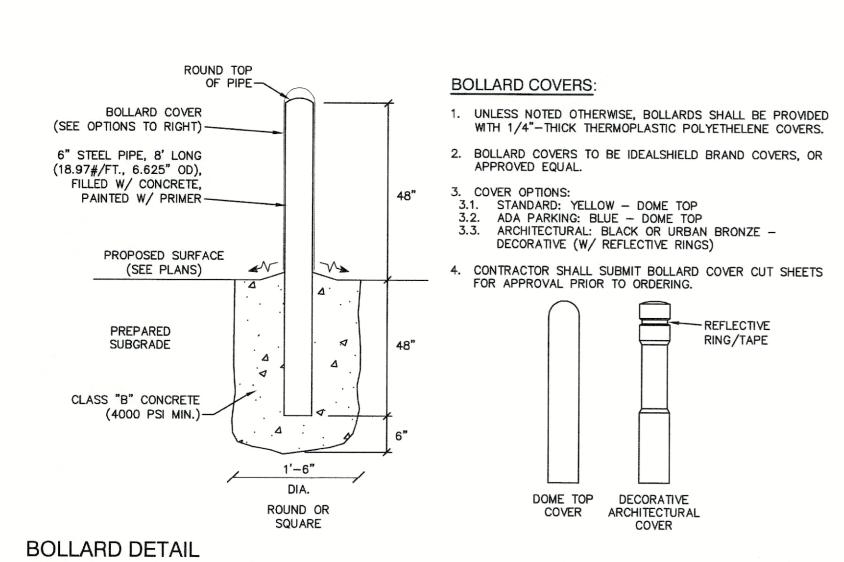NOT TO SCALE




PAVEMENT DIMENSIONS REFER TO THIS POINT PAVEMENT ELEVATIONS REFER TO THIS POINT PARKING LOT SURFACE AS SPECIFIED BASE AS SPECIFIED ·(MIN.):

NOTES:

- 1. EDGING TO BE PLACED PRIOR TO PLACING TOP SURFACE COURSE.
- JOINTS BETWEEN STONES SHALL BE MORTARED.

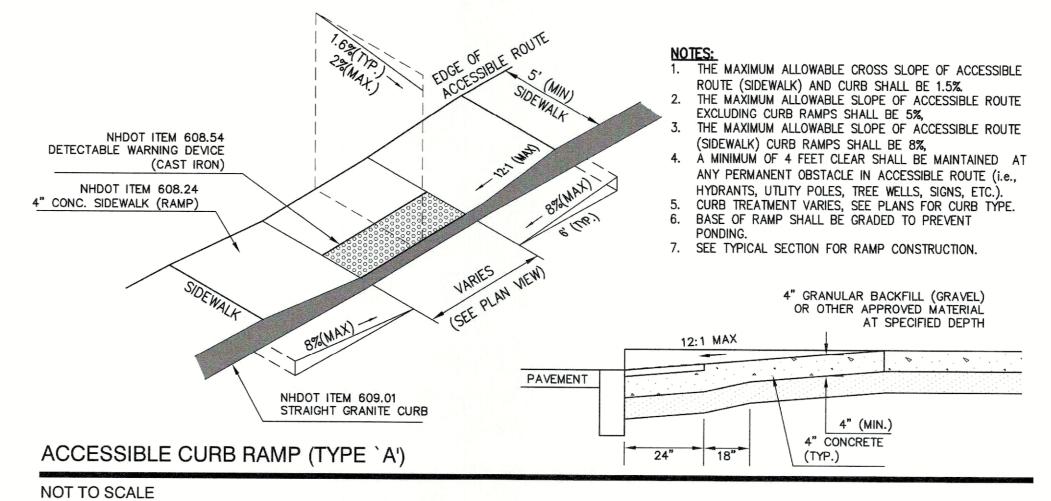VERTICAL GRANITE CURB



REFLECTIVE ALUMINUM 36"x36" - GALVANIZED "U" CHANNEL POST PAINT CONCRETE BLACK AFTER CURING AT ASPHALT LOCATIONS -4,000 PSI CONCRETE -PAVEMENT/ CONCRETE 4" MIN. IN SCENARIOS WHERE N.H.D.O.T. HAS JURISDICTION OVER STOP SIGN, NO CONCRETE MAY BE USED FOR SIGN

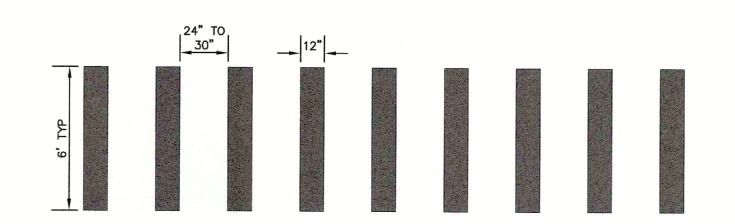
-4" LOAM & SEED

SUBGRADE

INSTALLATION.

STOP SIGN (R1-1)


NOT TO SCALE



- 1. TRANSVERSE CROSSWALK LINES SHALL BE THERMOPLASTIC, NOT LESS THAN 6" WIDE AND NOT LESS THAN 6' APART.
- 2. SPACING FOR THE CONTINENTAL CLOCK MARKINGS SHALL BE UNIFORM FOR EACH INDIVIDUAL CROSSWALK BUT CAN BE MODIFIED FOR ONE CROSSWALK TO THE NEXT TO ELIMINATE A CROSSWALK MARKING DIRECTLY IN THE WHEELPATH.

NHDOT CONTINENTAL BLOCK MARKING DETAIL

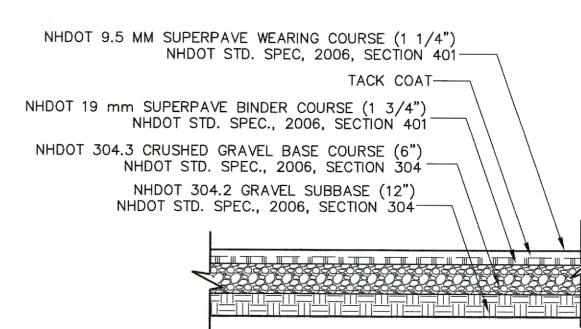NOT TO SCALE




NOTES:

- 1. PAVEMENT SUBGRADES SHOULD BE PROOF ROLLED IN ORDER TO DENSIFY THE SUBGRADES USING A MINIMUM OF 4 PASSES WITH A 10-TON VIBRATORY DRUM COMPACTOR. THE GRAVEL BORROW SUBGRADE COURSE AND CRUSHED GRAVEL BASE COURSE SHOULD BE COMPACTED TO A MINIMUM OF 95% RELATIVE COMPACTION OF THE MAXIMUM DRY DENSITY AS DETERMINED BY THE STANDARD PROCTOR TEST (ASTM-D698)
- 2. PAVEMENT SECTION SUBJECT TO CHANGE BASED ON GEOTECHNICAL INVESTIGATION.

STANDARD DUTY ASPHALT PAVEMENT SECTION

NOT TO SCALE

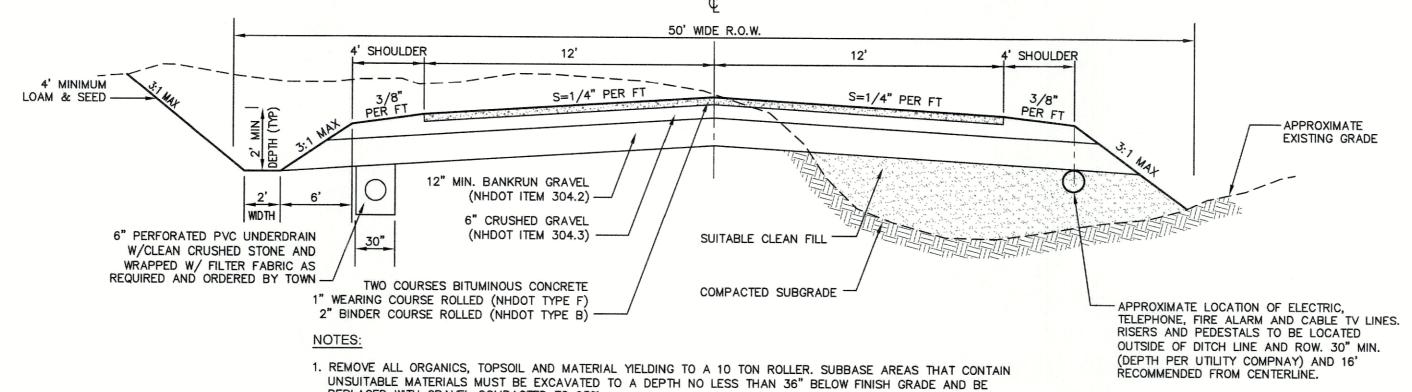
NOT TO SCALE



- REPLACED WITH GRAVEL COMPACTED TO 95%.
- 2. ALL MATERIALS TO BE AS SPECIFIED PER TOWN STANDARDS AND NHDOT, WHICHEVER IS MOST STRINGENT. GRADATION AND COMPACTION TEST RESULTS (95% MIN.) SHALL BE SUBMITTED FOR REVIEW AND APPROVAL.
- 3. TOWN MAY REQUIRE UNDERDRAIN, ADDITIONAL GRAVEL AND/OR ADDITIONAL DRAINAGE IF SOIL CONDITIONS WARRANT.
- 4. WOVEN GEOTEXTILE FABRIC SHALL BE PLACED ABOVE SUBGRADE AT ALL WETLAND CROSSINGS.

TYPICAL ROADWAY SECTION

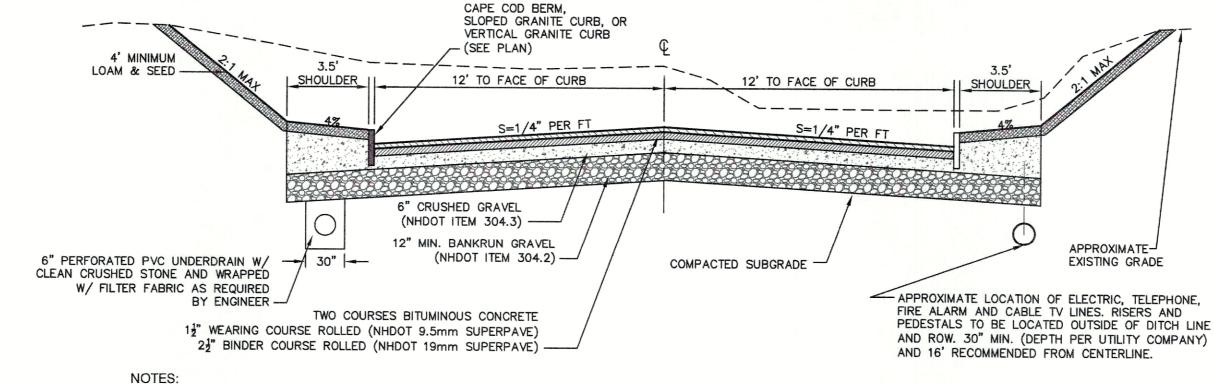NOT TO SCALE



NOTES:

- 1. REMOVE ALL ORGANICS, TOPSOIL AND MATERIAL YIELDING TO A 10 TON ROLLER. SUBBASE AREAS THAT CONTAIN UNSUITABLE MATERIALS MUST BE EXCAVATED TO A DEPTH NO LESS THAN 36" BELOW FINISH GRADE AND BE REPLACED WITH GRAVEL COMPACTED TO 95%.
- 2. ALL MATERIALS TO BE AS SPECIFIED PER TOWN STANDARDS AND NHDOT, WHICHEVER IS MOST STRINGENT. GRADATION AND COMPACTION TEST RESULTS (95% MIN.) SHALL BE SUBMITTED FOR REVIEW AND APPROVAL.
- 3. TOWN OR ENGINEER MAY REQUIRE UNDERDRAIN, ADDITIONAL GRAVEL AND/OR ADDITIONAL DRAINAGE IF SOIL CONDITIONS WARRANT.

85 Portsmouth Ave.

PO Box 219, Stratham, NH 03885

- 4. WOVEN GEOTEXTILE FABRIC SHALL BE PLACED ABOVE SUBGRADE AT ALL WETLAND CROSSINGS.
- 5. UNDERDRAIN TO BE INSTALLED IN ALL CUT-SECTION OF ROADWAY.

TYPICAL ROADWAY SECTION W/CURBING

NOT TO SCALE

| Scale: | AS SHOWN | Desired No. 04470 |
|---------|---------------------------|---|
| | 100110 | Project No.: 21173 |
| 21173. | 1-PHASE2-PLA | N.DWG |
| NOT BE | MODIFIED WITH | HOUT WRITTEN |
| | | GINEERS, INC. (JBE). ANY |
| THORIZI | ED OR OTHERW | /ISE, SHALL BE AT THE |
| AND W | ITHOUT LIABILIT | TY TO JBE. |
| | NOT BE JONES THORIZ | 21173.1-PHASE2-PLA NOT BE MODIFIED WITH JONES & BEACH ENG THORIZED OR OTHERW AND WITHOUT LIABILIT |

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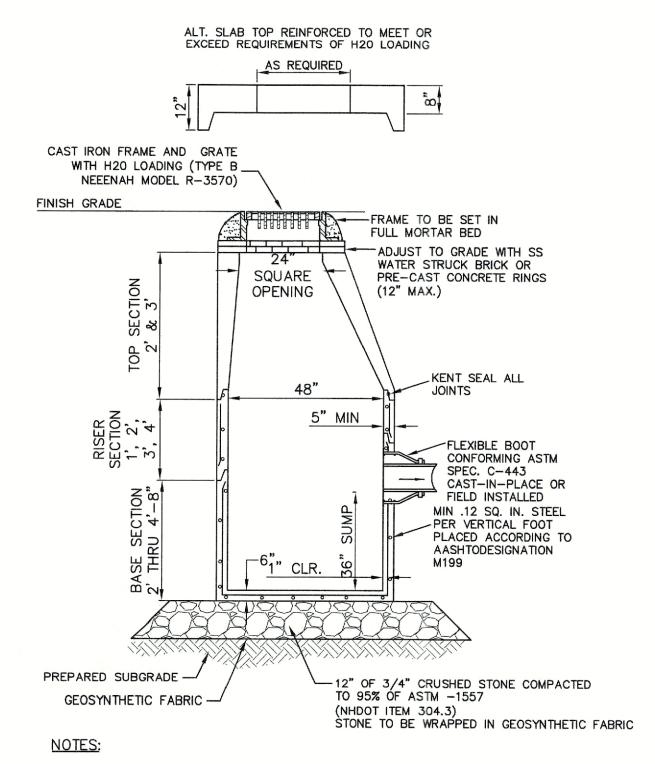
603-772-4746

E-MAIL: JBE@JONESANDBEACH.COM

| an Name: DETAIL SHEET | |
|-----------------------|--|
| Project: | FARMINGTON ASSOCIATES PROPERTIES, LLC MARKETPLACE BLVD, ROCHESTER, NH |
| Owner of Record: | FARMINGTON ASSOCIATES PROPERTIES, LLC 322 RESERVOIR ST, NEEDHAM, MA 02494 |

SHEET NO. 16 OF 21 JBE PROJECT NO. 21173


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- BASE SECTION SHALL BE MONOLITHIC WITH 48" INSIDE DIAMETER.
- 2. ALL SECTIONS SHALL BE DESIGNED FOR H20 LOADING.
- CONCRETE SHALL BE COMPRESSIVE STRENGTH 4000 PSI, TYPE II CEMENT.
- 4. FRAMES AND GRATES SHALL BE HEAVY DUTY AND DESIGNED FOR H20
- 5. PROVIDE "V" KNOCKOUTS FOR PIPES WITH 2" MAX. CLEARANCE TO OUTSIDE OF PIPE. MORTAR ALL PIPE CONNECTIONS SO AS TO BE WATERTIGHT.
- 6. JOINT SEALANT BETWEEN PRECAST SECTIONS SHALL BE BUTYL RUBBER.
- 7. ALL CATCH BASIN FRAMES AND GRATES SHALL BE NHDOT CATCH BASIN TYPE ALTERNATE 1 OR NEENAH R-3570 OR APPROVED EQUAL (24"x24"
- 8. STANDARD CATCH BASIN FRAME AND GRATE(S) SHALL BE SET IN FULL MORTAR BED. ADJUST TO GRADE WITH CLAY BRICK AND MORTAR (2 BRICK COURSES TYPICALLY, 5 BRICK COURSES MAXIMUM, BUT NO MORE THAN 12"), OR PRECAST CONCRETE 'DONUTS'.

CATCH BASIN


NOT TO SCALE



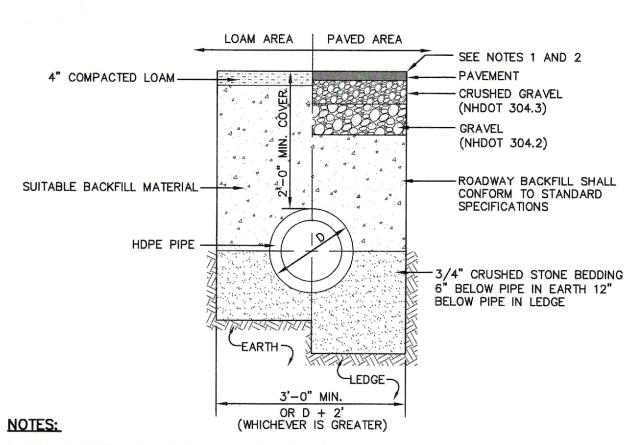- 1. PAVEMENT REPAIR IN EXISTING ROADWAYS SHALL CONFORM TO STREET OPENING REGULATIONS.
- 2. NEW ROADWAY CONSTRUCTION SHALL CONFORM WITH PROJECT AND TOWN SPECIFICATIONS.
- 3. ALL MATERIALS ARE TO BE COMPACTED TO 95% OF ASTM D-1557

DRAINAGE TRENCH

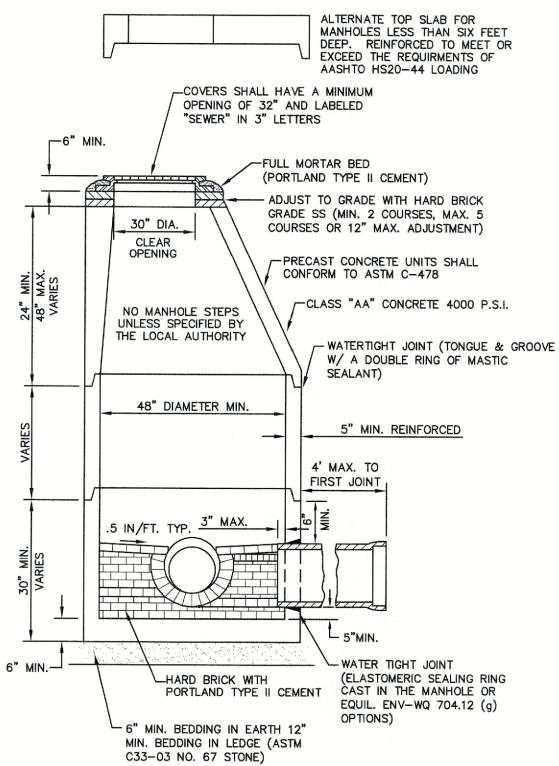NOT TO SCALE



NOTES:

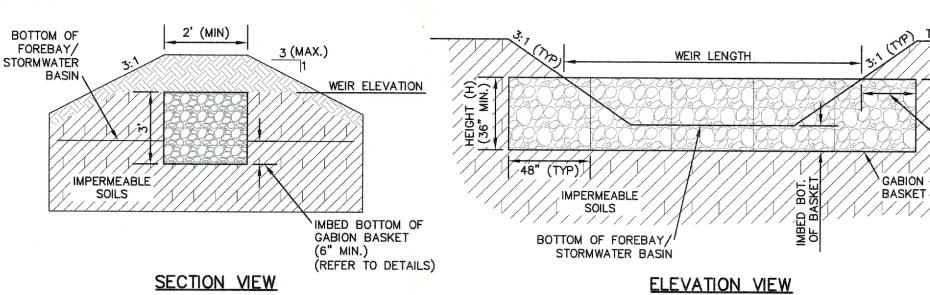
- 1. PER NHDES ENV-WQ 704.13(C), MORTAR USED IN MANHOLE CONSTRUCTION SHALL COMPLY WITH THE FOLLOWING: a. MORTAR SHALL BE COMPOSED OF TYPE II PORTLAND CEMENT AND SAND WITH OR WITHOUT
 - HYDRATED LIME ADDITION b. PROPORTIONS IN MORTAR OF PARTS BY VOLUMES SHALL BE PER TABLE 704-4:
 - (1) 4.5 PARTS SAND AND 1.5 PARTS CEMENT; OR

SPECIFICATIONS FOR ROAD AND BRIDGE CONSTRUCTION AS AVAILABLE AT:

- (2) 4.5 PARTS SAND, ONE PART CEMENT AND 0.5 PART HYDRATED LIME; C. CÈMENT SHALL BE TYPE II PORTLAND CEMENT THAT IS CERTIFIED BY ITS MANUFACTURER AS CONFORMING TO THE ASTM C150/C150M STANDARD IN EFFECT AT THE TIME THE CEMENT WAS
- d. HYDRATED LIME SHALL BE TYPE S THAT IS CERTIFIED BY ITS MANUFACTURER AS CONFORMING TO THE ASTM C207 STANDARD IN EFFECT AT THE TIME THE HYDRATED LIME WAS PROCESSED e. SAND SHALL CONSIST OF INERT NATURAL SAND THAT IS CERTIFIED BY ITS SUPPLIER AS
- CONFORMING TO THE ASTM C33 STANDARD IN EFFECT AT THE TIME THE SAND IS PROCESSED BY "STANDARD SPECIFICATIONS FOR CONCRETE, FINE AGGREGATES f. CONCRETE FOR DROP SUPPORTS SHALL CONFORM TO THE REQUIREMENT FOR CLASS AAA CONCRETE OF THE NEW HAMPSHIRE DEPARTMENT OF TRANSPORTATION'S "STANDARD
- HTTP://WWW.NH.GOV/DOT/ORG/PROJECTDEVELOPMENT/HIGHWAYDESIGN/SPECIFICATIONS/INDEX.HTM
- 2. SHELVES SHALL BE CONSTRUCTED TO THE ELEVATION OF THE HIGHEST PIPE CROWN AND SLOPED TO DRAIN TOWARD THE FLOWING THROUGH CHANNEL IN ACCORDANCE WITH ENV-WQ 704.12 (K)
- 3. ALL MANHOLES SHALL BE TESTED FOR LEAKAGE IN ACCORDANCE WITH ENV-WQ 704.17 (a) THROUGH
- 4. SEWER MANHOLE COVERS SHALL CONFORM TO ASTM A48/48M WITH A CASTING EQUAL TO CLASS 30 IN ACCORDANCE WITH ENV-WQ 704.13 (a) (8).
- 5. ALL PRECAST SECTIONS SHALL BE COATED ON THE EXTERIOR WITH A BITUMINOUS DAMP-PROOFING COATING IN ACCORDANCE WITH ENV-WQ 704.12 (J).
- 6. ALL PRECAST SECTIONS AND BASES SHALL HAVE THE DATE OF MANUFACTURE AND THE NAME OR TRADEMARK OF THE MANUFACTURER IMPRESSED OR INDELIBLY MARKED ON THE INSIDE WALL PER
- 7. BRICK MASONRY SHALL CONFORM TO ASTM C32 (ENV-WQ 704.12(a)(9))

SEWER MANHOLE

NOT TO SCALE



TOP OF BERM WEIR ELEVATION **FOREBAY** (PER PLANS) BOT ELEV.=10 END WEIR LENGTH IMBED GABION BASKET IN BERM OTAL LENGTH (GABION BASKET WEIR POND BASIN BOT ELEV.=10 PLAN VIEW W/ EXAMPLE

IN ACCORDANCE WITH UTILITY PLASTIC MARKER TAPE ABOVE CABLES -COMPANY STANDARDS ELECTRIC SERVICE CABLES 250 VAC OR LESS PVC-SCH 40-- CATV CABLE (PVC-SCH L__2-SPARE 4" PVC

(12" MIN.)

EXCAVATION AND BACKFILL

-PRIMARY POWER 5" SCH. 80 PVC CABLE

LOAM AREA PAVED AREA

W = WIDTH

4. W= MAXIMUM ALLOWABLE TRENCH WIDTH TO A PLANE 12" INCHES ABOVE THE PIPE. FOR PIPES 15 INCHES NOMINAL

5. RIGID FOAM INSULATION TO BE PROVIDED WHERE COVER IN THE ROADWAY IS LESS THAN 6' AND CROSS COUNTRY IS

6. PIPE SAND BLANKET MATERIAL SHALL BE GRADED SAND, FREE FROM ORGANIC MATERIALS, GRADED SUCH THAT 100%

PASSES A 1/2 " SIEVE AND A MAXIMUM OF 15% PASSES A #200 SIEVE IN ACCORDANCE WITH Env-Wq 704.11(b). 7. JOINT SEALS FOR PVC PIPE SHALL BE OIL RESISTANT COMPRESSION RINGS OF ELASTOMERIC MATERIAL AND CERTIFIED

BY THE MANUFACTURER AS CONFORMING TO THE ASTM D3212 STANDARD IN EFFECT WHEN THE JOINT SEALS WERE

MANUFACTURED, AND SHALL BE PUSH-ON, BELL-AND-SPIGOT TYPE PER Env-Wq 704.05 (e).

DIAMETER OR LESS, WIDTH SHALL BE NO MORE THAN 36"; FOR PIPES GREATER THAN 15 INCHES NOMINAL DIAMETER,

WIDTH SHALL BE 24 INCHES PLUS PIPE O.D. WIDTH SHALL ALSO BE THE PAYMENT WIDTH FOR LEDGE EXCAVATION AND

1. PAVEMENT REPAIR IN EXISTING ROADWAYS SHALL CONFORM TO PAVEMENT DETAILS.

2. NEW ROADWAY CONSTRUCTION SHALL CONFORM TO SUBDIVISION SPECIFICATIONS.

SEE NOTES 1 AND 2

STANDARD SPECIFICATIONS

DETECTING EQUIPMENT

- ROADWAY BACKFILL SHALL CONFORM TO

METAL IMPREGNATED MARKING TAPE TO

AID IN LOCATING BURIED PIPE WITH METAL

2" RIGID FOAM INSULATION PLACED 0.5' ABOVE

SEWER PIPE WHERE INDICATED ON THE PLANS.

CRUSHED STONE (ASTM C33/c33M STONE SIZE

NO. 67 IN ACCORDANCE WITH Env-Wq 704.11(a)

BELOW PIPE IN EARTH 12" BELOW PIPE IN LEDGE

BEDDING FOR FULL WIDTH OF THE PIPE 6"

CRUSHED GRAVEL

4" COMPACTED LOAM

SUITABLE BACKFILL

12" CLEAN_

SAND BLANKET

(SEE NOTE #6)

95% COMPACTED AS

AND SEEDED-

SPECIFIED -

8" SDR 35 PVC

UNDISTURBED SOIL -

FOR ORDERED EXCAVATION BELOW GRADE.

SEWER TRENCH

NOT TO SCALE

LESS THAN 4', PURSUANT TO DES WAIVER BEING ISSUED.

ASTM D3034-04a

7,200 VAC. OTHER POWER, TELEPHONE CATV, ETC., CABLES ARE NO CLOSER THAN 12" NOTE: ALL UTILITIES SHALL BE REVIEWED AND APPROVED BY APPROPRIATE UTILITY COMPANY.

UTILITY TRENCH

NOT TO SCALE

NOT TO SCALE

GABION BASKET WEIR

Design: EMP Draft: EJH Date: 05/23/2023 Checked: EMP | Scale: AS SHOWN | Project No.: 21173 Drawing Name: 21173.1-PHASE2-PLAN.DWG THIS PLAN SHALL NOT BE MODIFIED WITHOUT WRITTEN PERMISSION FROM JONES & BEACH ENGINEERS, INC. (JBE). ANY ALTERATIONS, AUTHORIZED OR OTHERWISE, SHALL BE AT THE

USER'S SOLE RISK AND WITHOUT LIABILITY TO JBE.



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| 0 | 05/23/23 | ISSUED FOR REVIEW | GDR |
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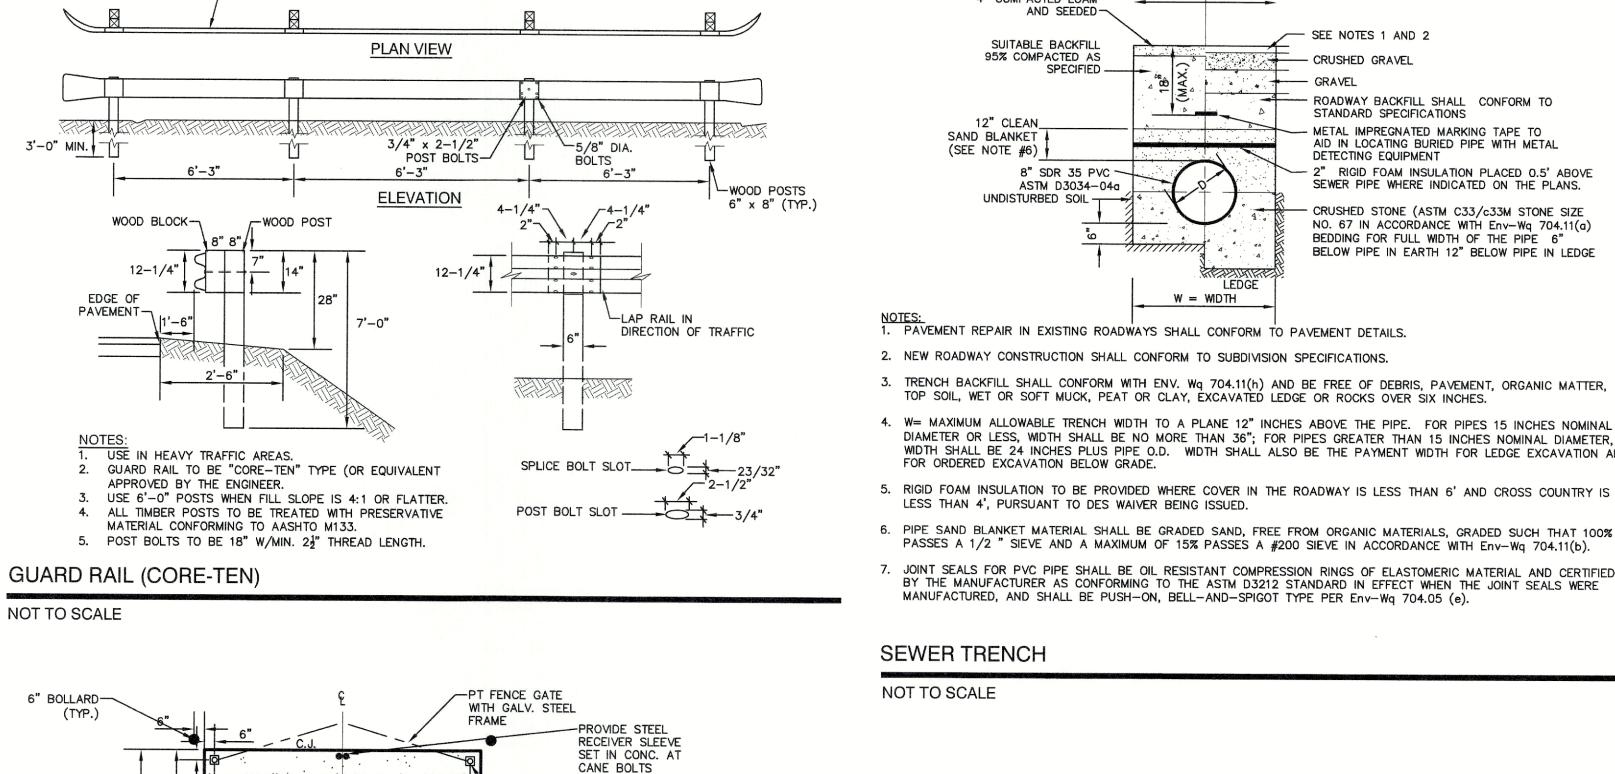
DUMPSTER ENCLOSURE PLAN

NOT TO SCALE

Civil Engineering Services 603-772-4746 85 Portsmouth Ave. PO Box 219, Stratham, NH 03885 E-MAIL: JBE@JONESANDBEACH.COM

| Plan Name: | DETAIL SHEET |
|------------------|--|
| Project: | FARMINGTON ASSOCIATES PROPERTIES, LLC MARKETPLACE BLVD, ROCHESTER, NH |
| Owner of Record: | FARMINGTON ASSOCIATES PROPERTIES, LLC 322 RESERVOIR ST, NEEDHAM, MA 02494 |

DRAWING No. SHEET NO. 17 OF 21 JBE PROJECT NO. 21173



3" GALV. STEEL FENCE POST WITH PT FENCE PANEL -6" THICK SEALED CONCRETE PAD -SEE SITE DWGS 2x4 HORIZONTAL BEAMS-FOR GRADE ELEVATIONS -LINE POST (TYP.) 6"x6" W1.4xW1.4 W.W.F. REAR -18" THICK SLAB -3" GALV. STEEL FENCE POST WITH PT FENCE PANEL 6" BOLLARD (TYP.)-1x6 PT FENCE PLANKS-1. ALL LUMBER TO BE PRESSURE TREATED.

2. WOOD FENCE TO BE PAINTED OR STAINED TO MATCH BUILDING FOUNDATION.

> 3. DUMPSTER SIZE VARIES, SEE SITE PLANS FOR SCREENING SIZE

─3" GALVANIZED END POST -LEAVE 1" GAP BETWEEN FENCE & CONCRETE -TURN DOWN EDGE OF SLAB Monthly grap AS SHOWN -6" REINFORCED HAUNCH CONCRETE SLAB SECTION A-A

3" GALVANIZED CLAMP (TYP.).

POND STRUCTURE - WATERTIGHT ORIFICE PLATE (SEE DETAIL) PROP. BERM PLANT BASIN W/ N.E. EROSION 2' W x 16' L x 1.45' D — GABION BASKET TO CONTROL/RESTORATION MIX FOR EMERG. OVERFLOW -TOP OF BERM BE EMBEDDED IN -DETENTION BASINS + MOIST SITES) EARTHEN BERM 36" ORIFICE --GRAVEL FOREBAY WITH TRASH RACK BERM (TYP.) SEDIMENT - SEE CBCS DETAIL FOREBAY (SEE DETAIL) THIS SHEET POND BOTTOM D50=3"~ IMPERMEABLE . -NATIVE SOILS -HDPE OUT

BIO-INFILTRATION MIX AND PROCEDURE:

- 1. REMOVE EXISTING FOREST LITTER FROM INFILTRATION BASIN SITE.
- 2. REMOVE SANDY LOAM AND STOCKPILE (SCREEN LARGE ROOTS).
- 3. REMOVE SANDY LAYERS TO 18" BELOW BASIN FLOOR ELEVATION.
- 4. BIO-INFILTRATION MIX: (BY VOLUME)
- 4.1. 50%-55% ASTM C-33 CONCRETE SAND. 4.2. 20%-30% LOAMY SAND TOPSOIL WITH 15%-25% FINES PASSING
- 4.3. 20%-30% MODERATELY FINE SHREDDED BARK OR WOOD FIBER MULCH WITH LESS THAN 5% PASSING THE #200 SIEVE.
- 5. INSTALL TO BIO-INFILTRATION MIX TO BASIN BOTTOM ELEVATION
- 6. SEED WITH "NEW ENGLAND WARM SEASON GRASS MIX" AS SOLD BY

NEW ENGLAND WETLAND PLANTS, INC. OR EQUAL AS APPROVED BY

WATERTIGHT

ORIFICE PLATE

PROP. BERM

- ENGINEER. APPLICATION RATE = 1900 SQ.FT. / LB.
- 6.1. LIGHTLY MULCH WITH WEED FREE STRAW.

POND STRUCTURE

PAVEMENT SUBGRADE. PREPARE PER SPECIFICATIONS AND PAVEMENT SUBGRADE, MATERIALS PER SPECIFICATIONS PLANS. PAVED INSTALLATIONS HAVE DEPTH(S) PER SPECIFICATIONS STRINGENT MATERIAL AND PREPARATION REQUIREMENTS. GRANULAR WELL-GRADED 3, 357, 4, 467, 5, A-1

ACCEPTABLE FILL MATERIALS

STORMTECH SC-310 AND SC-740 CHAMBER SYSTEMS

DESCRIPTION

BETWEEN ¾ - 2 INCH

AASHTO M43 AASHTO M145 COMPACTION/DENSITY

DESIGNATION DESIGNATION REQUIREMENT

COMPACT IN 6" LIFTS TO A MINIMUM 95% FILL MATERIAL FROM 1.50' ABOVE CHAMBERS TO SOIL/AGGREGATE MIXTURES, 56, 57, 6, 67, 68, A-2 STANDARD PROCTOR DENSITY. ROLLER 7, 78, 8, 89, 9, 10 A-3 GROSS VEHICLE WEIGHT NOT TO BOTTOM OF PAVEMENT <35% FINES. EXCEED 12,000 LBS. DYNAMIC FORCE SUBGRADE NOT TO EXCEED 20,000 LBS. WASHED ANGULAR STONE WITH EMBEDMENT STONE 3, 357, 4, 467, NO COMPACTION REQUIRED SURROUNDING AND TO A THE MAJORITY OF PARTICLES (B) 1.50' ELEVATION ABOVE BETWEEN 34 - 2 INCH WASHED ANGULAR STONE WITH PLATE COMPACT OR ROLL TO 12 " FOUNDATION STONE 3, 357, 4, 467, THE MAJORITY OF PARTICLES ACHIEVE A 95% STANDARD (A) BELOW CHAMBERS 5, 56, 57

PLEASE NOTE: THE LISTED AASHTO DESIGNATIONS ARE FOR GRADATIONS ONLY. THE STONE MUST ALSO BE WASHED CRUSHED ANGULAR. FOR EXAMPLE, THE STONE MUST BE SPECIFIED AS WASHED, CRUSHED, ANGULAR NO. 4 STONE.

-CONCRETE COLLAR NOT REQUIRED

FOR UNPAVED APPLICATIONS

-12" NYOPLAST INLINE

-4" SDR35 PVC PIPE

─MC-3500 OR

MC-4500 CHAMBER

DRAIN BODY W/ SOLID

HINGED COVER OR GRATE

MATERIAL LOCATION

STORMTECH GENERAL NOTES

- 1. STORMTECH LLC ("STORMTECH") REQUIRES INSTALLING CONTRACTORS TO USE AND UNDERSTAND STORMTECH'S LATEST INSTALLATION INSTRUCTIONS PRIOR TO BEGINNING SYSTEM INSTALLATION.
- 2. STORMTECH OFFERS INSTALLATION CONSULTATIONS TO INSTALLING CONTRACTORS. CONTACT OUR TECHNICAL SERVICE DEPARTMENT OR LOCAL STORMTECH REPRESENTATIVE AT LEAST 30 DAYS PRIOR TO SYSTEM INSTALLATION TO ARRANGE A PRE-INSTALLATION CONSULTATION. OUR REPRESENTATIVES CAN THEN ANSWER QUESTIONS OR ADDRESS COMMENTS ON THE STORMTECH CHAMBER SYSTEM AND INFORM THE INSTALLING CONTRACTOR OF THE MINIMUM INSTALLATION REQUIREMENTS BEFORE BEGINNING THE SYSTEM'S CONSTRUCTION. CALL 860-529-8188 TO SPEAK TO A TECHNICAL SERVICE REPRESENTATIVE OR VISIT

WWW.STORMTECH.COM TO RECEIVE A COPY

- OF OUR INSTALLATION INSTRUCTIONS. 3. STORMTECH'S REQUIREMENTS FOR SYSTEMS WITH PAVEMENT DESIGN (ASPHALT, CONCRETE PAVERS, ETC.): MINIMUM COVER IS 24 INCHES NOT INCLUDING PAVEMENT; MAXIMUM COVER IS 6.5 FEET INCLUDING PAVEMENT. FOR INSTALLATIONS THAT DO NOT INCLUDE PAVEMENT, WHERE RUTTING FROM VEHICLES MAY OCCUR, MINIMUM REQUIRED COVER IS 24 INCHES, MAXIMUM COVER IS 6.5 FEET.
- MATERIALS BEARING CAPACITIES TO THE DESIGN ENGINEER.

STONE PLACEMENT BETWEEN CHAMBERS ROWS AND AROUND PERIMETER MUST FOLLOW INSTRUCTIONS AS INDICATED IN THE MOST CURRENT VERSION OF STORMTECH'S INSTALLATION INSTRUCTIONS.

PROCTOR DENSITY

- BACKFILLING OVER THE CHAMBERS MUST FOLLOW REQUIREMENTS AS INDICATED IN THE MOST CURRENT VERSION OF STORMTECH'S INSTALLATION INSTRUCTIONS.
- THE CONTRACTOR MUST REFER TO STORMTECH'S INSTALLATION INSTRUCTIONS FOR A TABLE OF ACCEPTABLE VEHICLE LOADS AT VARIOUS DEPTHS OF COVER. THIS INFORMATION IS ALSO AVAILABLE AT STORMTECH'S WEBSITE: WWW.STORMTECH.COM. THE CONTRACTOR IS RESPONSIBLE FOR PREVENTING VEHICLES THAT EXCEED STORMTECH'S REQUIREMENTS FROM TRAVELING ACROSS OR PARKING OVER THE STORMWATER SYSTEM. TEMPORARY FENCING, WARNING TAPE AND APPROPRIATELY LOCATED SIGNS ARE COMMONLY USED TO PREVENT UNAUTHORIZED VEHICLES FROM ENTERING SENSITIVE CONSTRUCTION AREAS.
- THE CONTRACTOR MUST APPLY EROSION AND SEDIMENT CONTROL MEASURES TO PROTECT THE STORMWATER SYSTEM DURING ALL PHASES OF SITE CONSTRUCTION PER LOCAL CODES AND DESIGN ENGINEER'S SPECIFICATIONS.
- 4. THE CONTRACTOR MUST REPORT ANY 10. STORMTECH PRODUCT WARRANTY IS LIMITED. DISCREPANCIES WITH CHAMBER FOUNDATION CONTACT STORMTECH FOR WARRANTY
- AASHTO M288 CLASS 2 NON-WOVEN GEOTEXTILE (FILTER FABRIC) MUST BE USED AS INDICATED IN THE PROJECT PLANS.

(SEE DETAIL) 4" LOAM AND -EMERG. OVERFLOW SEED TOP OF ISLAND -36" ORIFICE BERM WITH TRASH RACK HIGH MARSH SEDIMENT (LESS THEN 6" WATER DEPTH) SEE CBCS DETAIL FOREBAY THIS SHEET BOTTOM PERMANENT POOL 3 (MAX.) ~~ 4' W x 10' L x 1.30' GABION BASKET TO -HDPE OUT IMPERMEABLE ---BE EMBEDDED IN LOW MARSH EARTHEN BERM (6" TO 18" WATER DEPTH) SHALLOW WETLAND POND DETAIL NOT TO SCALE DESIGN CONSIDERATIONS

DO NOT PLACE RAIN GARDEN AREAS INTO SERVICE UNTIL IT HAS BEEN PLANTED AND ITS CONTRIBUTING AREAS HAVE BEEN FULLY STABILIZED.

- 2. DO NOT DISCHARGE SEDIMENT-LADEN WATERS FROM CONSTRUCTION ACTIVITIES (RUN-OFF. WATER FROM EXCAVATIONS) TO THE RAIN GARDEN AREA DURING ANY STAGE OF CONSTRUCTION.
- 3. DO NOT TRAFFIC EXPOSED SOIL SURFACE WITH CONSTRUCTION EQUIPMENT. IF FEASIBLE, PERFORM EXCAVATIONS WITH EQUIPMENT OUTSIDE THE LIMITS OF THE RAIN GARDEN COMPONENTS OF THE SYSTEM.

MAINTENANCE REQUIREMENTS:

INFILTRATION BASIN DETAIL

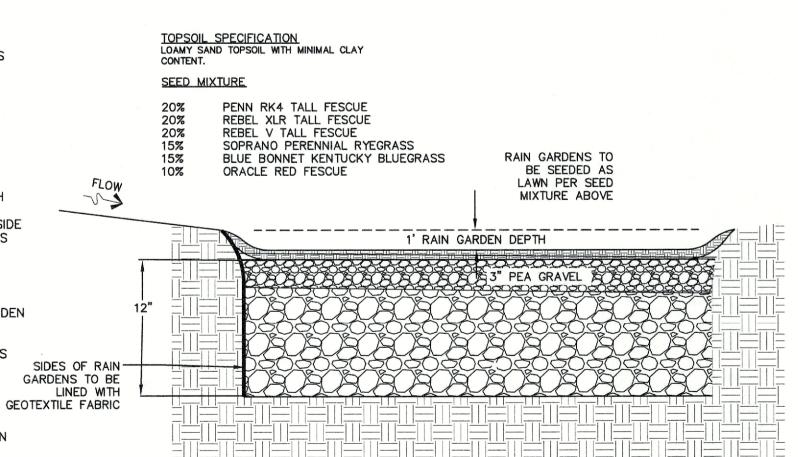
- HOMEOWNERS SHOULD INSPECT THE RAIN GARDEN AFTER LARGE STORMS TO ENSURE THAT NO CHANNELS HAVE FORMED AND THAT ANY PLANTINGS ARE HEALTHY. TRASH AND DEBRIS SHOULD BE REMOVED AT EACH INSPECTION.
- AREAS AND SHOULD MOWED REGULARLY.

5. RAIN GARDEN AREAS TO REMAIN AS LAWN

6. NO BUSHES OR TREES SHOULD BE PLANTED IN THIS AREA, AREA TO REMAIN AS GRASS.

RAIN GARDEN #1

NOT TO SCALE



TYPICAL SC-740 CROSS-SECTION

CONCRETE COLLAR-

PAVEMENT -

CONCRETE SLAB

8" MIN. THICKNESS

FLEXSTORM CATCH IT-

4" INSERTA TEE-

TYPICAL SC-740 4" INSPECTION PORT

SC-740 END CAP-

-AASHTO M288 CLASS 2

NON-WOVEN GEOTEXTILE ALL AROUND ANGULAR STONE

INSERTA TEE TO BE

OF CORRUGATION

CENTERED IN VALLET

NOT TO SCALE

W/ USE OF OPEN GRATE

NOT TO SCALE



- 1. SC-740 CHAMBERS SHALL CONFORM TO THE REQUIREMENTS OF ASTM F2418 "STANDARD SPECIFICATION FOR POLYPROPYLENE (PP) CORRUGATED WALL STORMWATER COLLECTION CHAMBERS".
- 2. SC-740 CHAMBERS SHALL BE DESIGNED IN ACCORDANCE WITH ASTM F2787 "STANDARD PRACTICE FOR STRUCTURAL DESIGN OF THERMOPLASTIC CORRUGATED WALL STORMWATER COLLECTION CHAMBERS".
- 3. "ACCEPTABLE FILL MATERIALS" TABLE ABOVE PROVIDES MATERIAL LOCATIONS, DESCRIPTIONS, GRADATIONS, AND COMPACTION REQUIREMENTS FOR FOUNDATION, EMBEDMENT, AND FILL MATERIALS.
- 4. THE SITE DESIGN ENGINEER IS RESPONSIBLE FOR ASSESSING THE BEARING RESISTANCE (ALLOWABLE BEARING CAPACITY) OF THE SUBGRADE SOILS AND THE DEPTH OF FOUNDATION STONE WITH CONSIDERATION FOR THE RANGE OF EXPECTED SOIL MOISTURE
- PERIMETER STONE MUST BE EXTENDED HORIZONTALLY TO THE EXCAVATION WALL FOR BOTH VERTICAL AND SLOPED EXCAVATION
- 5. ONCE LAYER 'C' IS PLACED, ANY SOIL/MATERIAL CAN BE PLACED IN LAYER 'D' UP TO THE FINISHED GRADE. MOST PAVEMENT SUBBASE SOILS CAN BE USED TO REPLACE THE MATERIAL REQUIREMENTS OF LAYER 'C' OR 'D' AT THE SITE DESIGN ENGINEER'S DISCRETION.

Design: EMP | Draft: EJH Date: 05/23/2023 Checked: EMP | Scale: AS SHOWN | Project No.: 21173 Drawing Name: 21173.1-PHASE2-PLAN.DWG

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Civil Engineering Services 603-772-4746 85 Portsmouth Ave. E-MAIL: JBE@JONESANDBEACH.COM PO Box 219, Stratham, NH 03885

DETAIL SHEET Plan Name:

Project:

Owner of

Record:

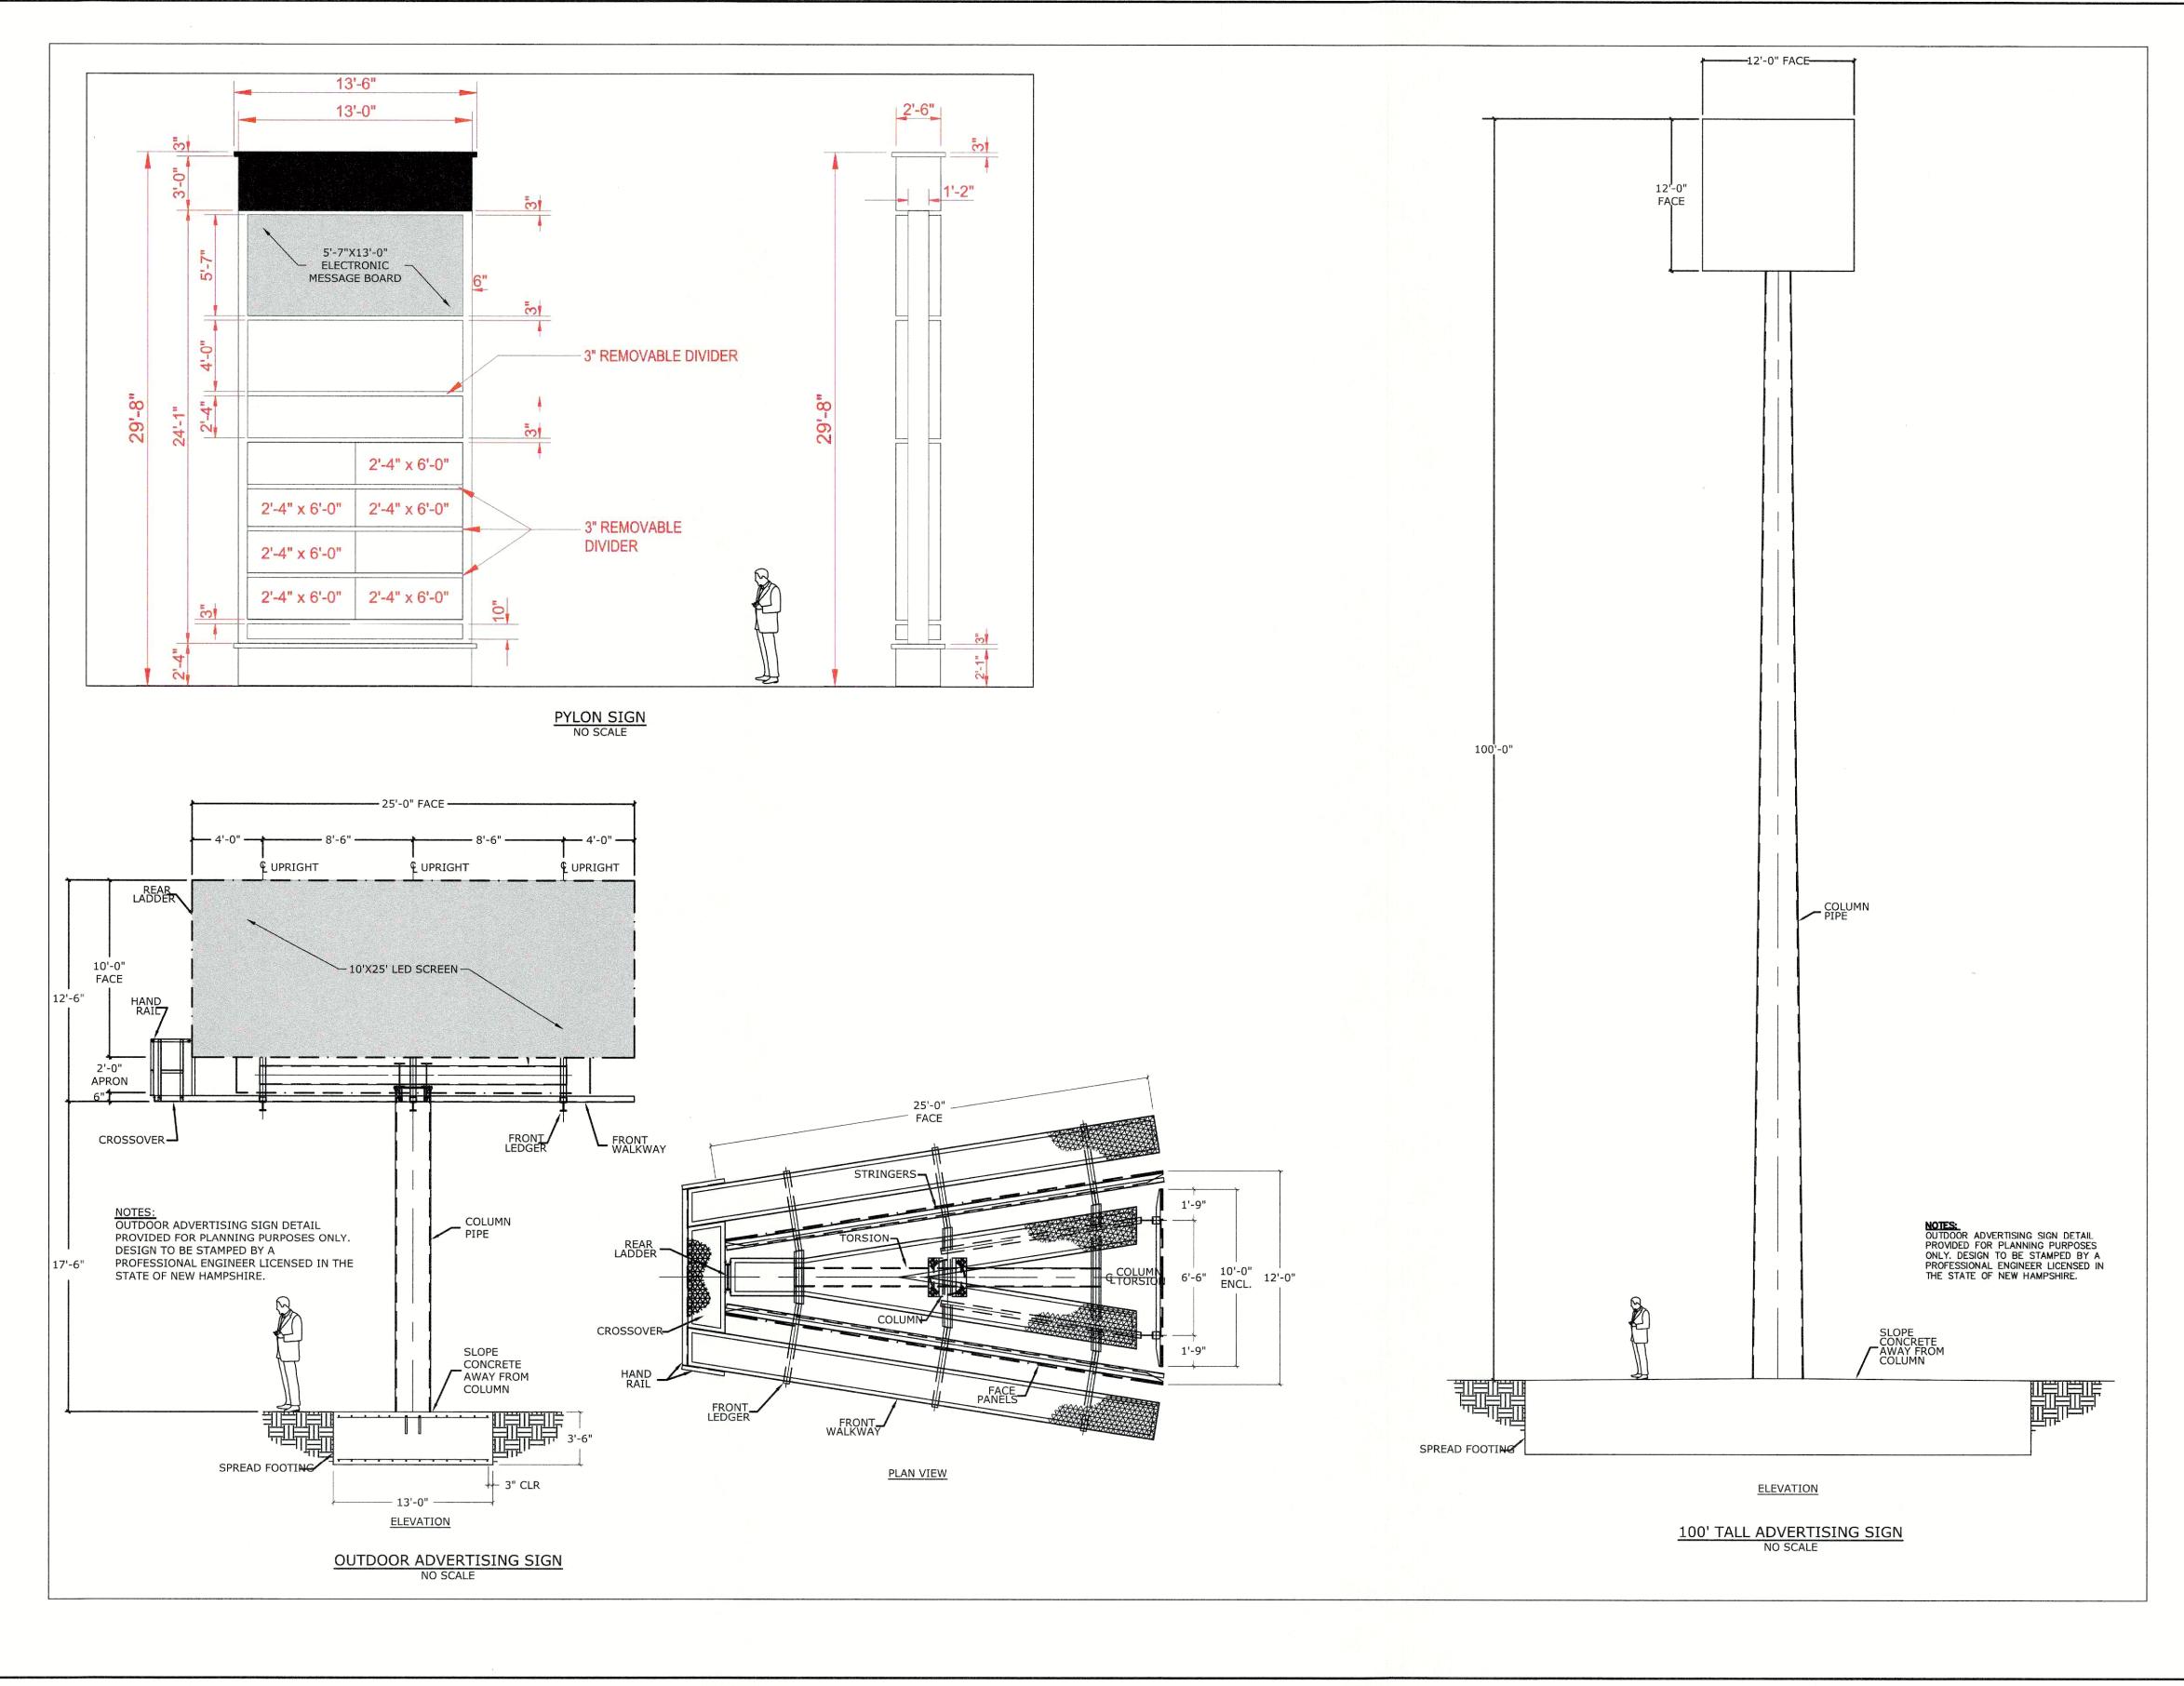
FARMINGTON ASSOCIATES PROPERTIES, LLC MARKETPLACE BLVD, ROCHESTER, NH

FARMINGTON ASSOCIATES PROPERTIES, LLC 322

RESERVOIR ST, NEEDHAM, MA 02494

DRAWING No.

SHEET NO. 18 OF 21 JBE PROJECT NO. 21173



| Design: EMP | Draft: EJH | Date: 05/23/2023 |
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| Checked: EMP | Scale: AS SHOWN | Project No.: 21173 |
| Drawing Name: | 21173.1-PHASE2-PLAI | N.DWG |
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B Jones & Beach Engineers, Inc. Civil Engineering Services

Civil Engineering Services
85 Portsmouth Ave.
PO Box 219, Stratham, NH 03885

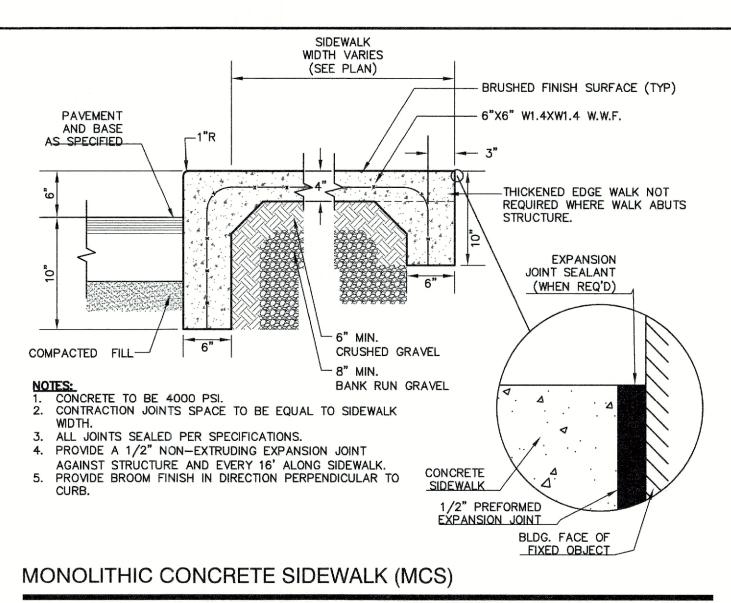
Civil Engineering Services
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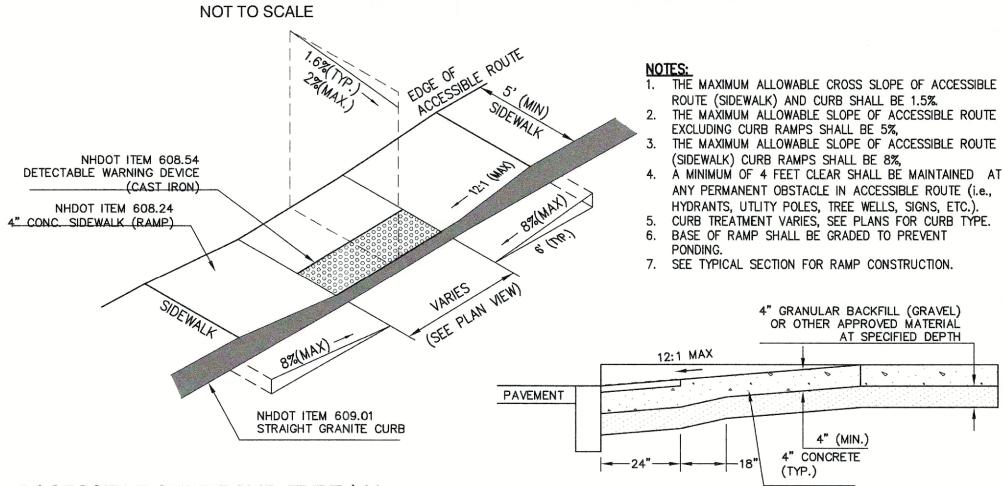
| Plan Name: | DETAIL SHEET |
|---------------------|--|
| Project: | FARMINGTON ASSOCIATES PROPERTIES, LLC MARKETPLACE BLVD, ROCHESTER, NH |
| Owner of Record: | FARMINGTON ASSOCIATES PROPERTIES, LLC 322 RESERVOIR ST, NEEDHAM, MA 02494 |

DRAWING No.

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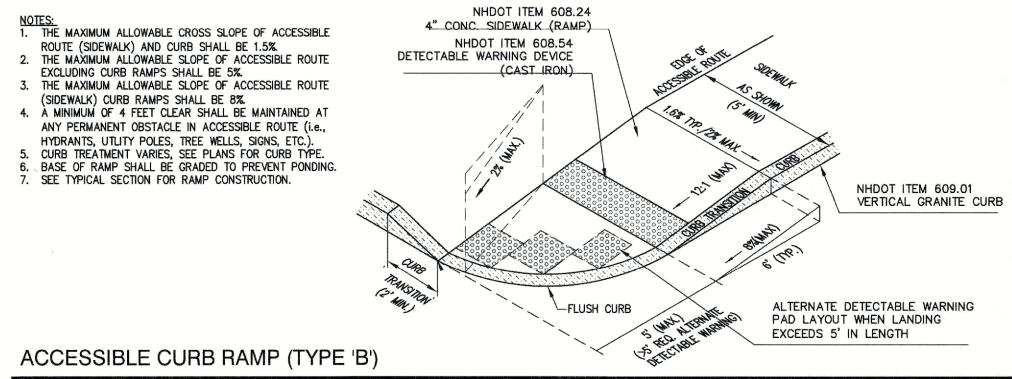
SHEET NO. 19 OF 21
JBE PROJECT NO. 21173



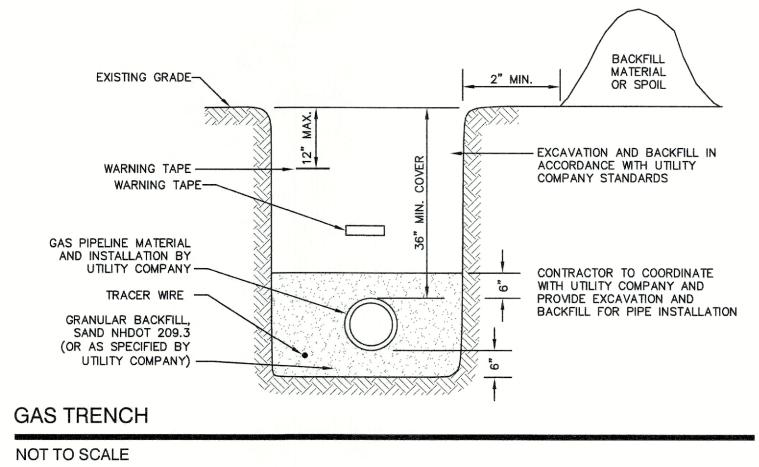


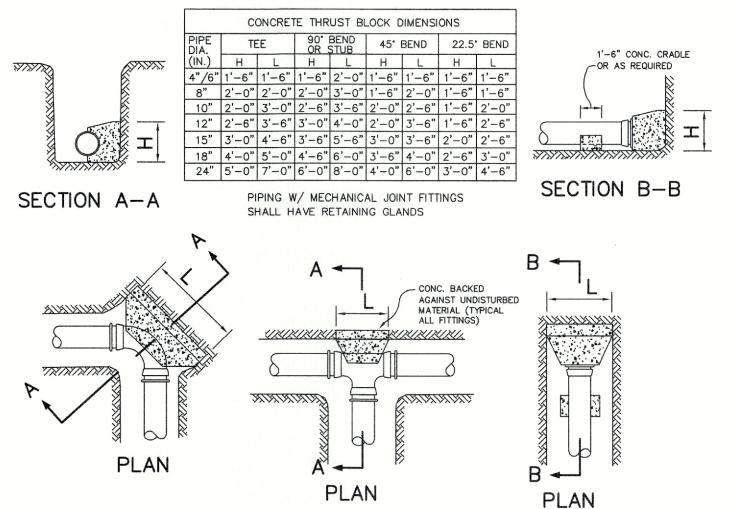
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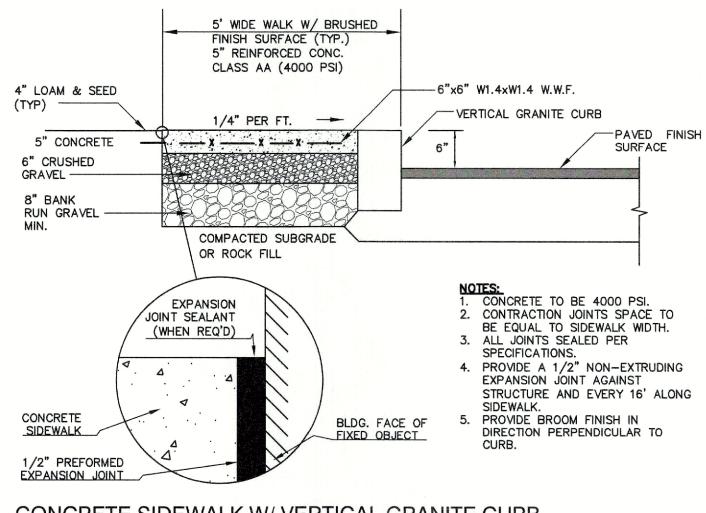
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THRUST BLOCK DETAILS

NOT TO SCALE




CONCRETE SIDEWALK W/ VERTICAL GRANITE CURB

NOT TO SCALE

| Design: EMP | Draft: EJH | Date: 05/23/2023 |
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| Checked: EMP | Scale: AS SHOWN | Project No.: 21173 |
| Drawing Name: | 21173.1-PHASE2-PLAI | N.DWG |
| THIS PLAN SHALL | NOT BE MODIFIED WITH | OUT WRITTEN |
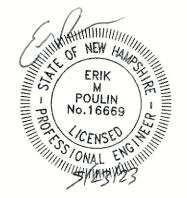
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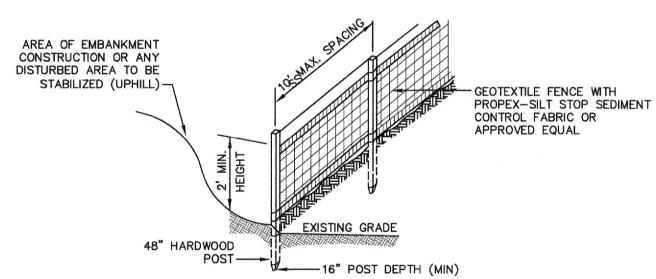
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| \mathbb{Z}/\mathbb{R} | Jones | & | Beach | Engineers, | Inc. |
| 85 Portsmouth A | Civil | En | ngineering | Services 603 | 3-772-4746 |
| | atham, NH 03885 | | | E-MAIL: JBE@JONESANDBE | ACH.COM |

| Plan Name: | DETAIL SHEET |
|------------------|--|
| Project: | FARMINGTON ASSOCIATES PROPERTIES, LLC MARKETPLACE BLVD, ROCHESTER, NH |
| Owner of Record: | FARMINGTON ASSOCIATES PROPERTIES, LLC 322 RESERVOIR ST, NEEDHAM, MA 02494 |

DRAWING No. SHEET NO. 20 OF 21 JBE PROJECT NO. 21173

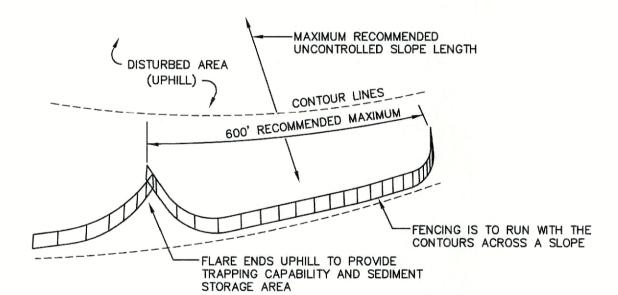
TEMPORARY EROSION CONTROL NOTES

- THE SMALLEST PRACTICAL AREA OF LAND SHALL BE EXPOSED AT ANY ONE TIME. AT NO TIME SHALL AN AREA IN EXCESS OF 5 ACRES BE EXPOSED AT ANY ONE TIME BEFORE DISTURBED AREAS ARE STABILIZED.
- EROSION, SEDIMENT AND DETENTION MEASURES SHALL BE INSTALLED AS SHOWN ON THE PLANS AND AT LOCATIONS AS REQUIRED, DIRECTED BY THE ENGINEER.
- 3. ALL DISTURBED AREAS (INCLUDING POND AREAS BELOW THE PROPOSED WATERLINE) SHALL BE RETURNED TO PROPOSED GRADES AND ELEVATIONS. DISTURBED AREAS SHALL BE LOAMED WITH A MINIMUM OF 6" OF SCREENED ORGANIC LOAM AND SEEDED WITH SEED MIXTURE 'C' AT A RATE NOT LESS THAN 1.10 POUNDS OF SEED PER 1,000 S.F. OF AREA (48 LBS. / ACRE).
- 4. SILT FENCES AND OTHER BARRIERS SHALL BE INSPECTED EVERY SEVEN CALENDAR DAYS AND WITHIN 24 HOURS OF A RAINFALL OF 0.5" OR GREATER. ALL DAMAGED AREAS SHALL BE REPAIRED, AND SEDIMENT DEPOSITS SHALL PERIODICALLY BE REMOVED
- AFTER ALL DISTURBED AREAS HAVE BEEN STABILIZED, THE TEMPORARY EROSION CONTROL MEASURES SHALL BE REMOVED AND THE AREA DISTURBED BY THE REMOVAL SMOOTHED AND RE-VEGETATED.
- AREAS MUST BE SEEDED AND MULCHED OR OTHERWISE PERMANENTLY STABILIZED WITHIN 3 DAYS OF FINAL GRADING, OR TEMPORARILY STABILIZED WITHIN 14 DAYS OF THE INITIAL DISTURBANCE OF SOIL. ALL AREAS SHALL BE STABILIZED WITHIN 45
- ALL PROPOSED VEGETATED AREAS THAT DO NOT EXHIBIT A MINIMUM OF 85 PERCENT VEGETATIVE GROWTH BY OCTOBER 15, OR WHICH ARE DISTURBED AFTER OCTOBER 15, SHALL BE STABILIZED BY SEEDING AND INSTALLING NORTH AMERICAN GREEN S75 EROSION CONTROL BLANKETS (OR AN EQUIVALENT APPROVED IN WRITING BY THE ENGINEER) ON SLOPES GREATER THAN 3:1. AND SEEDING AND PLACING 3 TO 4 TONS OF MULCH PER ACRE, SECURED WITH ANCHORED NETTING, ELSEWHERE. THE INSTALLATION OF EROSION CONTROL BLANKETS OR MULCH AND NETTING SHALL NOT OCCUR OVER ACCUMULATED SNOW OR ON FROZEN GROUND AND SHALL BE COMPLETED IN ADVANCE OF THAW OR SPRING MELT EVENTS.
- 8. ALL DITCHES OR SWALES WHICH DO NOT EXHIBIT A MINIMUM OF 85 PERCENT VEGETATIVE GROWTH BY OCTOBER 15, OR WHICH ARE DISTURBED AFTER OCTOBER 15, SHALL BE STABILIZED TEMPORARILY WITH STONE OR EROSION CONTROL BLANKETS APPROPRIATE FOR THE DESIGN FLOW CONDITIONS.
- AFTER OCTOBER 15th, INCOMPLETE ROAD OR PARKING SURFACES, WHERE WORK HAS STOPPED FOR THE WINTER SEASON, SHALL BE PROTECTED WITH A MINIMUM OF 3" OF CRUSHED GRAVEL PER NHDOT ITEM 304.3.
- 10. AN AREA SHALL BE CONSIDERED STABLE IF ONE OF THE FOLLOWING HAS OCCURRED:
 - a. BASE COURSE GRAVELS HAVE BEEN INSTALLED IN AREAS TO BE PAVED;
 - b. A MINIMUM OF 85% VEGETATED GROWTH HAS BEEN ESTABLISHED;
 - c. A MINIMUM OF 3" OF NON-EROSIVE MATERIAL SUCH STONE OR RIPRAP HAS BEEN INSTALLED; OR
 - d. EROSION CONTROL BLANKETS HAVE BEEN PROPERLY INSTALLED.
- 11. FUGITIVE DUST CONTROL IS REQUIRED TO BE CONTROLLED IN ACCORDANCE WITH ENV-A 1000, AND THE PROJECT IS TO MEET
- THE REQUIREMENTS AND INTENT OF RSA 430:53 AND AGR 3800 RELATIVE TO INVASIVE SPECIES.
- 12. PRIOR TO BEGINNING CONSTRUCTION, THE CONTRACTOR'S NAME, ADDRESS, AND PHONE NUMBER SHALL BE SUBMITTED TO DES
- 13. PRIOR TO CONSTRUCTION, A PHASING PLAN THAT DELINEATES EACH PHASE OF THE PROJECT SHALL BE SUBMITTED. ALL TEMPORARY SEDIMENT BASINS THAT WILL BE NEEDED FOR DEWATERING WORK AREAS SHALL BE LOCATED AND IDENTIFIED ON THIS
- 14. IN ORDER TO ENSURE THE STABILITY OF THE SITE AND EFFECTIVE IMPLEMENTATION OF THE SEDIMENT AND EROSION CONTROL MEASURES SPECIFIED IN THE PLANS FOR THE DURATION OF CONSTRUCTION, THE CONTRACTOR SHALL BE IN STRICT COMPLIANCE WITH THE FOLLOWING INSPECTION AND MAINTENANCE REQUIREMENTS IN ADDITION TO THOSE CALLED FOR IN THE SWPPP:
 - a. A CERTIFIED PROFESSIONAL IN EROSION AND SEDIMENT CONTROL OR A PROFESSIONAL ENGINEER LICENSED IN THE STATE OF NEW HAMPSHIRE ("MONITOR") SHALL BE EMPLOYED TO INSPECT THE SITE FROM THE START OF ALTERATION OF TERRAIN ACTIVITIES UNTIL THE SITE IS IN FULL COMPLIANCE WITH THE SITE SPECIFIC PERMIT ("PERMIT").
 - b. DURING THIS PERIOD, THE MONITOR SHALL INSPECT THE SUBJECT SITE AT LEAST ONCE A WEEK, AND IF POSSIBLE, DURING ANY 1/2 INCH OR GREATER RAIN EVENT (I.E. 1/2 INCH OF PRECIPITATION OR MORE WITHIN A 24 HOUR PERIOD). IF UNABLE TO BE PRESENT DURING SUCH A STORM, THE MONITOR SHALL INSPECT THE SITE WITHIN 24 HOURS OF THIS
 - c. THE MONITOR SHALL PROVIDE TECHNICAL ASSISTANCE AND RECOMMENDATIONS TO THE CONTRACTOR ON THE APPROPRIATE BEST MANAGEMENT PRACTICES FOR EROSION AND SEDIMENT CONTROLS REQUIRED TO MEET THE REQUIREMENTS OF RSA 485 A:17 AND ALL APPLICABLE DES PERMIT CONDITIONS.
 - d. WITHIN 24 HOURS OF EACH INSPECTION, THE MONITOR SHALL SUBMIT A REPORT TO DES VIA EMAIL (RIDGELY MAUCK AT: RIDGELY.MAUCK@DES.NH.GOV)
 - e. THE MONITOR SHALL MEET WITH DES TO DECIDE UPON A REPORT FORMAT. THE REPORT FORMAT SHALL BE REVIEWED AND APPROVED BY DES PRIOR TO THE START OF CONSTRUCTION.



CONSTRUCTION SPECIFICATIONS:

- . WOVEN FABRIC FENCE TO BE FASTENED SECURELY TO FENCE POSTS WITH WIRE TIES OR STAPLES. FILTER CLOTH SHALL BE FASTENED TO WOVEN WIRE EVERY 24" AT TOP, MID AND BOTTOM AND EMBEDDED IN THE GROUND A MINIMUM OF 8" AND THEN COVERED WITH SOIL.
- 2. THE FENCE POSTS SHALL BE A MINIMUM OF 48" LONG, SPACED A MAXIMUM 10' APART, AND DRIVEN A MINIMUM OF 16" INTO THE GROUND.
- 3. WHEN TWO SECTIONS OF FILTER CLOTH ADJOIN EACH OTHER, THE ENDS OF THE FABRIC SHALL BE OVERLAPPED 6", FOLDED AND STAPLED TO PREVENT SEDIMENT FROM BY-PASSING.
- I. MAINTENANCE SHALL BE PERFORMED AS NEEDED AND SEDIMENT REMOVED AND PROPERLY DISPOSED OF WHEN IT IS 6" DEEP OR VISIBLE 'BULGES' DEVELOP IN THE SILT FENCE.
- 5. PLACE THE ENDS OF THE SILT FENCE UP CONTOUR TO PROVIDE FOR SEDIMENT STORAGE.
- 6. SILT FENCE SHALL REMAIN IN PLACE FOR 24 MONTHS.



7. SILT FENCES SHALL BE REMOVED WHEN NO LONGER NEEDED AND THE SEDIMENT COLLECTED SHALL BE DISPOSED AS DIRECTED BY THE ENGINEER. THE AREA DISTURBED BY THE REMOVAL SHALL BE SMOOTHED AND REVEGETATED.

MAINTENANCE:

- 1. SILT FENCES SHALL BE INSPECTED IMMEDIATELY AFTER EACH RAINFALL AND AT LEAST DAILY DURING PROLONGED RAINFALL. ANY REPAIRS THAT ARE REQUIRED SHALL BE DONE IMMEDIATELY.
- 2. IF THE FABRIC ON A SILT FENCE SHOULD DECOMPOSE OR BECOME INEFFECTIVE DURING THE EXPECTED LIFE OF THE FENCE, THE FABRIC SHALL BE REPLACED PROMPTLY.
- 3. SEDIMENT DEPOSITS SHOULD BE INSPECTED AFTER EVERY STORM EVENT. THE DEPOSITS SHOULD BE
- REMOVED WHEN THEY REACH APPROXIMATELY ONE HALF THE HEIGHT OF THE BARRIER.
- 4. SEDIMENT DEPOSITS THAT ARE REMOVED, OR LEFT IN PLACE AFTER THE FABRIC HAS BEEN REMOVED, SHALL BE GRADED TO CONFORM WITH THE EXISTING TOPOGRAPHY AND VEGETATED.

SEEDING SPECIFICATIONS GRADING AND SHAPING

- A. SLOPES SHALL NOT BE STEEPER THAN 2:1 WITHOUT APPROPRIATE EROSION CONTROL MEASURES AS
- SPECIFIED ON THE PLANS (3:1 SLOPES OR FLATTER ARE PREFERRED) B. WHERE MOWING WILL BE DONE, 3:1 SLOPES OR FLATTER ARE RECOMMENDED.

2. <u>SEEDBED PREPARATION</u> A. SURFACE AND SEEPAGE WATER SHOULD BE DRAINED OR DIVERTED FROM THE SITE TO PREVENT DROWNING

OR WINTER KILLING OF THE PLANTS. B. STONES LARGER THAN 4 INCHES AND TRASH SHOULD BE REMOVED BECAUSE THEY INTERFERE WITH SEEDING AND FUTURE MAINTENANCE OF THE AREA. WHERE FEASIBLE, THE SOIL SHOULD BE TILLED TO A DEPTH OF ABOUT 4 INCHES TO PREPARE A SEEDBED AND FERTILIZER AND LIME MIXED INTO THE SOIL. THE SEEDBED SHOULD BE LEFT IN A REASONABLY FIRM AND SMOOTH CONDITION. THE LAST TILLAGE OPERATION SHOULD BE PERFORMED ACROSS THE SLOPE WHEREVER PRACTICAL.

3. <u>ESTABLISHING A STAND</u>

A. LIME AND FERTILIZER SHOULD BE APPLIED PRIOR TO OR AT THE TIME OF SEEDING AND INCORPORATED INTO THE SOIL. TYPES AND AMOUNTS OF LIME AND FERTILIZER SHOULD BE BASED ON AN EVALUATION OF SOIL TESTS. WHEN A SOIL TEST IS NOT AVAILABLE, THE FOLLOWING MINIMUM AMOUNTS SHOULD BE

AGRICULTURAL LIMESTONE, 2 TONS PER ACRE OR 100 LBS. PER 1,000 SQ.FT. NITROGEN(N), 50 LBS. PER ACRE OR 1.1 LBS. PER 1,000 SQ.FT.

PHOSPHATE(P205), 100 LBS. PER ACRE OR 2.2 LBS. PER 1,000 SQ.FT. POTASH(K20), 100 LBS. PER ACRE OR 2.2 LBS. PER 1,000 SQ.FT.

(NOTE: THIS IS THE EQUIVALENT OF 500 LBS. PER ACRE OF 10-20-20 FERTILIZER OR 1,000 LBS. PER ACRE OF 5-10-10.)

- B. SEED SHOULD BE SPREAD UNIFORMLY BY THE METHOD MOST APPROPRIATE FOR THE SITE. METHODS INCLUDE BROADCASTING, DRILLING AND HYDROSEEDING. WHERE BROADCASTING IS USED, COVER SEED WITH .25 INCH OF SOIL OR LESS, BY CULTIPACKING OR RAKING.
- C. REFER TO THE 'SEEDING GUIDE' AND 'SEEDING RATES' TABLES ON THIS SHEET FOR APPROPRIATE SEED MIXTURES AND RATES OF SEEDING. ALL LEGUMES (CROWNVETCH, BIRDSFOOT, TREFOIL AND FLATPEA)
- MUST BE INOCULATED WITH THEIR SPECIFIC INOCULANT PRIOR TO THEIR INTRODUCTION TO THE SITE. D. WHEN SEEDED AREAS ARE MULCHED, PLANTINGS MAY BE MADE FROM EARLY SPRING TO EARLY OCTOBER. WHEN SEEDED AREAS ARE NOT MULCHED, PLANTINGS SHOULD BE MADE FROM EARLY SPRING TO MAY 20th OR FROM AUGUST 10th TO SEPTEMBER 1st.

A. HAY, STRAW, OR OTHER MULCH, WHEN NEEDED, SHOULD BE APPLIED IMMEDIATELY AFTER SEEDING.
B. MULCH WILL BE HELD IN PLACE USING APPROPRIATE TECHNIQUES FROM THE BEST MANAGEMENT PRACTICE FOR MULCHING. HAY OR STRAW MULCH SHALL BE PLACED AT A RATE OF 90 LBS PER 1000 S.F.

5. MAINTENANCE TO ESTABLISH A STAND A. PLANTED AREAS SHOULD BE PROTECTED FROM DAMAGE BY FIRE, GRAZING, TRAFFIC, AND DENSE WEED

- B. FERTILIZATION NEEDS SHOULD BE DETERMINED BY ONSITE INSPECTIONS. SUPPLEMENTAL FERTILIZER IS USUALLY THE KEY TO FULLY COMPLETE THE ESTABLISHMENT OF THE STAND BECAUSE MOST PERENNIALS
- TAKE 2 TO 3 YEARS TO BECOME FULLY ESTABLISHED. C. IN WATERWAYS, CHANNELS, OR SWALES WHERE UNIFORM FLOW CONDITIONS ARE ANTICIPATED, ANNUAL MOWING MAY BE NECESSARY TO CONTROL GROWTH OF WOODY VEGETATION.

| USE | SEEDING MIXTURE 1/ | DROUGHTY | WELL DRAINED | MODERATELY WELL DRAINED | POORLY DRAINED |
|---|-----------------------|----------------------|---------------------------|-------------------------------|----------------------|
| STEEP CUTS AND FILLS, BORROW AND DISPOSAL AREAS | A B C | FAIR POOR POOR | GOOD GOOD GOOD | GOOD FAIR EXCELLENT | FAIR FAIR GOOD |
| NILAS | D | FAIR | EXCELLENT | EXCELLENT | POOR |
| WATERWAYS, EMERGENC SPILLWAYS, AND OTHER CHANNELS WITH FLOWING WATER. | | GOOD GOOD | GOOD EXCELLENT | GOOD EXCELLENT | FAIR FAIR |
| LIGHTLY USED PARKING LOTS, ODD AREAS, UNUSED LANDS, AND LOW INTENSITY USE RECREATION SITES. | A B C | GOOD GOOD GOOD | GOOD GOOD EXCELLENT | GOOD FAIR EXCELLENT | FAIR POOR FAIR |
| PLAY AREAS AND ATHLETIC FIELDS. (TOPSOIL IS ESSENTIAL FOR GOOD TURF.) | E F | FAIR FAIR | EXCELLENT EXCELLENT | EXCELLENT EXCELLENT | <u>2/</u> 2/ |

GRAVEL PIT, SEE NH-PM-24 IN APPENDIX FOR RECOMMENDATION REGARDING RECLAMATION OF SAND AND GRAVEL PITS. REFER TO SEEDING MIXTURES AND RATES IN TABLE BELOW.

NOTE: TEMPORARY SEED MIX FOR STABILIZATION OF TURF SHALL BE WINTER RYE OR OATS AT A RATE OF 2.5 LBS. PER 1000 S.F. AND SHALL BE PLACED PRIOR TO OCTOBER 15th, IF PERMANENT SEEDING NOT YET COMPLETE.

SEEDING GUIDE

27 POORLY DRAINED SOILS ARE NOT DESIRABLE FOR USE AS PLAYING AREA AND ATHLETIC FIELDS.

| MIXTURE | POUNDS PER ACRE | POUNDS PER 1.000 Sq. Ft | | | | |
|--|----------------------------|-------------------------------------|--|--|--|--|
| A. TALL FESCUE CREEPING RED FESCUE RED TOP TOTAL | 20 20 2 42 | 0.45 0.45 0.05 0.95 | | | | |
| B. TALL FESCUE CREEPING RED FESCUE CROWN VETCH OR | 15 10 15 | 0.35 0.25 0.35 | | | | |
| FLAT PEA TOTAL | 30 40 OR 55 | 0.75 0.95 OR 1.35 | | | | |
| C. TALL FESCUE CREEPING RED FESCUE BIRDS FOOT TREFOIL TOTAL | 20 20 <u>8</u> 48 | 0.45 0.45 <u>0.20</u> 1.10 | | | | |
| D. TALL FESCUE FLAT PEA TOTAL | 20 30 50 | 0.45 <u>0.75</u> 1.20 | | | | |
| E. CREEPING RED FESCUE 1/ KENTUCKY BLUEGRASS 1/ TOTAL | 50 50 100 | 1.15 1.15 2.30 | | | | |
| F. TALL FESCUE 1 | 150 | 3.60 | | | | |
| 1/FOR HEAVY USE ATHLETIC FIELDS CONSULT THE UNIVERSITY OF NEW HAMPSHIRE COOPERATIVE EXTENSION TURF SPECIALIST FOR CURRENT VARIETIES AND SEEDING RATES. | | | | | | |

SEEDING RATES

E-MAIL: JBE@JONESANDBEACH.COM

CONSTRUCTION SEQUENCE

- . PRIOR TO THE START OF ANY ACTIVITY, IT IS THE RESPONSIBILITY OF THE SITE'S SITE DEVELOPER (OR OWNER) TO FILE A NOTICE OF INTENT (NOI) FORM WITH THE ENVIRONMENTAL PROTECTION AGENCY (EPA) IN ORDER TO GAIN COVERAGE UNDER THE NPDES GENERAL PERMIT FOR STORM WATER DISCHARGES FROM CONSTRUCTION ACTIVITIES. A PRE CONSTRUCTION MEETING IS TO BE HELD WITH ALL DEPARTMENT HEADS PRIOR TO THE START OF CONSTRUCTION.
- 2. WETLAND BOUNDARIES ARE TO BE CLEARLY MARKED PRIOR TO THE START OF CONSTRUCTION. AT LEAST A TEMPORARY CULVERT OR ROADBED TO BE IN PLACE PRIOR TO THE START OF CONSTRUCTION.
- CUT AND REMOVE TREES IN CONSTRUCTION AREA AS REQUIRED OR DIRECTED.
- 4. INSTALL SILT FENCING. HAY BALES AND CONSTRUCTION ENTRANCES PRIOR TO THE START OF CONSTRUCTION. THESE ARE TO BE MAINTAINED UNTIL THE FINAL PAVEMENT SURFACING AND LANDSCAPING AREAS ARE ESTABLISHED.
- 5. CLEAR, CUT, GRUB AND DISPOSE OF DEBRIS IN APPROVED FACILITIES. THIS INCLUDES ANY REQUIRED DEMOLITION OF EXISTING STRUCTURES, UTILITIES, ETC.
- 6. CONSTRUCT AND/OR INSTALL TEMPORARY OR PERMANENT SEDIMENT AND/OR DETENTION BASIN(S) AS REQUIRED. THESE FACILITIES SHALL BE INSTALLED AND STABILIZED PRIOR TO DIRECTING RUN-OFF TO THEM.
- STRIP LOAM AND PAVEMENT, OR RECLAIM EXISTING PAVEMENT WITHIN LIMITS OF WORK PER THE RECOMMENDATIONS OF THE PROJECT ENGINEER AND STOCKPILE EXCESS MATERIAL. STABILIZE STOCKPILE AS NECESSARY.
- 8. PERFORM PRELIMINARY SITE GRADING IN ACCORDANCE WITH THE PLANS, INCLUDING THE CONSTRUCTION OF ANY RETAINING WALLS AND SOUND WALLS.
- PREPARE BUILDING PAD(S) TO ENABLE BUILDING CONSTRUCTION TO BEGIN.
- 10. INSTALL THE SEWER AND DRAINAGE SYSTEMS FIRST, THEN ANY OTHER UTILITIES IN ACCORDANCE WITH THE PLAN AND DETAILS. ANY CONFLICTS BETWEEN UTILITIES ARE TO BE RESOLVED WITH THE INVOLVEMENT AND APPROVAL OF THE ENGINEER.
- 11. INSTALL INLET PROTECTION AT ALL CATCH BASINS AS THEY ARE CONSTRUCTED IN ACCORDANCE WITH DETAILS.
- 12. ALL SWALES AND DRAINAGE STRUCTURES ARE TO BE CONSTRUCTED AND STABILIZED PRIOR TO HAVING RUN-OFF DIRECTED TO THEM.
- 13. DAILY, OR AS REQUIRED, CONSTRUCT TEMPORARY BERMS, DRAINAGE DITCHES, CHECK DAMS, SEDIMENT TRAPS, ETC., TO PREVENT EROSION ON THE SITE AND PREVENT ANY SILTATION OF ABUTTING WATERS AND/OR PROPERTY.
- 14. PERFORM FINAL FINE GRADING, INCLUDING PLACEMENT OF 'SELECT' SUBGRADE MATERIALS.
- 15. PAVE ALL PARKING LOTS AND ROADWAYS WITH INITIAL 'BASE COURSE'.
- PERFORM ALL REMAINING SITE CONSTRUCTION (i.e. BUILDING, CURBING, UTILITY CONNECTIONS, ETC.).
- 17. LOAM AND SEED ALL DISTURBED AREAS AND INSTALL ANY REQUIRED SEDIMENT AND EROSION CONTROL FACILITIES (i.e. RIP RAP, EROSION CONTROL BLANKETS, ETC.).
- 18. FINISH PAVING ALL ROADWAYS AND PARKING AREAS WITH 'FINISH' COURSE.
- 19. ALL ROADWAYS AND PARKING LOTS SHALL BE STABILIZED WITHIN 72 HOURS OF ACHIEVING FINISHED GRADE.
- 20. ALL CUT AND FILL SLOPES SHALL BE SEEDED/LOAMED WITHIN 72 HOURS OF ACHIEVING FINISHED GRADE.
- 21. COMPLETE PERMANENT SEEDING AND LANDSCAPING.
- 22. REMOVE TEMPORARY EROSION CONTROL MEASURES AFTER SEEDING AREAS HAVE BEEN 75%-85% ESTABLISHED AND SITE IMPROVEMENTS ARE COMPLETE. SMOOTH AND RE-VEGETATE ALL DISTURBED AREAS.
- 23. CLEAN SITE AND ALL DRAINAGE STRUCTURES, PIPES AND SUMPS OF ALL SILT AND DEBRIS.
- 24. INSTALL ALL PAINTED PAVEMENT MARKINGS AND SIGNAGE PER THE PLANS AND DETAILS.
- 25. ALL EROSION CONTROLS SHALL BE INSPECTED WEEKLY AND AFTER EVERY HALF-INCH OF RAINFALL.
- 26. UPON COMPLETION OF CONSTRUCTION, IT IS THE RESPONSIBILITY OF THE CONTRACTOR TO NOTIFY ANY RELEVANT PERMITTING AGENCIES THAT THE CONSTRUCTION HAS BEEN FINISHED IN A SATISFACTORY MANNER.

Design: EMP Draft: EJH Date: 05/23/2023 Checked: EMP | Scale: AS SHOWN | Project No.: 21173 Drawing Name: 21173.1-PHASE2-PLAN.DWG THIS PLAN SHALL NOT BE MODIFIED WITHOUT WRITTEN


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PO Box 219, Stratham, NH 03885

EROSION & SEDIMENT CONTROL Plan Name:

FARMINGTON ASSOCIATES PROPERTIES, LLC Project: MARKETPLACE BLVD, ROCHESTER, NH FARMINGTON ASSOCIATES PROPERTIES, LLC Owner of 322 RESERVOIR ST, NEEDHAM, MA 02494 Record:

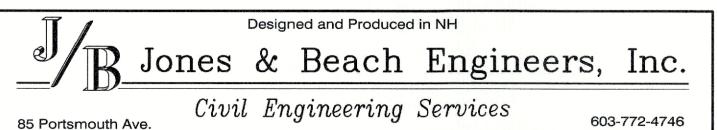DRAWING No.

SHEET NO. 21 OF 2 JBE PROJECT NO. 21173