


PROPOSED 16 LOT SUBDIVISION FOR PRPC DEVELOPMENT GROUP, LLC FOUR ROD ROAD ROCHESTER, N.H.

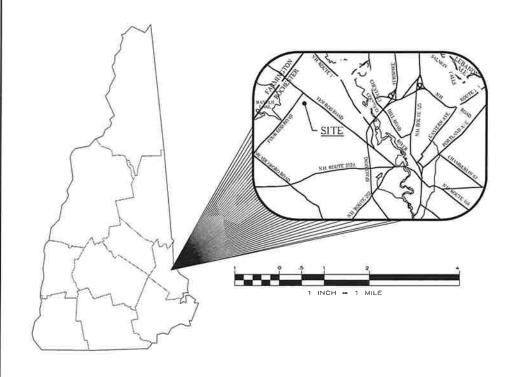

CIVIL ENGINEERS

NORWAY PLAINS ASSOCIATES, INC. 2 CONTINENTAL BOULEVARD ROCHESTER, NEW HAMPSHIRE 03867 (603) 335-3948 OVERALL SITE

1" = 300'


NOV 1 8 2003


DEVELOPER


PRPC DEVELOPMENT GROUP, LLC 64C HORNETOWN ROAD FARMINGTON, NEW HAMPSHIRE 03835 (603) 335-1100


		SHEET INDEX	
ı		COVER	AS SHOWN
١	SHEET S-1	SUBDIVISION OF LAND	1" = 100
1	SHEET S-2	SUBDIVISION OF LAND	1" = 50'
ı	SHEET S-3	TOPOGRAPHIC SUBIVISION OF LAND	1" = 50'
ı	SHEET C-1	ROAD PLAN AND PROFILE	AS SHOWN
ı	SHEET C-2	GRADING AND DRAINAGE PLAN	1" = 50'
I	SHEET C-3	CONSTRUCTION DETAILS	AS SHOWN
ı	SHEET C-4	DRAINAGE, EROSION AND	AS SHOWN
ı		SEDIMENTATION CONTROL DETAILS	


FILE NO. 132 PLAN NO. C-2097-S DWG. NO. 02058/S-3 F.B. NO. "33" GAK

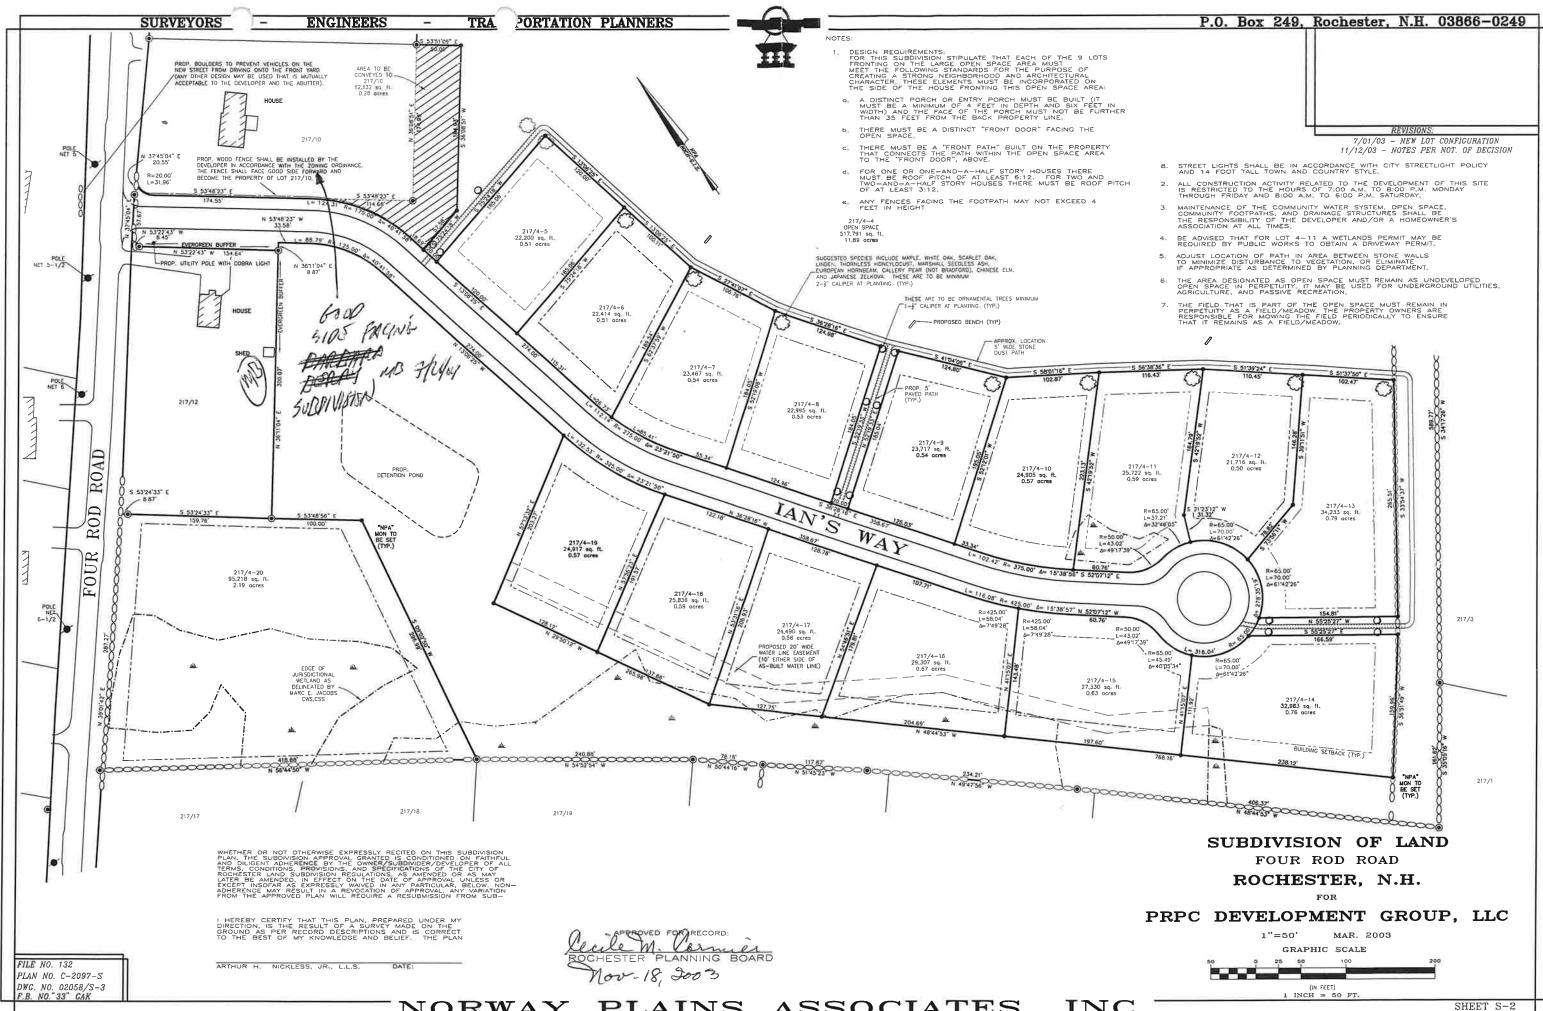


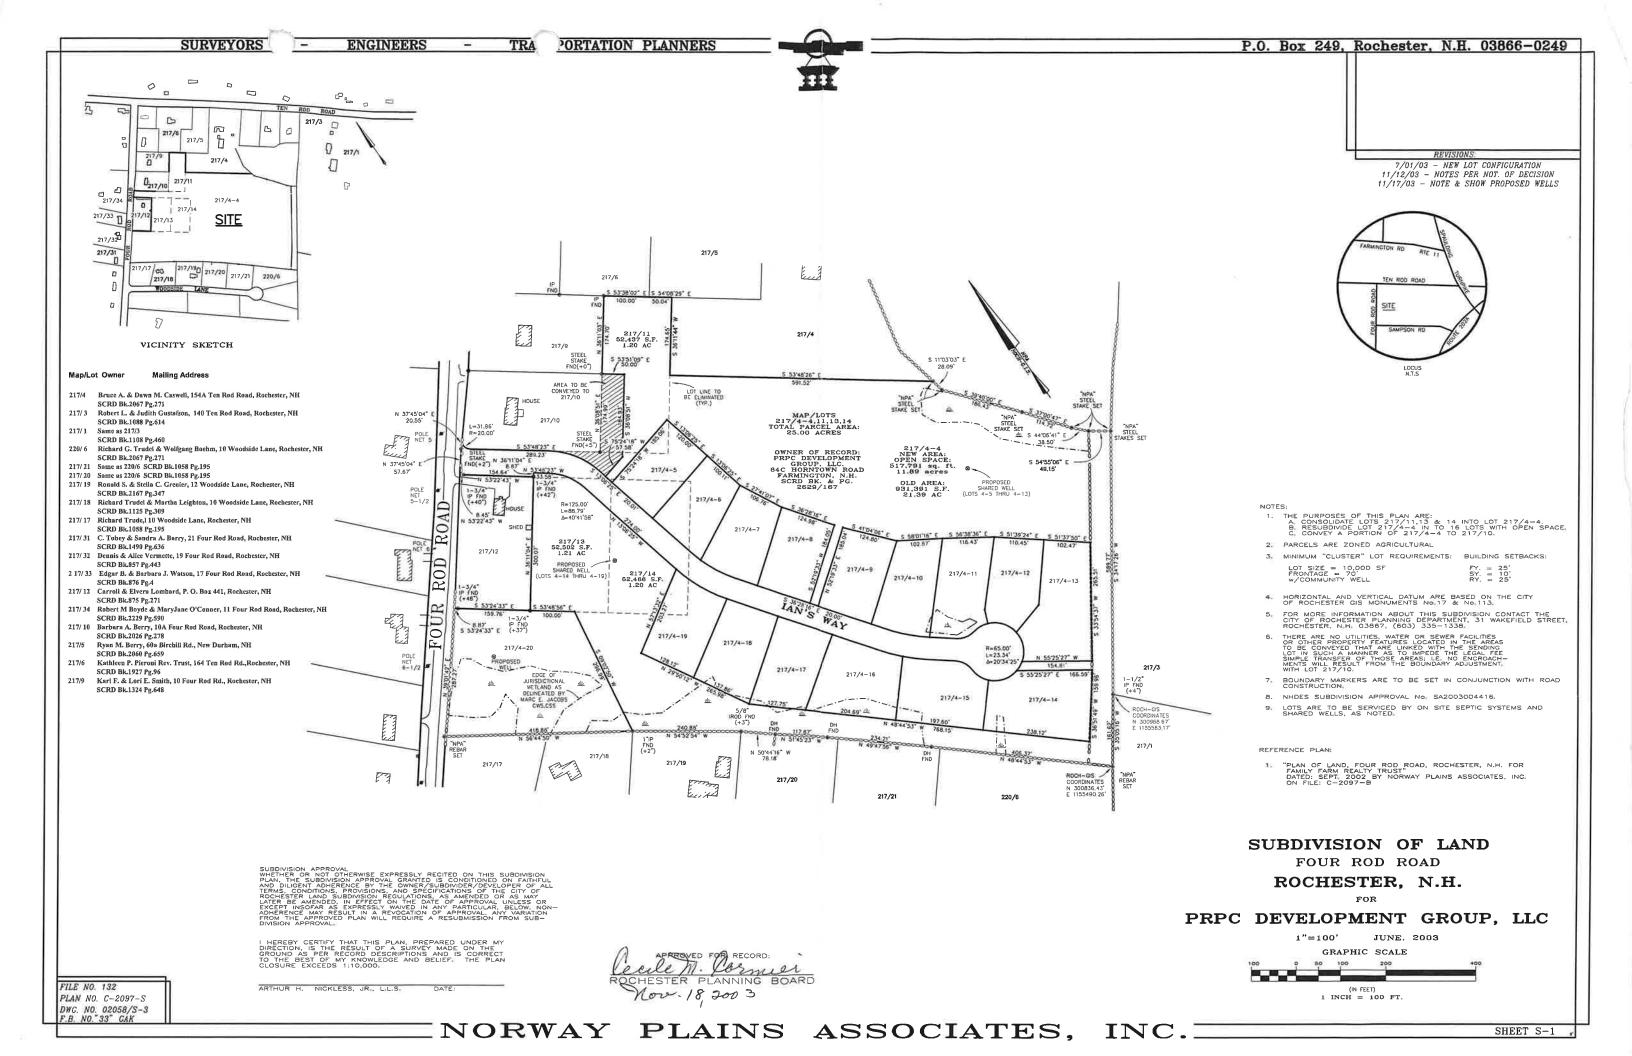

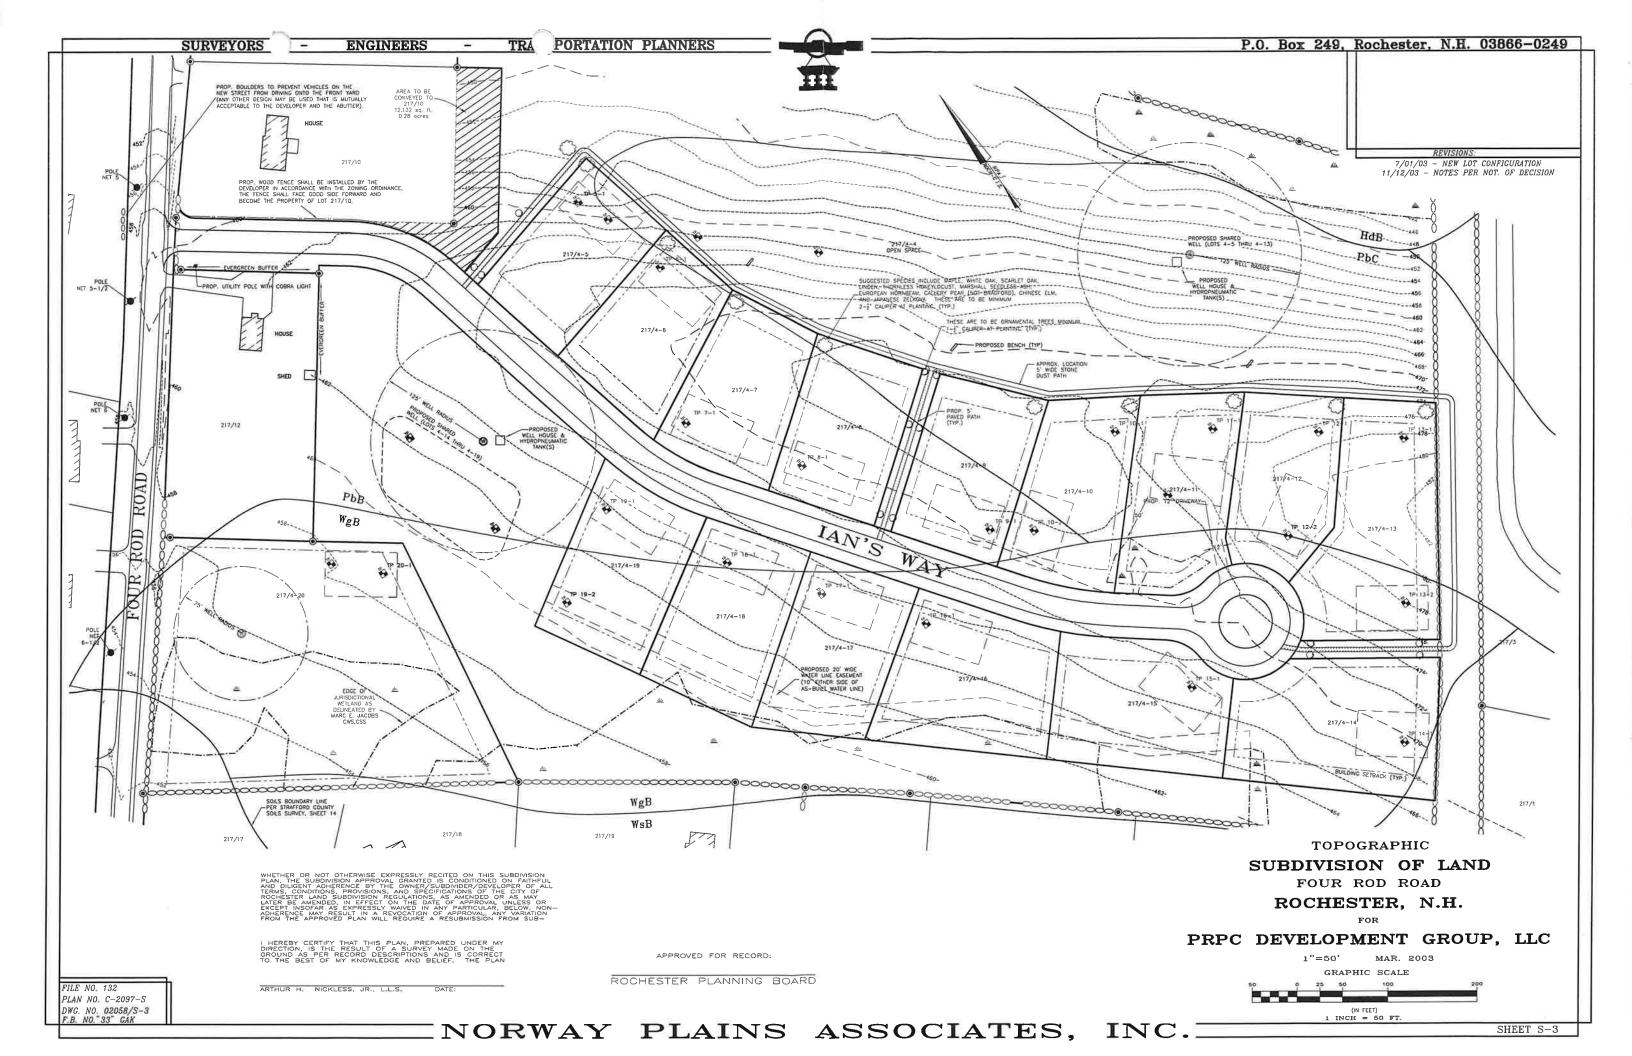

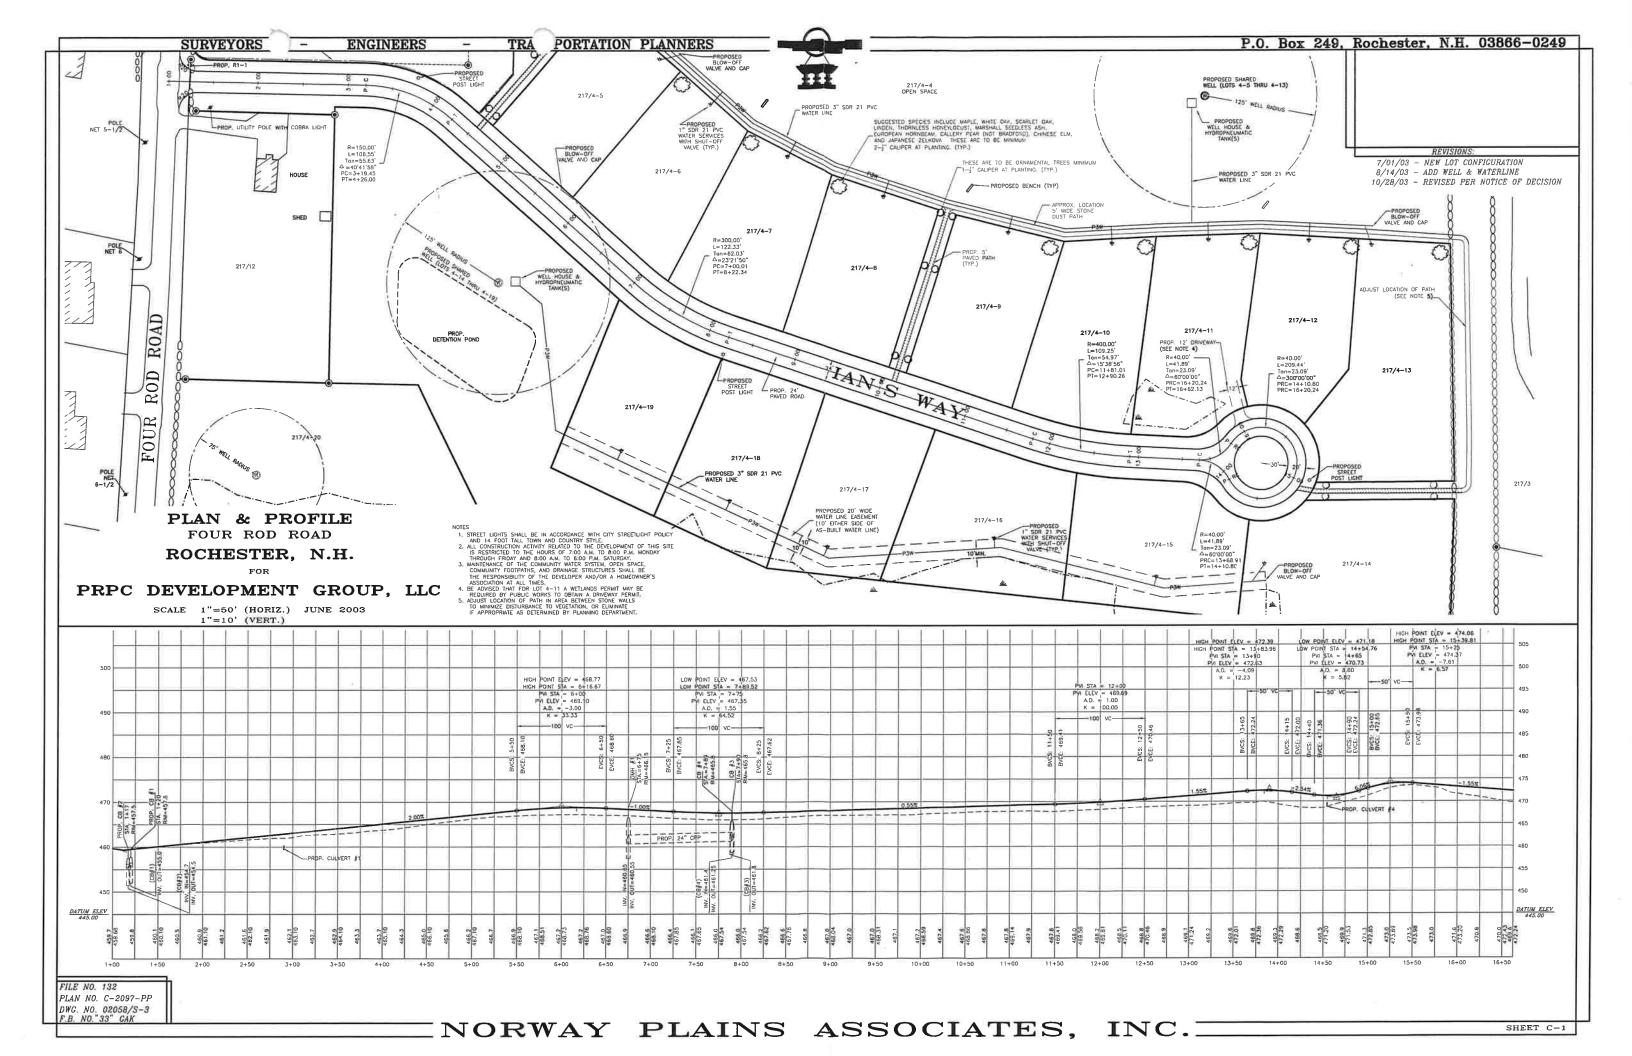


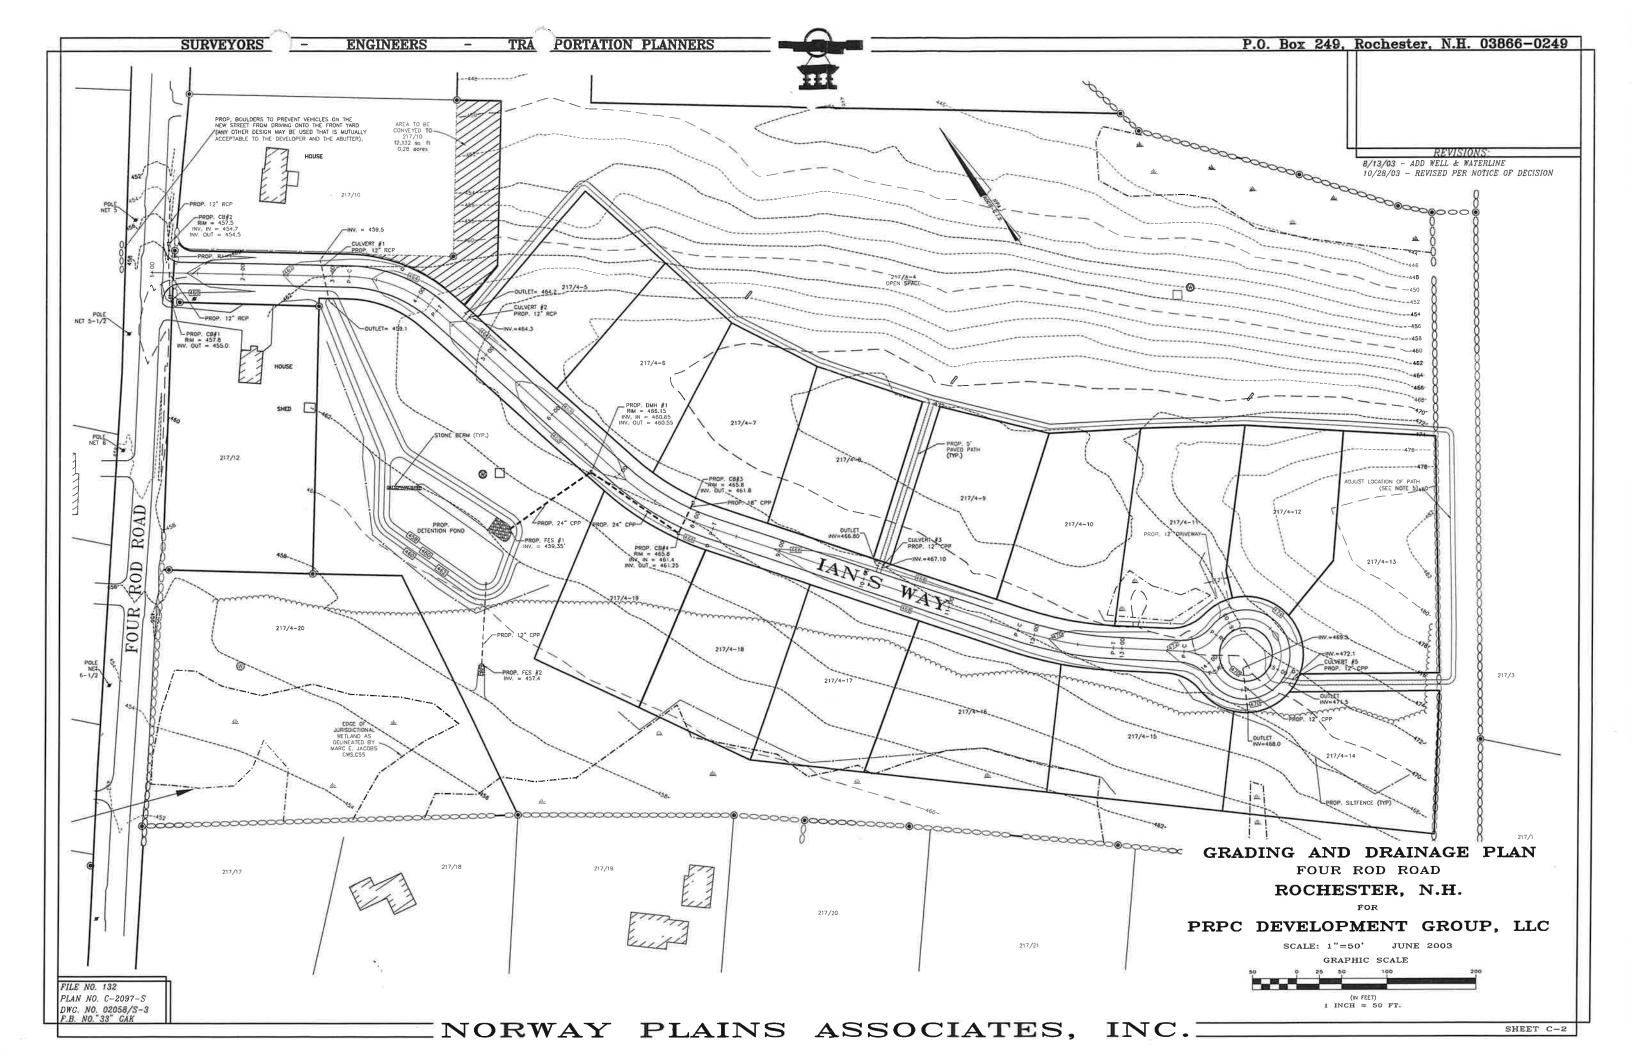


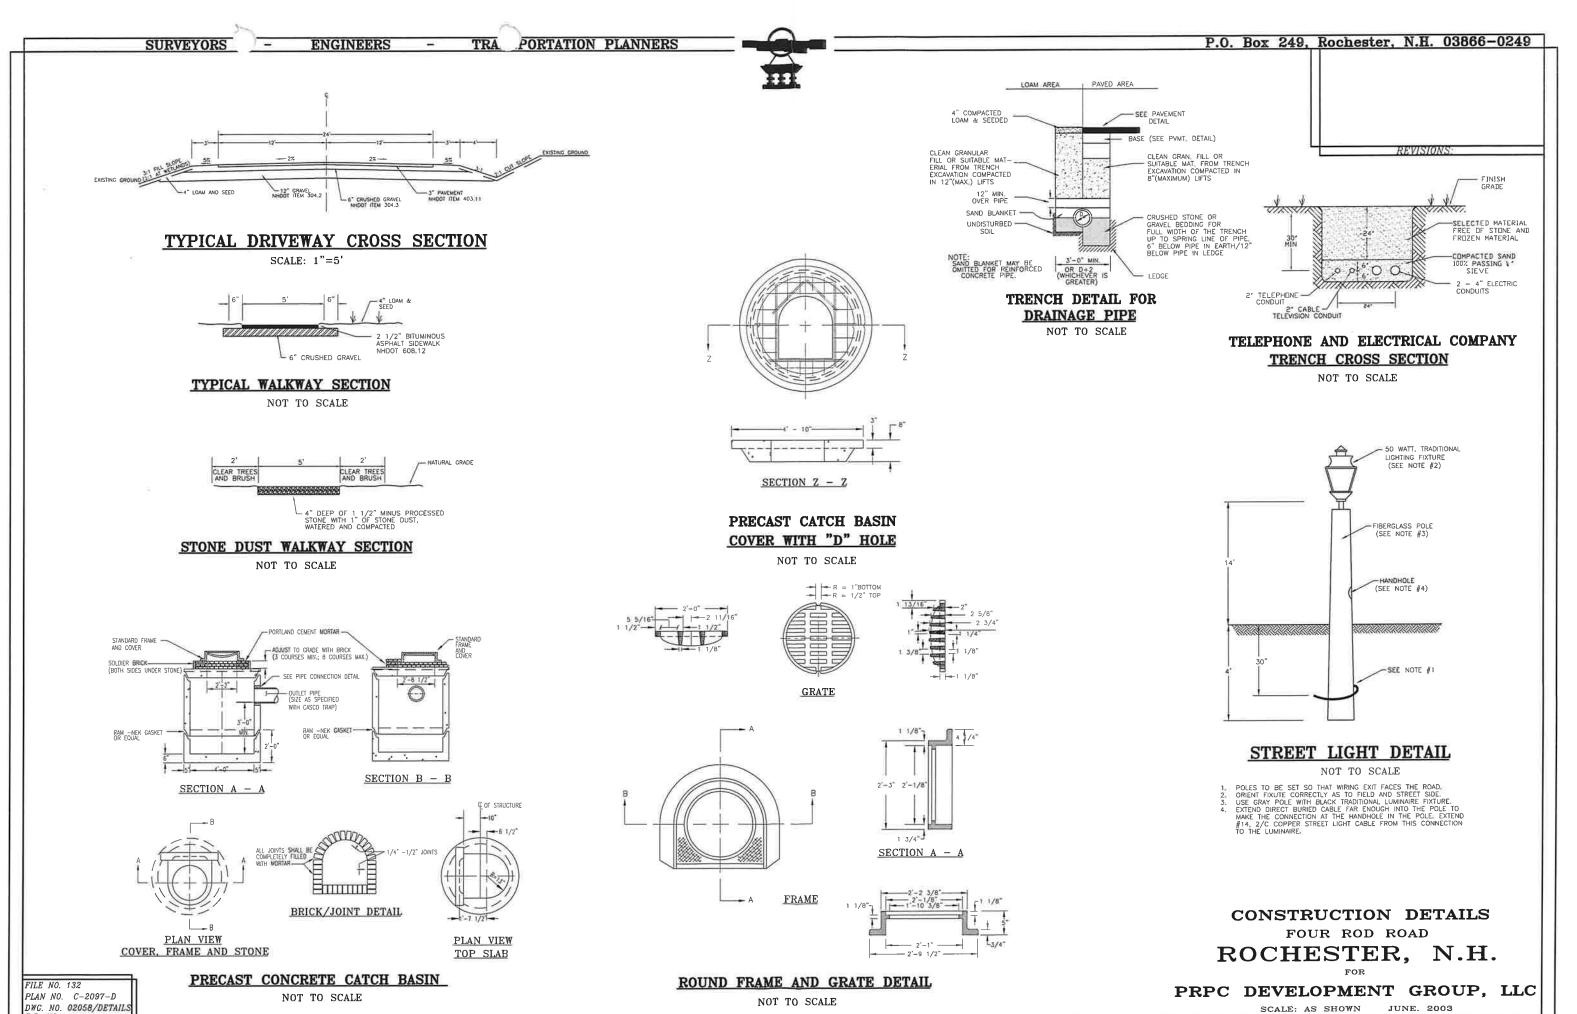

NORWAY PLAINS ASSOCIATES, INC.

SHEET C-3

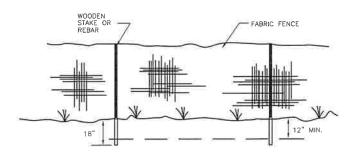

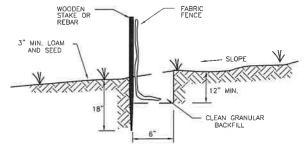

SILTATION CONTROL FENCE DETAIL

NOT TO SCALE

- CONSTRUCTION SPECIFICATIONS

 THE GEOTEXTILE FABRIC SHALL MEET THE DESIGN CRITERIA FOR SILT

- 1. THE GEOTEXTILE FABRIC SHALL MEET THE DESIGN CRITERIA FOR SILT FENCES.

 2. THE FABRIC SHALL BE EMBEDDED A MINIMUM OF B INCHES INTO THE GROUND AND THE SOIL COMPACTED OVER THE EMBEDDED FABRIC.

 3. FILTER CLOTH SHALL BE FASTERID SECURELY TO THE WOODEN STAKES OR AN INTERCRAL PART OF THE FENCE.

 4. WHEN TWO SECTIONS OF FILTER COTH ADJOIN EACH OTHER, THEY SHALL BE OVERLAPPED BY 6 INCHES, FOLDED, AND STAPLED.

 5. WOODEN STAKES SHALL BE A MINIMUM OF 35 INCHES LONG AND DRIVEN A MINIMUM OF 16 INCHES INTO THE GROUND, WOOD POSTS SHALL BE OF SOUND QUALITY HARDWOOD AND SHALL HAVE A MINIMUM CROSS SECTIONAL AREA OF 3.0 SQUARE INCHES.

 6. MAINTENANCE SHALL BE PERFORMED AS NEEDED TO PREVENT BULGES IN THE SILT FENCE DUE TO DEPOSITION OF SEDIMENT.

- BULGES IN THE SILT FENCE DUE TO DEPOSITION OF SEDIMENT.


 MAINTENANCE

 1. SILT FENCES SHALL BE INSPECTED IMMEDIATELY AFTER EACH RAINFALL
 AND AT LEAST DAILY DURING PROLONGED RAINFALL, ANY REPAIRS THAT
 ARE REQUIRED SHALL BE MADE IMMEDIATELY.

 2. IF THE FABRIC ON A SILT FENCE SHOULD DECOMPOSE OR BECOME
 INSPECTIVE DURING THE EXPECTED LIFE OF THE FENCE, THE FABRIC
 SHALL BE REPLACED PROMPTLY.

 3. SEDIMENT DEPOSITS SHOULD BE INSPECTED AFTER EVERY STORM
 EVENT, THE DEPOSITS SHOULD BE REMOVED WHEN THEY REACH
 APPROXIMATELY ONE-HALF THE HEIGHT OF THE BARRICE.


 4. SEDIMENT DEPOSITS THAT ARE REMOVED OR LEFT IN PLACE
 THE FABRIC HAS BEEN REMOVED SHALL BE REGRADED TO CONFORM
 WITH THE EXISTING TOPOGRAPHY AND VEGETATED.

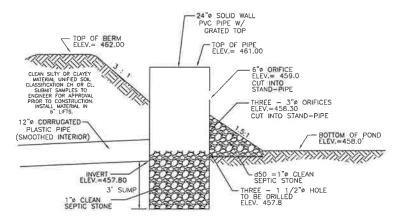

DETENTION BASIN OUTLET CONTROL


FILE NO. 132

PLAN NO. C-2097-D DWG. NO. 02058/DETAILS NOT TO SCALE

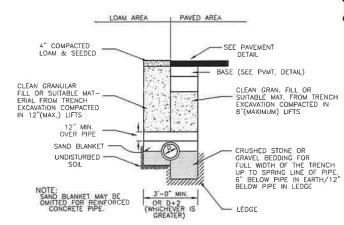

TRENCH DETAIL FOR DRAINAGE PIPE

NOT TO SCALE

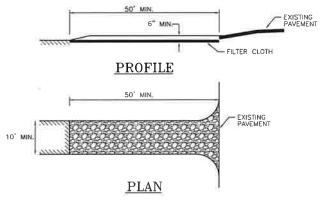

STABILIZED CONSTRUCTION ENTRANCE

NOT TO SCALE

CONSTRUCTION SPECIFICATIONS

- CONSTRUCTION SPECIFICATIONS

 CONSTRUCTION SPECIFICATIONS

 STONE FOR A STABILIZED CONSTRUCTION ENTRANCE SHALL BE 1 TO 2
 INCH STONE, RECLAIMED STONE, OR RECYCLED CONCRETE EQUIVALENT.

 THE LENGTH OF THE STABILIZED ENTRANCE SHALL NO BE LESS THAN 50
 FEET, EXCEPT FOR A SINGLE RESIDENTIAL LOT WHERE A 30 FOOT
 MINIMUM LENGTH WOULD APPLY.

 THE HIGHENESS OF THE STONE FOR THE STABILIZED ENTRANCE SHALL NOT
 BE LESS THAN 6 INCHES.

 HIE WOTH OF THE ENTRANCE SHALL NOT BE LESS THAN THE FULL WIDTH OF
 THE ENTRANCE WHERE INGRESS OR EGRESS OCCURS OR 10 FEET, WHICH EVER
 IS GREATER.

 GEOTEXTILE FILTER CLOTH SHALL BE PLACED OVER THE ENTIRE AREA PRIOR
 TO PLACING THE STONE. FILTER CLOTH IS NOT REQUIRED FOR A SINGLE FAMILY
 RESIDENCE LOT.
- RESIDENCE LOT.

 ALL SURFACE WATER THAT IS FLOWING TO OR DIVERTED TOWARDS THE CONSTRUCTION ENTRANCE. SHALL BE PIPED BENEATH THE ENTRANCE. IF PIPING IS IMPRACTICAL, A BERN WITH 5:1 SLOPES THAT CAN BE CROSSED BY VEHICLES MAY BE SUBSTITUTED FOR THE PIPE.
- SUBSTITUTED FOR THE PIPE.

 THE ENTRANCE SHALL BE MAINTAINED IN A CONDITION THAT WILL PREVENT TRACKING OF FLOWING OF SEDIMENT ONTO PUBLIC RIGHTS-OF-WAY. THIS MAY REQUIRE PERIODIC TOP DRESSING WITH ADDITIONAL STONE AS CONDITIONS DEMAND AND REPAIRS AND/OR CLEANOUT OF ANY MEASURES USED TO TRAP SEDIMENTS. ALL SEDIMENTS SPILLED, WASHED, OR TRACKED ONTO PUBLIC RIGHTS-OF-WAY WHIST BE REMOVED PROMPTLY.

 WHEELS SHALL BE CLEANED TO REMOVE MID PRIOR TO ENTRANCE ONTO PUBLIC RIGHTS-OF-WAY. WHEN WASHING IS REQUIRED, IT SHALL BE DONE ON AN AREA STABILIZED WITH STONE WHICH DRAINS INTO AN APPROVED SEDIMENT TRAPPING DEVICE.
- MAINTENANCE
 MUD AND SOIL PARTICLES WILL EVENTUALLY CLOG THE VOIDS IN THE GRAVEL
 AND THE EFFECTIVENESS OF THE GRAVEL PAD WILL NOT BE SATISFACTORY,
 WHEN THIS OCCURS, THE PAD SHOULD BE TOP DRESSED WITH NEW STONE.
 COMPLETE REPLACEMENT IF THE PAD MAY BE NECESSARY WHEN THE PAD
- COMPLETE REPLACEMENT IF THE PAD MAY BE NECESSARY WHEN THE PAD BECOMES COMPLETELY CLOGGED.

 IF WASHING FACILITIES ARE USED, THE SEDIMENT TRAPS SHOULD BE CLEANED OUT AS OFTEN AS NECESSARY TO ASSURE THAT ADEQUATE TRAPPING EFFICIENCY AND STORAGE VOLUME IS AVAILABLE.

 VEGETATIVE FILTER STRIPS SHOULD BE MAINTAINED TO INSURE A VIGOROUS STAND OF VEGETATION AT ALL TIMES.

PLAN

FLARED FND SECTION

SECTION A-A

STRUCT.#	d٥	W ₁	Lo	W ₂	dso	d
1	24"	6"	20'	26'	5"	12"
2	12"	3'	10"	13"	5"	12"

PIPE OUTLET PROTECTION

- 1. GEOTEXTILE FABRIC OR FILTER MATERIAL TO BE
- PLACED BETWEEN RIPRAP AND SOIL. 2. BOTTOM GRADE OF APRON SHALL BE LEVEL
- 2. BOTTOM GRADE OF APRON SHALL BE LEVEL
 (0% GRADE)
 3. FIFTY PERCENT BY WEIGHT OF THE RIPRAP MIXTURE
 SHALL BE SMALLER THAT THE dow SIZE. THE LARGEST
 STONE SIZE IN THE MIXTURE SHALL BE 1.5 TIMES
 THE dow SIZE.

CONSTRUCTION SEQUENCE

- 1.) INSTALL SILT FENCE AS SHOWN ON PLAN.
- 2.) CONSTRUCT THE STABILIZED CONSTRUCTION ENTRANCE AT BEGINING OF PROPOSED ROAD
- 3.) REMOVE STUMPS AND GRUB ROAD TO SUBGRADE.
- 3.) REMOVE STOMPS AND GRUB ROAD TO SUBGRADE.

 4.) DITCHES, SWALES, AND THE DETENTION POND MUST BE STABILIZED BEFORE DIRECTING RUNOFF TO THEM. EROSION CONTROL BLANKETS (CURLEX EXCELSIOR BY AMERICAN EXCELSIOR COMPANY, OR EQUAL) SHALL BE USED WHERE SOD IS NOT PLACED AND VEGETATION IS NOT ESTABILISHED.

 5.) REMOVE THE LOAM AND VEGETATION FROM THE ROADWAY AND BACKSLOPE AREAS THE LOAM WILL NEED TO BE STORED FOR USE LATER IN STABILIZING THE SWALES AND SIDESLOPES. THE LOAM PUE SHALL BE SEEDED FOR TEMPORARY PROTECTION SHOULD IT REMAIN INACTIVE FOR MORE THAN 30 DAYS, AT NO POINT, SHALL THERE BE MORE THAN 5. ACCESSORE SYPONSOR PARTY. BE MORE THAN 5 ACRES OF EXPOSED FARTH.

- BE MORE THAN 5 ACRES OF EXPOSED EARTH.

 6.) ALL CUT AND FILL SLOPES SHALL BE SEEDED AND MULCHED OR COVERED WITH AN EROSION CONTROL BLANKET IMMEDIATELY AFTER THEIR CONSTRUCTION.

 7.) INSTALL THE GRAVEL BASE IN ALL AREAS TO BE PAVED.

 8.) INSTALL ALL NEW PAVING.

 9.) ALL DISTURBED AREAS EXCLUDING BUILDINGS AND PARKING SHALL BE STABILIZED AS 500N AS POSSIBLE, BUT IN NO CASE SHALL BE LEFT UNSTABILIZED FOR MORE THAN 30 DAYS, BUILDINGS, PARKING LOTS, AND DRIVEWAYS SHALL BE CONSTRUCTED AS PRACTICABLE, BUT IN NO CASE SHALL BE LEFT UNPROTECTED OVER THE WINTER MONTHS.
- 10.) REMOVE TEMPORARY EROSION CONTROL (SILT FENCE) TO ELIMINATE FLOW IMPEDIMENTS ONCE SEEDING IS FIRMLY ESTABLISHED

GENERAL MAINTENANCE OF EROSION CONTROL STRUCTURES

- ALL EROSION CONTROL STRUCTURES SHALL BE INSPECTED ANNUALLY AND AFTER EVERY MAJOR STORM. ALL DAMAGED STRUCTURES, TEMPORARY OR PERMANENT, SHALL BE REPAIRED IMMEDIATELY.
- ALL DEBRIS, OBSTRUCTIONS AND SEDIMENT SHALL BE REMOVED AS NEEDED TO MAINTAIN PROPER PERFORMANCE. SEDIMENT AND DEBRIS SHALL BE DISPOSED OF PROPERLY IN APPROVED LOCATIONS.
- 3.) ALL VEGETATION SHALL BE INSPECTED AND MAINTAINED AS DESIGNED, SEED AND FERTILIZER SHALL BE REAPPLIED AS NEEDED.
- 4.) ALL TEMPORARY EROSION CONTROL MEASURES SHALL BE REMOVED AFTER CONSTRUCTION IS COMPLETE AND INITIAL VEGETATIVE CROWTH IS ESTABLISHED. PERMANENT MEASURES:

CULVERTS

1.) INSPECT IN THE SPRING OF EACH YEAR AND CLEAN AND REPAIR AS NEEDED.

EROSION CONTROL MEASURES

- 1.) INSTALL ALL SILT FENCE AND CONSTRUCTION FENCE PRIOR TO BEGINNING CONSTRUCTION,
 2.) INSTALL SOD IN ALL SWALES IMMEDIATELY AFTER THEY ARE CONSTRUCTED,
 3.) SEEDING FOR LONG TERM COVER:
- SEED MIXTURE: TALL FESCUE CREEPING RED FESCUE LBS./ACRE LBS /1000 SQ. FT. 0.45 0.45

20 8 48 CREEPING RED FESCUE

BIRDSFOOT TREFOIL

8

0.20

TOTAL

NOTE: BIRDSFOOT TREFOIL MUST BE INOCULATED.

4.) IF SOIL TEST IS NOT AVAILBLE THE FOLLOWING MINIMUM AMOUNTS SHALL BE USED:
LIME - 2 TONS/ACRE OR 100 LBS/1000 SQ. FT.
FERTILIZER - 500 LBS/ACRE OF 10-20-20 OR EQUAL.

5.) THE ABOVE SPECIFICATION FOR CRASS SEED SHALL BE USED FOR THE DETENTION POND,

- 6.) SEEDING FOR TEMPORARY PROTECTION:
- SEED MIXTURE:

 WINTER RYE

 112

 1.50

 1.51

 1.52

 1.50

 1.53

 1.54

 1.55

 1.55

- 2 TONS/ACRE OR 90 LBS/1000 SQ. FT.

 8.) STONE RIP RAP SHALL BE PLACED AT OUTLETS AS SHOWN ON THE PLANS.

 9.) HAY BALE DAMS SHALL BE INSTALLED IMMEDIATELY AFTER CONSTRUCTION AS SHOWN ON
- THE PLANS.

 10.) RIP RAP, HAY BALES, AND EROSION CONTROL MATTING SHALL NOT BE PLACED ON FROZEN

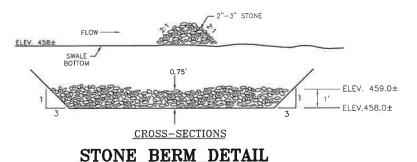

NOT TO SCALE

DRAINAGE, EROSION AND SEDIMENTATION CONTROL DETAILS

FOUR ROD ROAD

ROCHESTER, N.H.

PRPC DEVELOPMENT GROUP, LLC

SCALE: AS SHOWN JUNE 2003