PROPOSED AGRIVOLTAICS FIELD


revisions: 08/2/23 – Revise per agt comments, modify shaw dri

SHAW DRIVE

PREPARED FOR

GNM SOLAR 17, LLC SEPTEMBER 2022

REVISED JUNE 2023

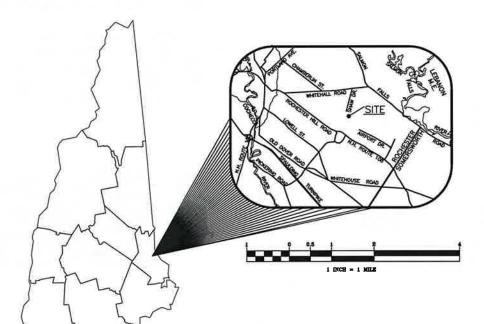


NEW HAMPSHIRE FISH AND CAME AOT PERMIT CONDITIONS RELATED TO THREATENED AND ENDANGERED SPECIES:

ALL OBSERVATIONS OF THREATENED OR ENDANGERED SPECIES SHALL BE REPORTED IMMEDIATELY TO THE NEW HAMPSHIRE FISH AND GAME DEPARTMENT NONCAME AND ENDANGERED WILDLIFE ENVIRONMENTAL REVIEW PROGRAM BY PHONE AT 603-271-2461 AND BY EDMAL AT INHERGYEWOWILDLIPENH.GOV. BAMIL SUBJECT LINE: NHB22-2361, 80 SHAW DRIVE WILDLIFE SPECIES OBSERVATION. PHOTOGRAPHS OF THE OBSERVED SPECIES AND NEARLY ELEMENTS OF HABITAT OR AREAS OF LAND DISTURBANCE SHALL BE PROVIDED TO NHFAG IN DIGITAL FORMAT AT THE ABOVE EMAL ADDRESS FOR VERIFICATION AS FEASIBL.

IN THE EVENT A THREATENED OF ENDANGERED SPECIES IS OBSERVED ON THE PROJECT SITE DURING THE TERM OF THE PERMIT, THE SPECIES SHALL NOT BE DISTURBED, HANDLED, OR HARMED IM ANY WAY PRIOR TO CONSULTATION WITH NHFAG, IF ANY, TO ASSUME THE POLICET DES NOT APPRECABLY JEOPARDIZE THE CONTINUED EXISTENCE OF THREATENED AND ENDANGERED SPECIES AS DEFINED IN FIS 1002.04.

FIS 1UU2.U4.
THE NHF&G, INCLUDING ITS EMPLOYEES AND AUTHORIZED AGENTS, SHALL HAVE ACCESS TO THE PROPERTY DURING THE TERM OF THE PERMIT.

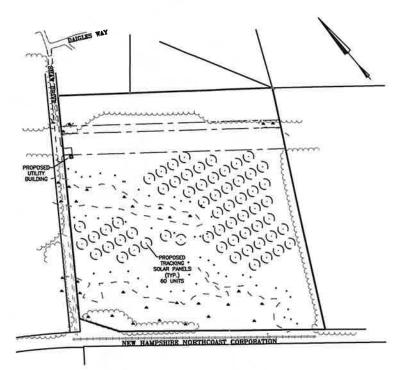

OVERALL SITE 1" = 200'

CIVIL ENGINEERS

NORWAY PLAINS ASSOCIATES, INC. 2 CONTINENTAL BOULEVARD ROCHESTER, NEW HAMPSHIRE 03867 (603) 335-3948

CAREFULLY REVIEW ALL SHEETS OF THIS PACKAGE TO INSURE PROPER CONSTRUCTION. SPECIFIC SITE CONDITIONS SHOULD BE EXPLORED PRIOR TO CONSTRUCTION. CONTACT BOTH THE DESIGN ENGINEER AND THE PROJECT OWNER FOR ANY AVAILABLE GEOTECHNICAL OR HYDROGEOLOGICAL INFORMATION AVAILABLE BUT NOT CONTAINED WITH IN THE PLAN SET. IF THERE ARE ANY QUESTIONS WITH THE DESIGN PRESENTED IN THIS PLAN SET PLEASE CONTACT THE ENGINEERING STAFF AT NORWAY PLAINS ASSOCIATES, INC. (603)—335—3948.

OWNER OF RECORD TAX MAP 240, LOT 49 GNM SOLAR 17, LLC 123 WASHINGTON STREET ROCHESTER N.H. 03867 SCRD BOOK 4946, PAGE 485

APPLICANT

GNM SOLAR 17. LLC 123 WASHINGTON STREET ROCHESTER, NH 03867 (603) 765-9101

ITIONAL POLLUTANT DISCHARGE ELIMINATION SYSTEM (NPDES);
NPDES PERMITS ARE ONLY REQUIRED FOR PROJECTS MEETING THE DISTURBED AREA
CRITERIA BELOW AND HANNIG A POINT SOURCE STORMWATER DISCHARGE FROM THE
SITE TO AN ADJACENT WETLAND OR WATER BODY (I.E. CULVERT, SWALE, ETC.

NPDES PERMITS CONSIST OF A NOTICE OF INTENT (NOI) FILED WITH THE ENVIRONMENTAL PROTECTION AGENCY AT LEAST 14 DAYS PRIOR TO CONSTRUCTION COMBENCIOS AND A STORMWATER POLLUTION PREVENTION PLAN (SWPPP) BEING PREPARED, KEPT ON SITE AND FOLLOWED BY THE CONTRACTOR.

FOR STATUS OF THIS PERMIT, CONTACT THE PROJECT GENERAL CONTRACTOR

FINAL APPROVAL BY

DATE: 8.16.23 aug 7 PBMeeting

SHEET INDEX

COVER
EXISTING FEATURES

OVERALL SITE PLAN

ORADING, DRAINAGE EROSION AND SEDIMENTATION 1" = 100'

CONTROL PLAN

UTILITY PLAN

SHAW DRIVE IMPROVEMENT PLAN AND PROFILE

CONSTRUCTION DETAILS

AS SHOWN

TEMPORARY EROSION AND SEDIMENTATION


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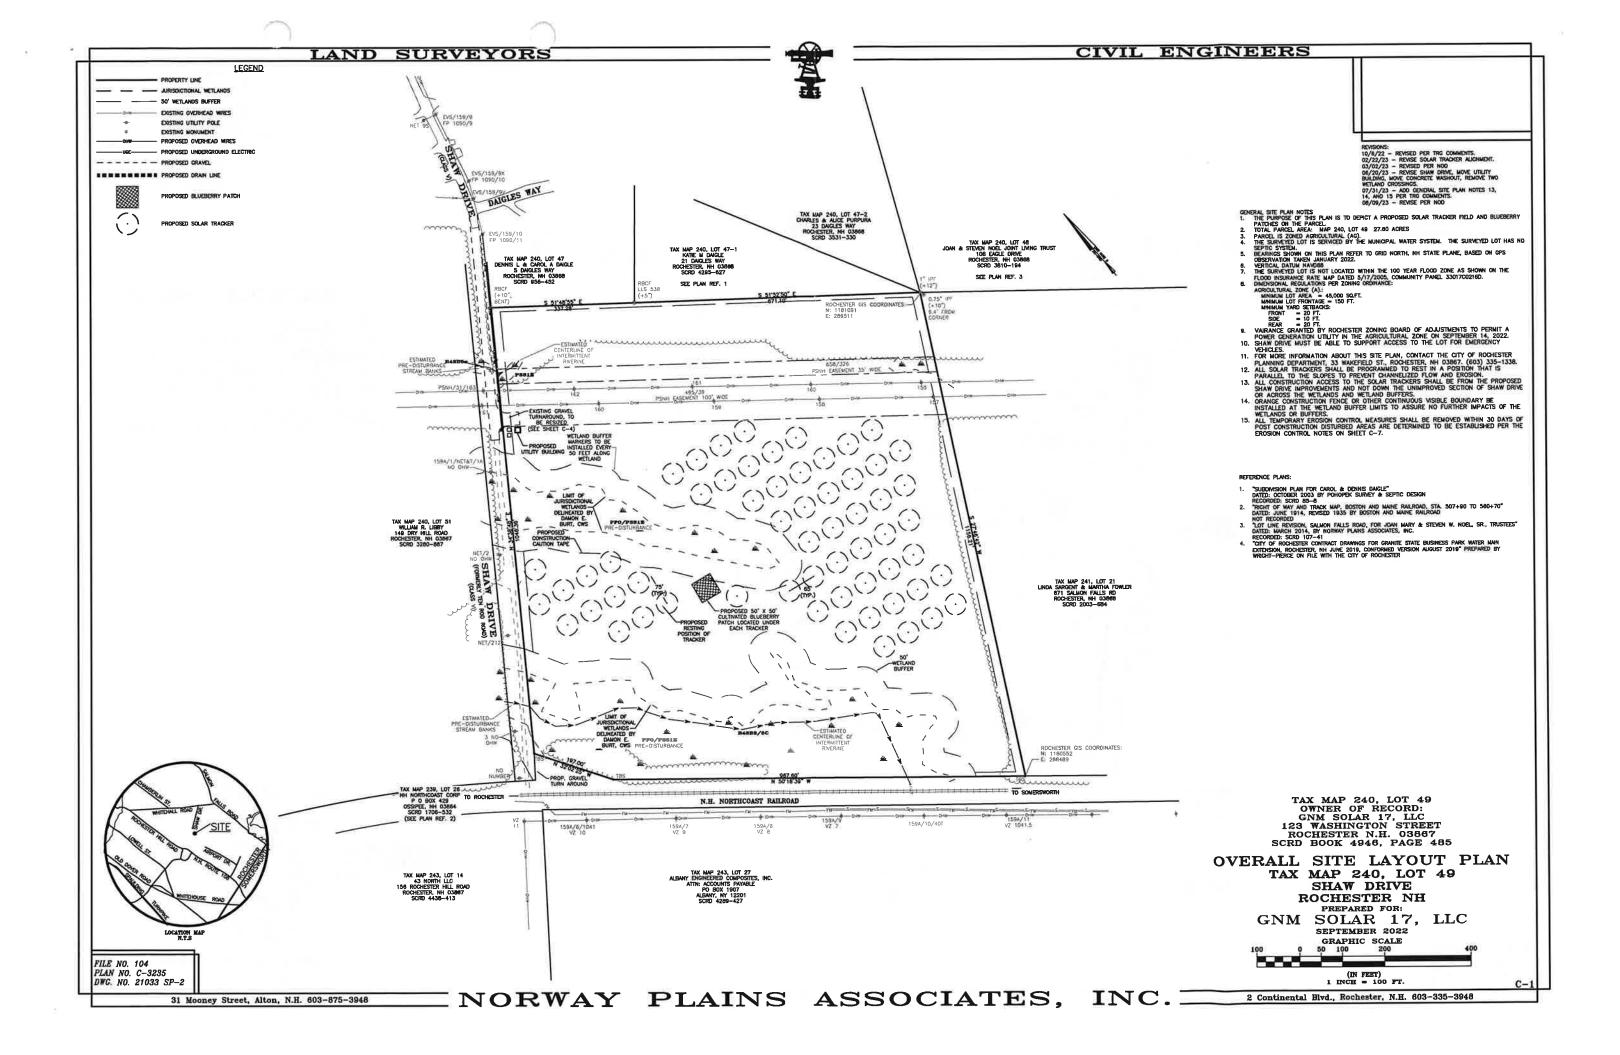
AS SHOWN SHEET C-7


SHEET INDEX


2 Continental Blvd., Rochester, N.H. 603-335-3948


FILE NO. 104 DWG. NO. 21033 SP-2



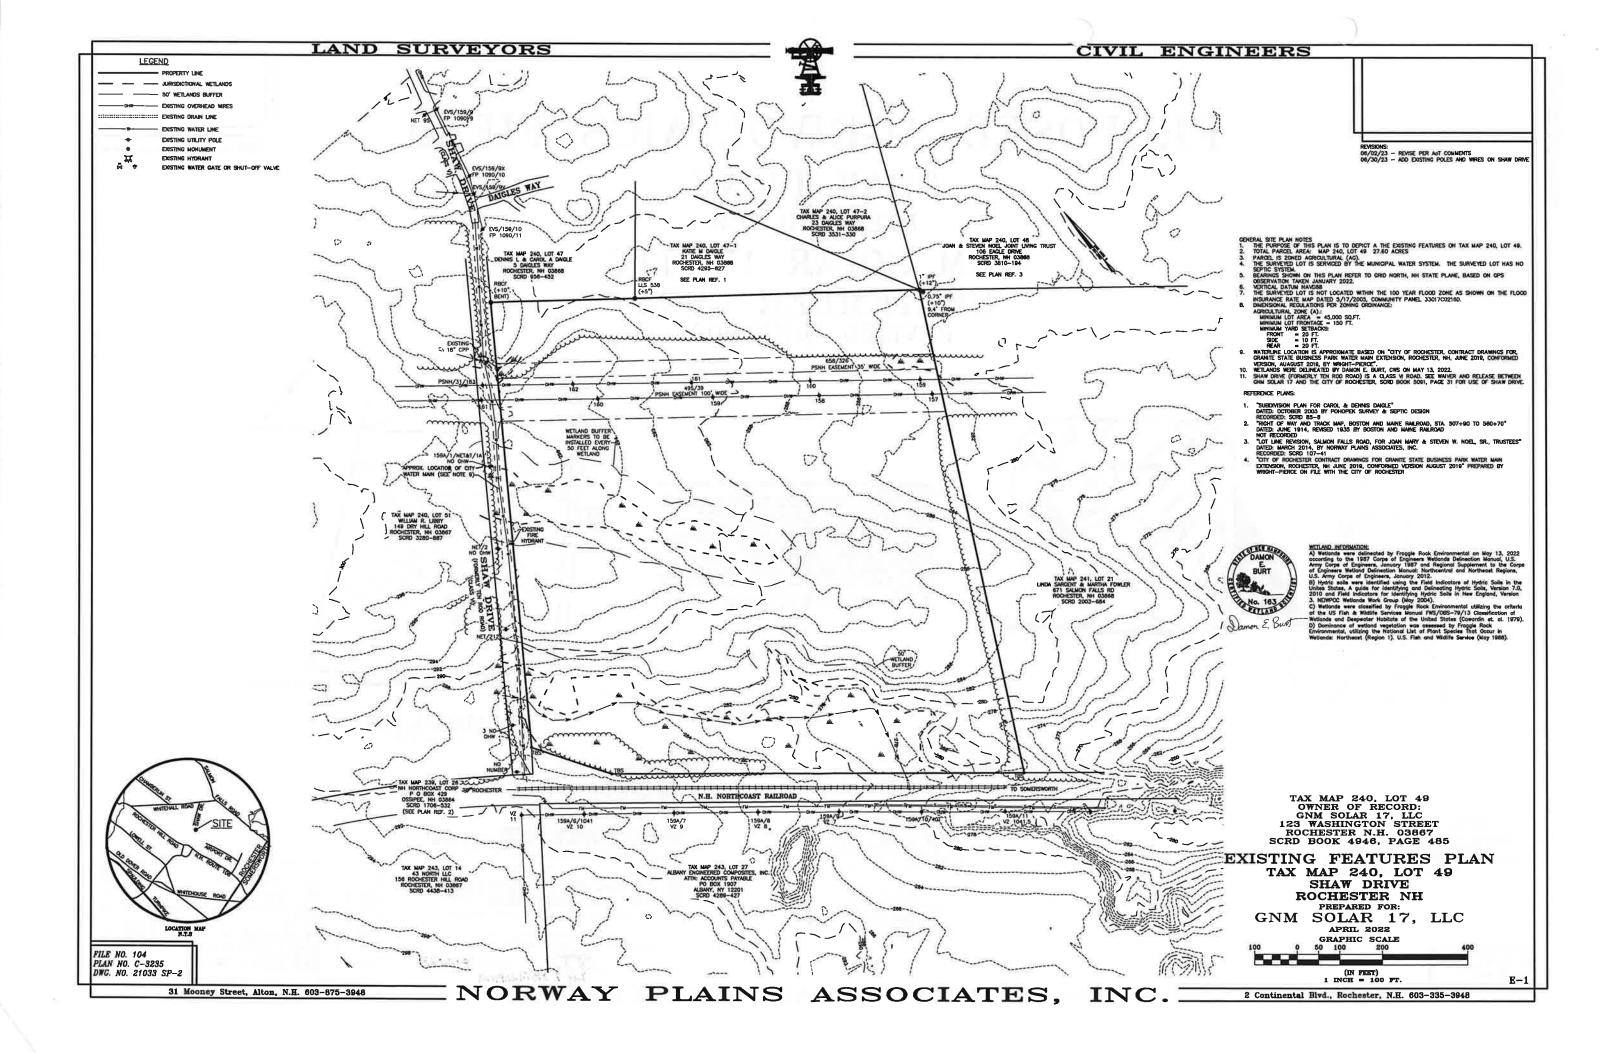


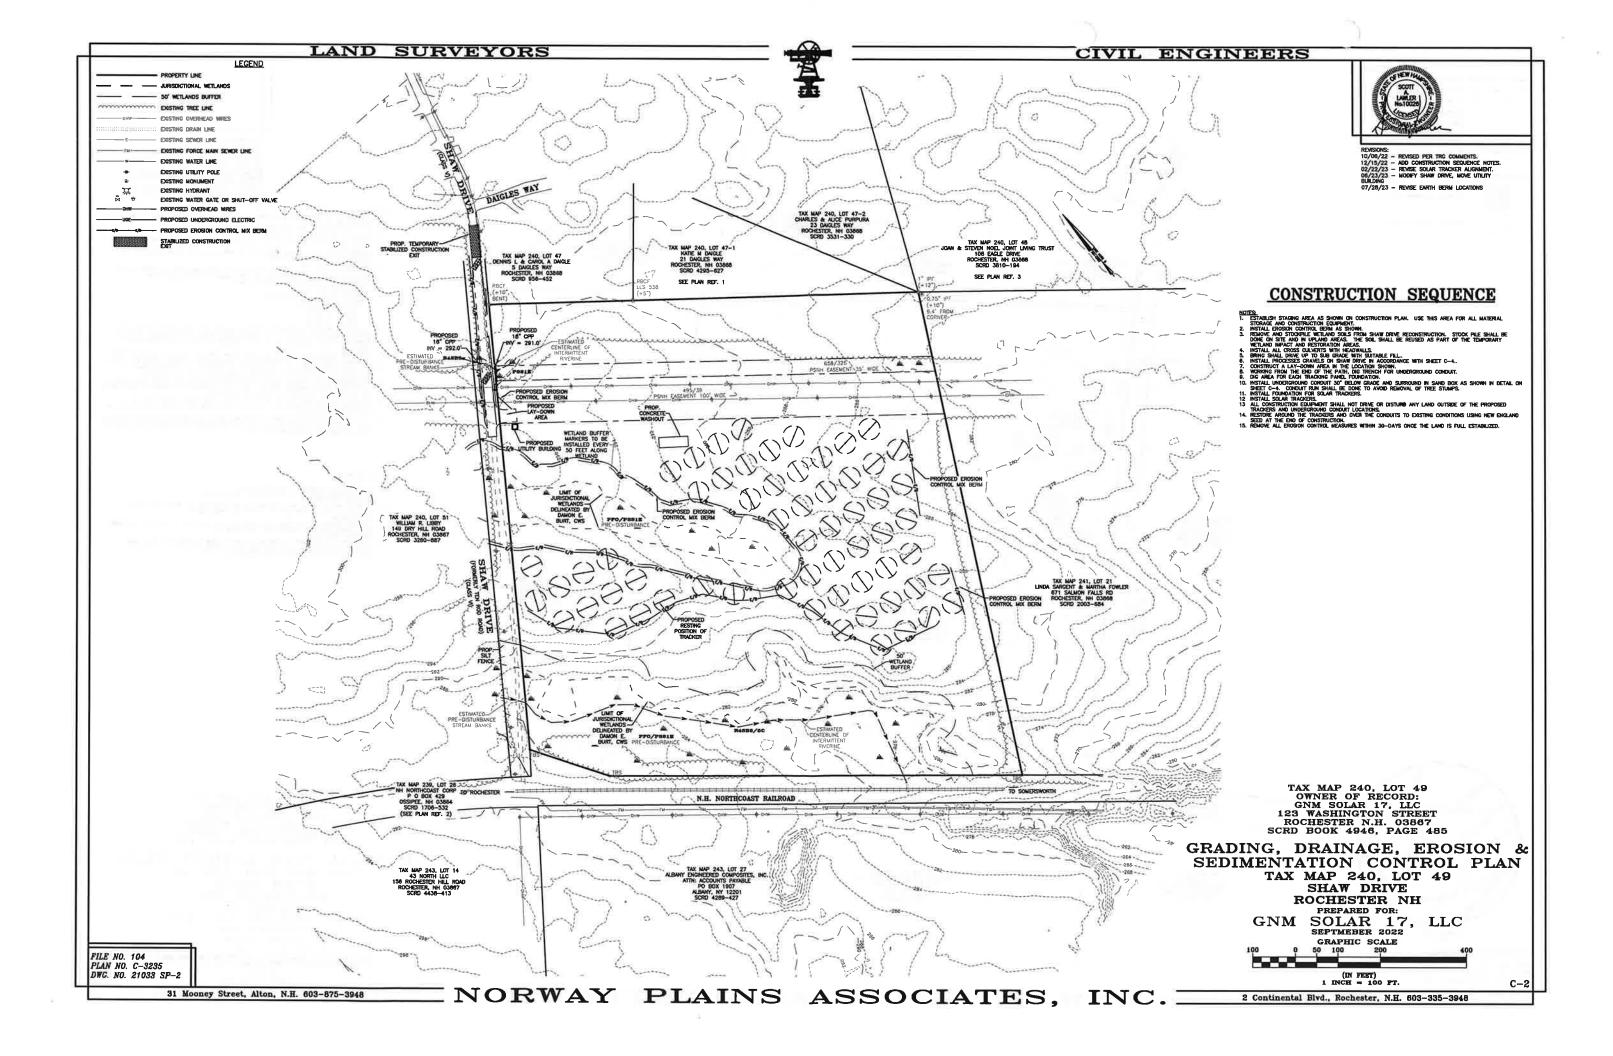

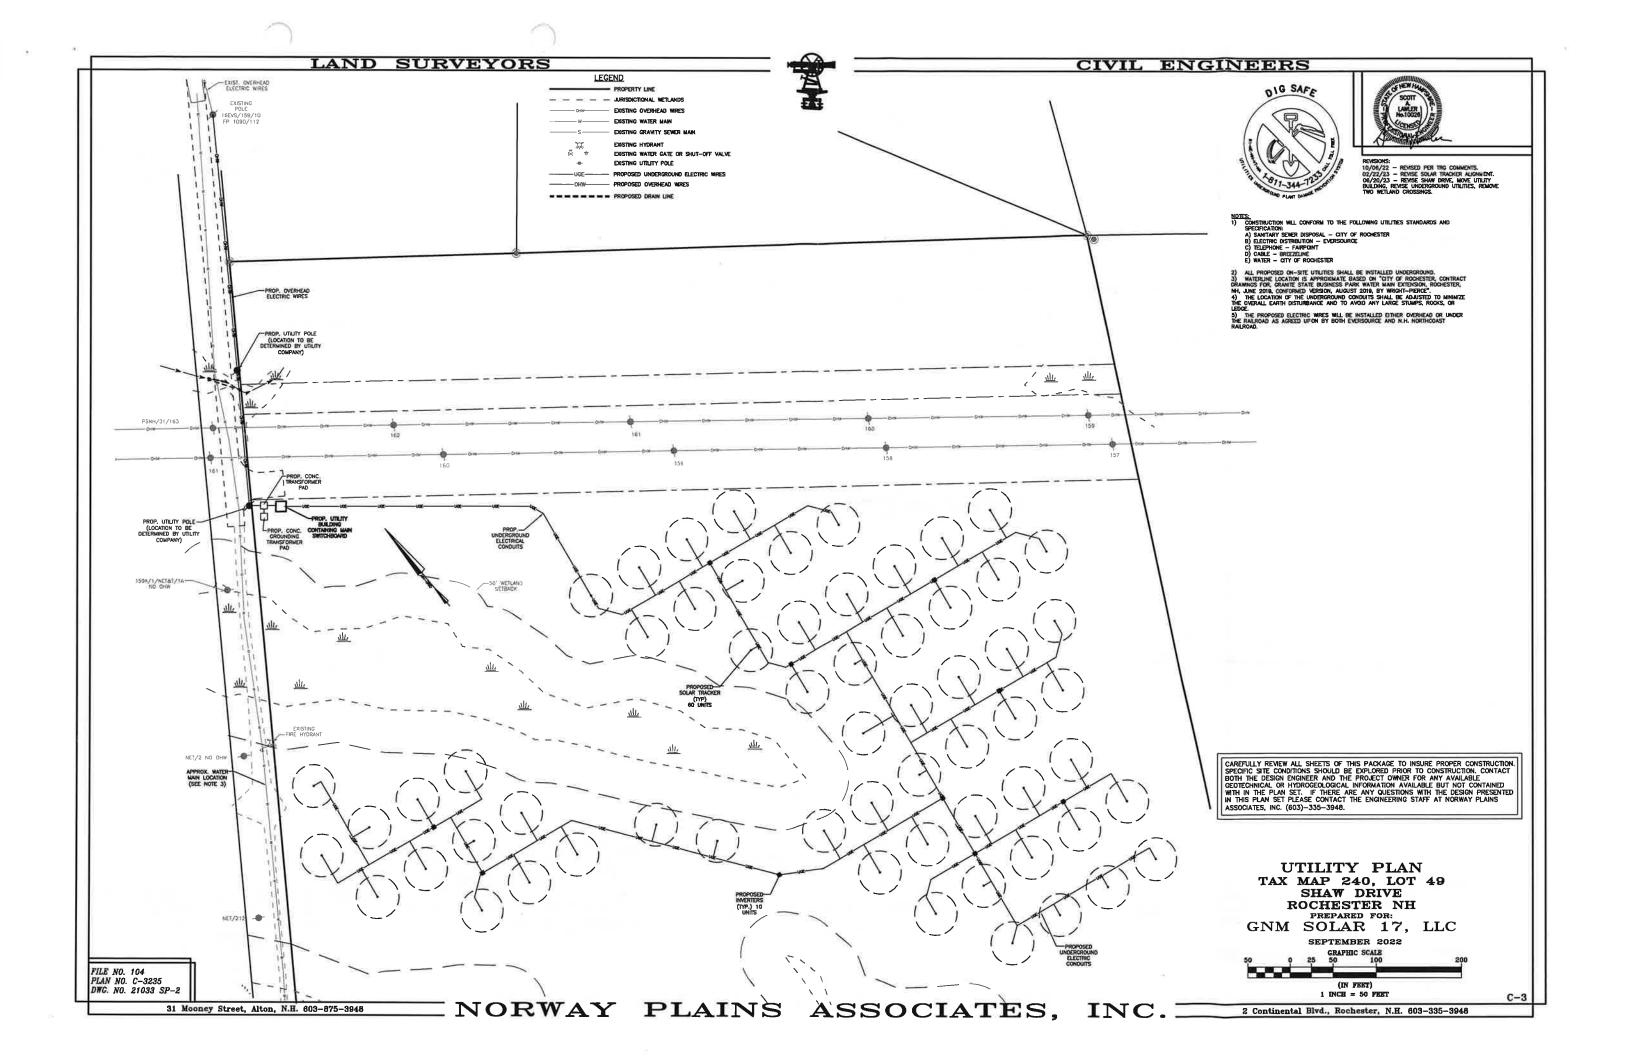


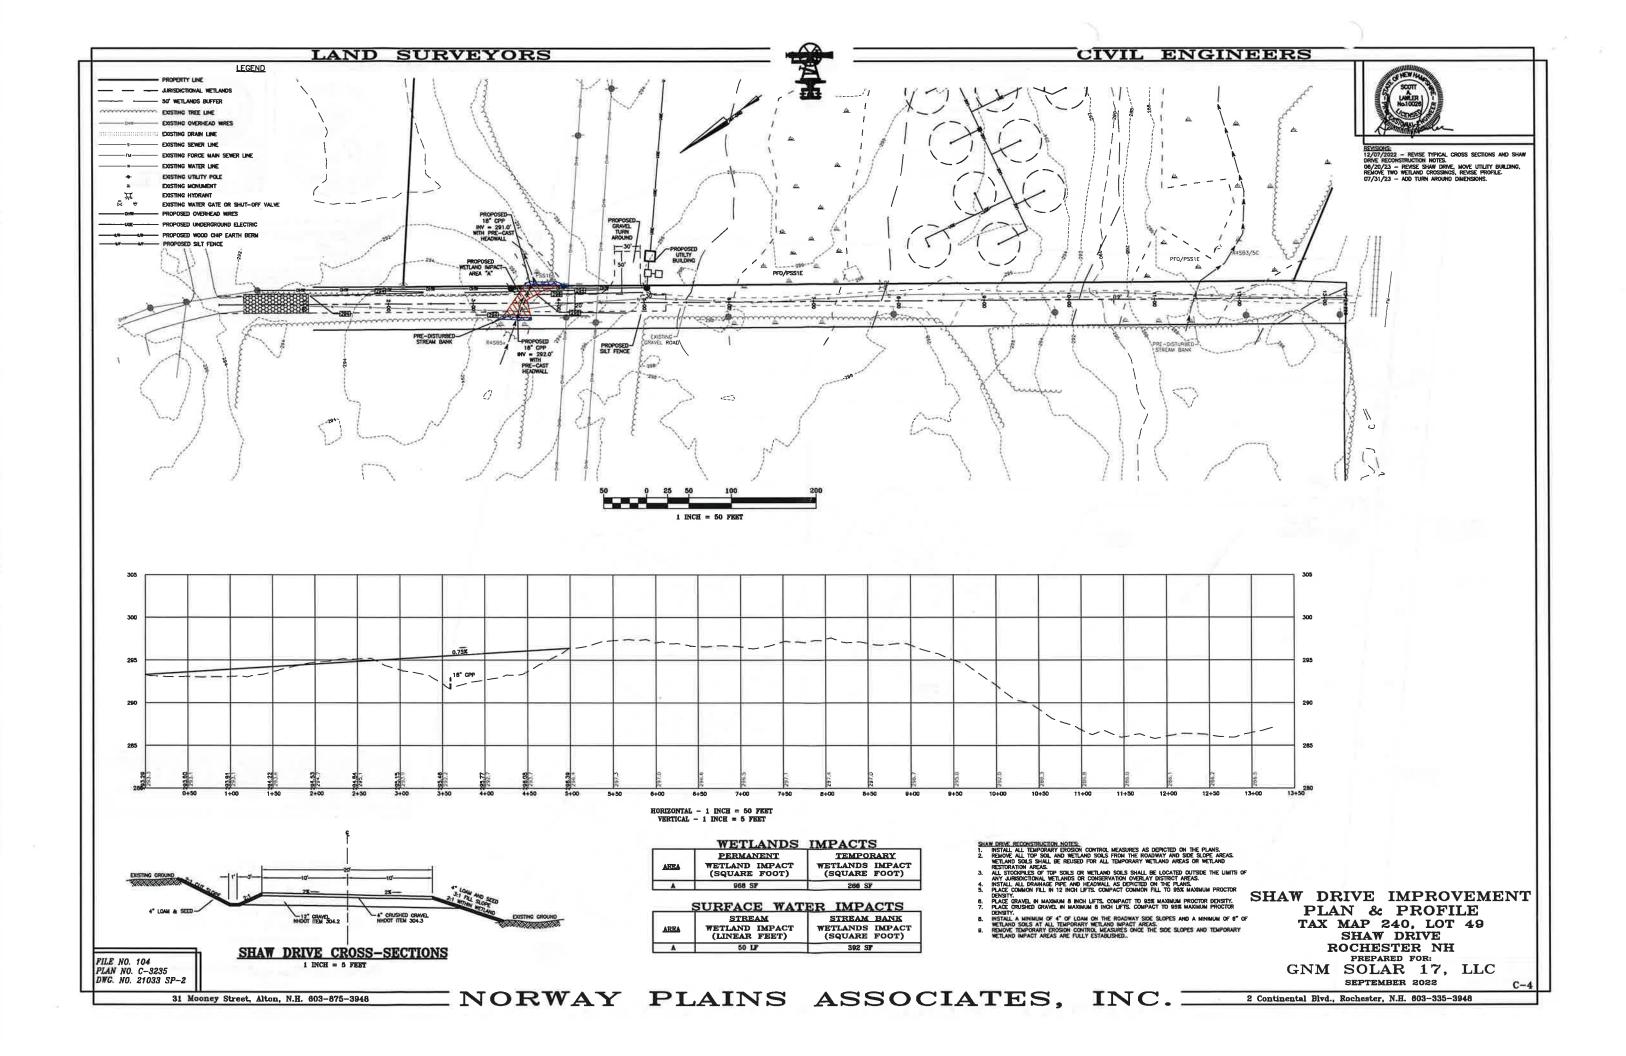

LAND SURVEYORS

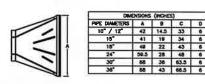

TOP VIEW

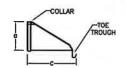




FRONT VIEW

FLAIRED END SECTION DETAIL


NOT TO SCALE

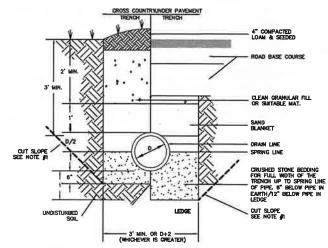

MAY BE RESTAULD BY DELLAYING AN OPEN TRENCY WITH SIDE SUPPES OF 1:1 MAGNAM TO A OF A-FT INFLATIONS DEPEN THAN 4-FT REQUIRES THE USE OF A TRENCH BOX. NATERNAL SHALL BE AS SPECIFED ON THE DESIGN PLAN.

BLANKET MAY BE GUITTED FOR REPREFORCE DONNETTE PRE-

DRAINAGE PIPE TRENCH INSTALLATION DETAIL NOT TO SCALE

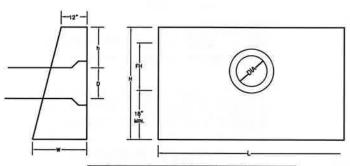

DIA. D	HEADWALL LENGHT L	HEADWALL HIGHT H	FILL HIGHT FH	PIPE COVER h	HEADWALL BTM HEICHT W
12"	4'3"	3,8.	1'1"	1'3"	2'
15"	8'	4'3"	177	1'6"	2'1"
18"	7	4'6"	1'10"	1'6"	2'2"
24"	0,	5"	2'4"	1'0"	2,3,
30"	11'	5'6"	2'10"	1'6"	2'5"
36"	13'	6'	3'4"	1'6"	2'6"
42"	15'9"	6,8,	41*	1'9"	5.8.
48"	17'9"	7'3"	4'7"	1'9"	2'10"

PRE-CAST HEADWALL

31 Mooney Street, Alton, N.H. 603-875-3948

FILE NO. 104 PLAN NO. C-3235 DWC. NO. 21033 SP-2

CIVIL ENGINEERS

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UTILITY CONDUIT CONSTRUCTION CROSS-SECTION

(SEE STRUCTURAL PLAN FOR


STANDARD SOLAR TRACKER INSTALLATION DETAIL

NOT TO SCALE

NOTES: 1. CONCRETE TRACKER BASE OR PEDESTAL DESIGN BY OTHERS. REFER TO STRUCTURAL

DESIGN.

2. TRACKERS PLACED IN UPLAND AREAS SHALL HAVE A MINIMUM OF 4" OF LOAM AND SEEDED WITH GRASS SEED MIXTURE, WITH MULCH.

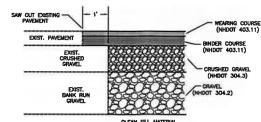

TYPICAL PAVEMENT SAWCUT DETAIL

NOT TO SCALE


- 1. SAWOUT THROUGH DEPTH OF PAVEMENT AT LEAST 1 FT, FROM EDGE OR GREATER IF REQUIRED.

 2. INSTALL AND COMPACT CRUISHED GRAVEL TO GRADE.

 3. PLACE BINDER COURSE.

 4. GRIBLO OR SAWOUT EASTING PAVEMENT 1 FT. WIDE TO A DEPTH NECESSARY TO PROPERLY MATCH NEW WEARING COURSE PAVEMENT.

 5. TACK COAT ALL ERSTING PAVEMENT SURFACES WITH EMULSIFIED ASPHALT (MS—1) PRIOR TO PLACING NEW PAVEMENT.

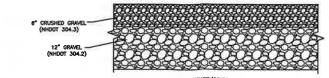

GRAVEL PARKING & TURN AROND CROSS-SECTIONS

PANEMENT NOTES:

1. PLACE COMMON FILL IN 12 INCH LIFTS, COMPACT COMMON FILL TO 85% MAXIMUM PROCTOR DENSITY.

2. PLACE GRAVEL IN MAXIMUM 8 INCH LIFTS, COMPACT TO 85% MAXIMUM PROCTOR DENSITY.

3. PLACE CRUSHED GRAVEL IN MAXIMUM 8 INCH LIFTS, COMPACT TO 85% MAXIMUM PROCTOR DENSITY.


- premary.
 To the current edition of the national electric safety code, state and local codes and ground electric code.

 Grown electric code.

 No open tready with side slopes of 1:1 magnam to a depth of 4—ft. installations deeper tha

ELECTRICAL & UNDERGROUND UTILITY TRENCH INSTALLATION DETAIL

NOT TO SCALE

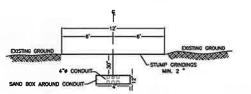

TEMPORARY IMPACT CONSTRUCTION PATH CROSS-SECTION

- Julies.

 1. INSTALL EROSION CONTROL BERN AROUND PERIMETER OF DISTURBANCE AREA AS SHOWN ON SHEET C-2.

 2. DIG TRENCH FOR UNDERGROUND CONDUIT.

 3. STOOGNEE MITERIAL WINN'T IEMPORARY IMPACT AREAS AS NEEDED. DO NOT STOCKPILE ANY MATERIAL IN WETLANDS OR WETLAND BUTPERS.
- MELLAPU SUPPLIS.

 MISTALL INDERGROUND CONDUIT 30° BELOW GRADE AND SURROUND IN SAND BOX.

 MISTALL A MENULUM OF 2—MOVES OF STUMP GROWINGS ALONG TRENCH DISTURBANCE. THE INTO EMSTING GRADE.

 MISE PATH FOR ALL CONSTRUCTION ACT

GENERAL UTILITY NOTES

- 1.) CONTRACTOR SHALL NOTIFY DIG-SAFE (1-888 344-7233) 72 HOURS PRIOR TO THE START OF
- CONSTRUCTION.
 ALL EXISTING UTILITY LOCATIONS ARE APPROXIMATE AS SHOWN. THE CONTRACTOR SHALL VERIFY THEIR LOCATIONS AND ELEVATIONS.

- LOCATIONS AND ELEVATIONS.

 THESE PLAN SHOWS ONLY THOSE FEATURES THAT WERE VISUALLY APPARENT ON THE DATE OF THE SURVEY. THE ABSENCE OF SUBSURFACE STRUCTURES, UTILITIES, ETC. FROM THIS PLAN, BUT IN EXISTENCE IS NOT INTENDED OR IMPLIED.


 ANY UTILITY POLES THAT NEED TO BE RELOCATED SHALL BE COORDINATED WITH EVERSOURCE OR VERIZON, WHO MEVER HAS CONTROL OVER THEM.

 PROPOSED UTILITIES TO CONNECT TO THE SITE SHALL BE OVERHEAD, WHILE ALL OTHER UTILITIES ARE TO BE UNDERGROUND, COORDINATE LOCATION OF UNDERGROUND UTILITIES AND TRANSFORMER PADS WITH EVERSOURCE AND OTHER PERTINENT UTILITY COMPANIES.

CONSTRUCTION DETAILS TAX MAP 240, LOT 49 SHAW DRIVE ROCHESTER NH

GNM SOLAR 17, LLC

SEPTEMBER 2022

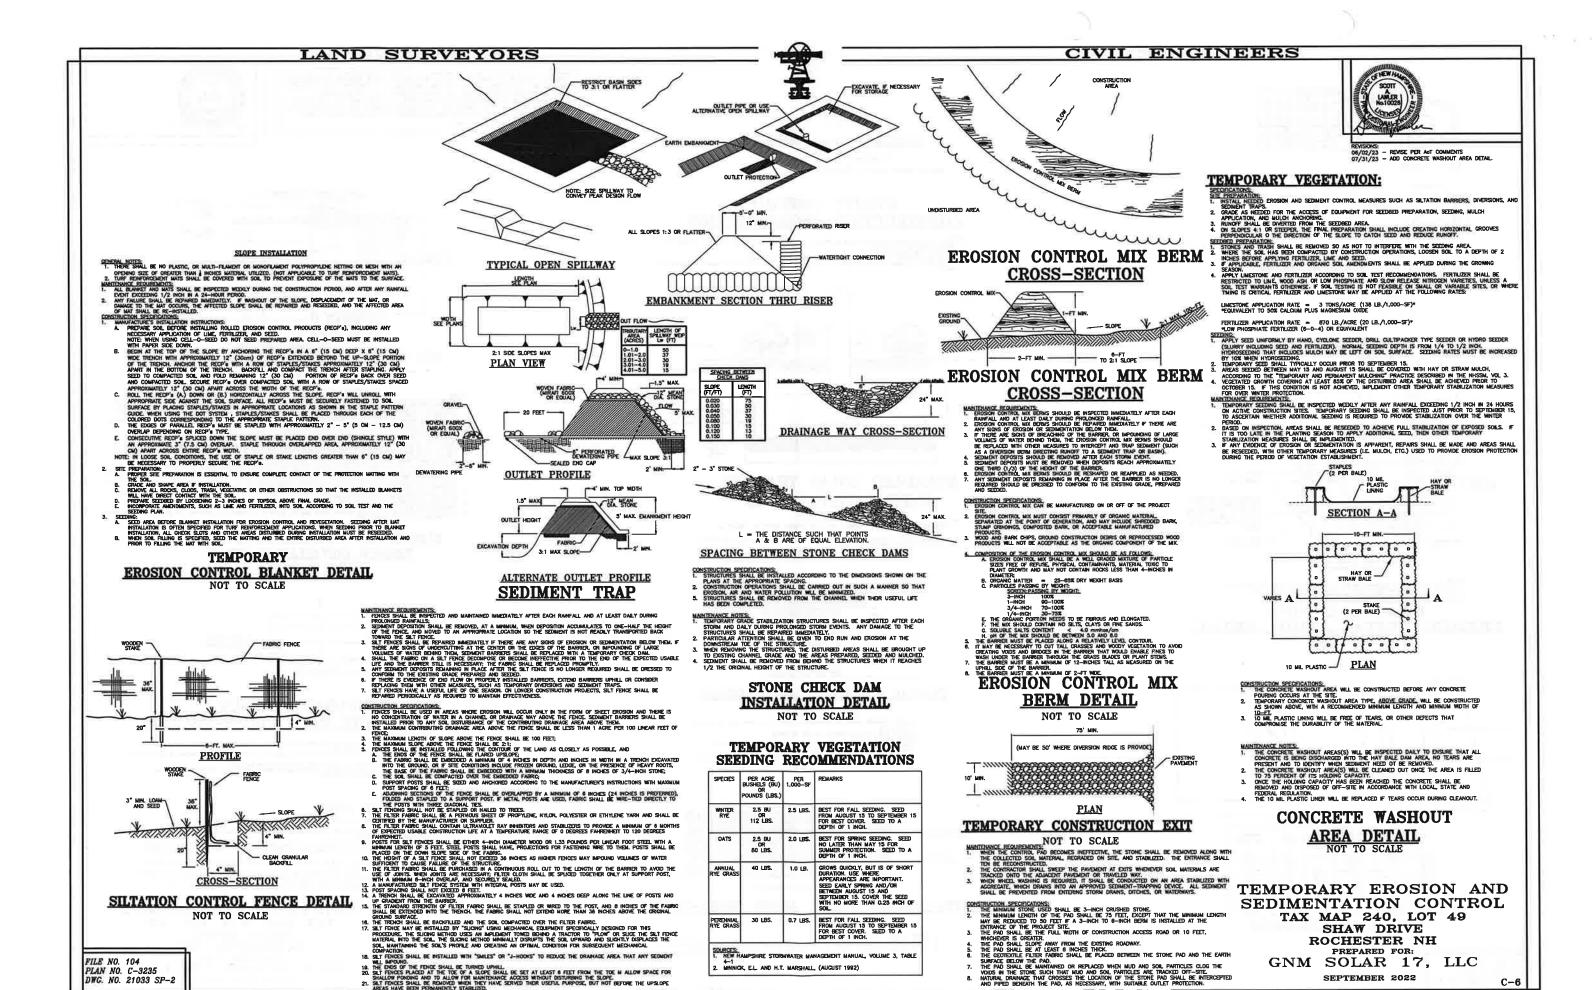

31 Mooney Street, Alton, N.H. 603-875-3948

FILE NO. 104

PLAN NO. C-3235 DWG. NO. 21033 SP-2

SOUR MAINTAINS ITE SUES PHAILE & INSTALLED WITH SMALLES OF INCHES THATCH.

18. SET FINESS SHALL BE THRISTED OF "2-HOOKS" TO REDUCE THE DRAWAGE AREA THAT ANY SEGMENT

19. THE DROSS SHALL BE THRISTON OF "1-HOOKS" TO REDUCE THE DRAWAGE AREA THAT ANY SEGMENT

20. SET FINESS SHALL BE THRIST DUPBLE.

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22. MINION, ELL AND H.T. MARSHALL (AUCIST 1992)

23. SET FINESS SHALL BE MAINTAID.

24. MINION, ELL AND H.T. MARSHALL (AUCIST 1992)

25. THE CEDERATIE FILET REPROSE SHALL BE AT LEAST 8 INCHES THREE SHALL BE PLACED BETWEEN THE STOKE PAOL OF SURFACE BELLOW AND PROBLEMENT THE STOKE PAOL OF SURFACE BELLOW AND PAOL OF SURFACE BELLOW A

2 Continental Blvd., Rochester, N.H. 603-335-3948

PREPARED FOR:

SEPTEMBER 2022

GNM SOLAR 17, LLC

C-6

DUST CONTROL PRACTICES:

- APPLY DUST CONTROL MEASURES AS NECESSARY TO MAINTAIN CONTROL OF DUST ON SITE.

 MATER APPLICATION:
 A) MOSTEN DEPOSED SOIL SURFACES PERCOICALLY WITH ADEQUATE WATER TO CONTROL DUST.
 B) AVOID EXCESSAR'S APPLICATION OF WATER THAT WOULD RESULT IN MOBILIZING SEDIMENT AND SUBSEQUENT
 OPPOSITION IN NATURAL WATERSOOGS.

- DEPOSITION IN NATURAL WATERSCORES.

 3. STOKE APPLICATION:
 A) COVER SURFACE WITH GRUSHED OR COARSE GRAVEL.
 B) IN AREAS NEAR WATERWAYS USE ONLY CHEMICALLY STABILIZED OR WASHED ACCREGATE.
 4. REFER TO "HEW HAMPSHIRE STORMWATER MANAGEMENT MANUAL, VOLUME 3 CONSTRUCTION PHASE EROSION AND SEDMENT CONTROLS, DECOMBER 2008" FOR OTHER ALLOWABLE DUST CONTROL PRACTICES (I.E. COMMERCIAL TACRIFIERS OR CHEMICAL TREATMENTS SUCH AS CALCIUM CHLORIDE, ETC.)

STOCKPILE PRACTICES:

- PROTECTION OF INACTIVE STOCKPIES.

 6. INACTIVE SUL STOCKPIES SHALL BE COVERED WITH ANCHORED TARPS OR PROTECTED WITH SOIL

 STABILIZATION INCASURES (TEMPORARY SEED AND MILLON OR OTHER TEMPORARY STABILIZATION PRACTICE) AND

 THE PROPERTY PERMETER SEMMENT BARRIERS (I.E. SILT PEHCE, ETC.) AT ALL TIMES.

 7. SHALL STOCKPIES OF CONCRETE ROBBEL ASSMALL TO OWNIGETE RUBBEL ADDRECATE MATERIAS. AND

 SHALP MATERIAS SHALL BE PROTECTED WITH TEMPORARY SEDMENT PERMETER BARRIERS (I.E. SILT PENCE,

 ETC.) AT ALL TIMES. FIRE MATERIAS ARE A SOURCE OF MUST, THEY SHALL ALSO BE COMPRED.

- PROTECTION OF ACTIVE STOCKPLES.

 8. ALL STOCKPLES SHALL BE SURGOUNDED WITH TOURPORARY LINEAR SEDIMENT BARRIERS (I.E. SLT FENCE, ETC.)
 PROOF TO THE OWNERT OF PROPORTATION. PERMETER BARRIERS SHALL BE MAINTAINED AT ALL TIMES, AND
 ADJUSTED AS NEEDED TO ACCOMMODATE THE DELIVERY AND REMOVAL OF MATERIAL FROM THE STOCKPLE
 HISTORY OF THE BARRIER SHALL BE INSPECTED AT THE DED OF EACH WORKING DAY.

 9. WHEN A STORM IS PREDICTION, STOCKPLES SHALL BE PROTECTED WITH AN MACHINEE PROTECTIVE COVERING.

PERMANENT VEGETATION SEEDING RECOMMENDATIONS

USE	MIXTURE	SPECIES	LBS./ACRE	LBS./ 1,000-SF
STEEP CUTS AND FILLS, BORROW AND DISPOSAL AREAS	A	TALL FESCUE CREEPING RED FESCUE; REDTOP TOTAL	20 20 2 42	0.45 0.45 0.05 0.95
WATERWAYS, EMERGENCY SPILLWAYS, AND OTHER CHANNELS WITH FLOWING WATER	۸	TALL FESCUE CREEPING RED FESCUE REDTOP TOTAL	20 20 2 42	0.45 0.45 0.05 0.95
LIGHTLY USED PARKING LOTS, ODD AREAS, UNUSED LANDS, AND LOW INTENSITY RECREATION SITES	A	TALL FESCUE CREEPING RED FESCUE REDTOP TOTAL	20 20 2 42	0.45 0.45 0.05 0.95
PLAY AREAS AND ATHLETIC FIELDS (TOPSOIL ESSENTIAL FOR GOOD TURF)	F	CREEPING RED FESCUE KENTUCKY BLUEGRASS TOTAL	50 50 100	1.15 1.15 2.30

SOURCES

1. NEW HAMPSHIRE STORMWATER MANAGEMENT MANUAL, VOLUME 3, TABLES 4-2 AND 4-3

2. MINNICK, EL. AND H.T. MARSHALL, (AUGUST 1092)

PERMANENT VEGETATION:

- SITE PREPARATION:

 1. INSTALL NEEDED EROSON AND SEDIMENT CONTROL MEASURES SUCH AS SILTATION BARRIERS, DIMESSIONS, AND SEDIMENT TRAPS.

 2. GRADE AS NEEDED FOR THE ACCESS OF EQUIPMENT FOR SEEDBED PREPARATION, SEEDING, MULCH AMPLICATION, AND MULCH AMPLICATION, AND MULCH AMPLICATION, AND MULCH AMPLICATION.

 3. RUNGET SHALL BE DIVERTED FROM THE SEEDBED AREA.

 4. ON SLOPES 4:1 OR STEEPER, THE FIRMAL PREPARATION SHALL INCLUDE CREATING HORIZONTAL GROOVES PERPENDICULAR TO THE DIRECTION OF THE SLOPE TO CATCH SEED AND REDUCE RUNGET.
- STERED PREPARATION:

 1. WORK LIME AND FERTILIZER INTO THE SOIL AS NEARLY AS PRACTICAL TO A DEPTH OF 4 MORE SWITH A DISC, SPRING TOOTH HARROW OR OTHER SUITABLE EQUIPMENT. THE FINAL HARROWING OPERATION SHALL BE ON THE CENTRAL CONTOUR. CONTINUE TILLAGE UNIT. A RESOURCE OF THE PROPERTY OF THE SUITABLE SHALL BUT CLAY AND SLIT SOILS SHALL BE COME. TO THE SUIFFACE ALL STUNES ZINCHES OR LARGER IN ANY DIMENSION. REMOVE ALL OTHER DEBMS, SUICH AS WIRE, CABLE, TIERE ROYS, CONCRETE CLOSS, LIMENS, TRASH OR OTHER UNSUITABLE MATERIAL.

 OR OTHER UNSUITABLE MATERIAL.

 INSPECT SEQUENCE JUST BEFORE SECOND. IF TRAFFIC HAS LEFT THE SOIL COMPACTED; THE ACCUMENT OF THE SUITABLE MATERIAL.

 INSPECT SEQUENCE JUST BEFORE SECOND. SECOND SITUATION OF THE SOIL COMPACTED; THE DEPTH OF 2 MONES BEFORE APPLYING PERTILIZER, LIME AND SECOND SITUATION OF SEASON.

 5. IF APPLICABLE, PERTILIZER AND ORGANIC SOIL AMERICANETS SHALL BE APPLIED DURING THE GROWING SEASON.

- IF APPLICABLE, FERTILIZER AND ORGANIC SOIL AMENDMENTS SHALL BE APPLIED DURING THE GROWNING SEASON.

 APPLY LINESTONE AND FERTILIZER ACCORDING TO SOIL TEST RECOMMENDATIONS. FERTILIZER SHALL BE RESTRICTED TO LINE WOOD AS HOR LOW PHOSPAHATE AND SLOW RELEASE.

 NITROGEN VARETIES, UNLESS A SOIL TEST WARRANTS OTHERWING. IF SOIL TESTING IS NOT FEASIBLE ON SHALL OR VARIABLE SITES, OR WHERE TIMING IS ORTICAL FERTILIZER AND LINESTONE MAY BE APPLIED AT THE FOLLOWING RATES:

LIMESTONE APPLICATION RATE = 3 TONS/ACRE (138 LB./1,000-SF)° "EQUIVALENT TO SOX CALCIUM PLUS MACNESIUM OXIDE

- SEDING.

 1. INCOLLATE ALL LEGUME SEED WITH THE CORRECT TYPE OF INCOLLANT.

 1. INCOLLATE ALL LEGUME SEED WITH THE CORRECT TYPE OF INCOLLANT.

 2. APPLY SEED UNFORMLY BY HAND, CYCLONE SEDDER, DRILL CULTIPACKER TYPE SEEDER OR HYDROSEDER (SLURRY INCLUDING SEED AND FERTILIZER), NORMAL SEEDING DPTH IS FROM 1/4 TO 1/2 NORM. HYDROSEDOR IS AND FERTILIZER), NORMAL SEEDING PHILLIPS OF SERVICE OF THE SEED SEEDING PHILLIPS OF SERVICE OF SE

- HURROSEEDING.

 1. WHEN HYDROSEEDING (HYDRAULIC APPLICATION), PREPARE THE SEEDRED AS SPECIFIED ABOVE OR BY HAND RAUME TO LOOSEN AND SMOOTH THE SOIL AND REMOVE SURFACE STONES LARGER THAN 2 INCHES IN DIAMETER.

 2. SLOPES BUST SE NO STEEPER THAN 2:1 (2 FEET HORZONTALLY BY 1 FOOT VERTICALLY.

 3. LINE AND FERTILIZER MAY BE APPLIED SMUTHAGUISLY WITH THE SEED. THE USE OF FIBER MULCH ON CRITICAL MEANS IS NOT RECOMMENDED (MILESS IT IS USED TO HOLD STRAW OR HAY). BETTER PROTECTION IS GANNED BY USING STRAW MULCH AND HOLDING IT WITH ADRESSY MATERIALS OR SOO POUNDS PER ADDE OF WOOD FIBER MULCH.

 4. SEEDING RATES MUST BE INCREASED BY 10% WHEN HYDROSEEDING.

- MAINTENANCE PROUBERENTS.

 1. PERMANENT SEEDED AREAS SHALL BE INSPECTED AT LEAST MONTHLY DURING THE COURSE OF CONSTRUCTION. INSPECTION, MAINTENANCE AND CORRECTIVE ACTIONS SHALL CONTINUE UNIT. THE DIMER ASSUMES PERMANENT OFFENTION OF THE SITE.

 2. WITH THE DIMER ASSUMES PERMANENT OFFENTION OF THE SITE.

 3. BASED ON INSPECTION, AREAS SHALL BE RESERVED OF TYPE OF GRASS COVER.

 3. BASED ON INSPECTION, AREAS SHALL BE RESERVED TO ACHIEVE FULL STRAULZATION OF EMPOSED SOILS.

 4. AT A MINIMUM BOST OF THE SOIL SUFFACE SHALL BE COVERED BY VEGETATION.

 5. IF ANY EMBENCE OF EROSION OR SCHIEDITATION IS PAPARENT, REPAIRS SHALL BE MADE AND AREAS SHALL BE RESERVED, WITH OTHER TEMPORARY MEASURES (I.E. MULCH, ETC.).

 10. DED TO PROMODE CRESSION PROTECTION DURING THE PERSON OF COLUMN OF THE PROMODE PROSEDED AND AREAS SHALL BE RESERVED. WITH OTHER TEMPORARY MEASURES (I.E. MULCH, ETC.).

CONSTRUCTION PHASING:

- GENERAL
 CONSTRUCTION PHASING:

 1. STABLIZZIONE
 A STER BUILD STRUCTUS WITH IT IS IN A COUDTION IN WHICH THE SOL ON STRUCTUS CONTINUES ON UNIVERSAL BESTON UNITED THE COUNTINUE AND A STRUCTUS OF A 10-YEAR STONE CHAPT, SUCH AS BUT NOT LIMITED TO.
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 DEBANES TO EXPOSED ON DETURBED SOUL SHALL BE TEMPORARIM STABLIZED AS SOON AS PRACTICABLE BUS HOLIZED THAN 3 DAYS FROM THE TIME OF INITIAL BUS DAYS FROM THE SANLEST FROM THE SANLEST FROM THE APPROVED GROWING AND DEPOSITION OF THE SANLEST FROM THE APPROVED GROWING AND DEPOSITION OF THE APPROVED GROWING AND DEPOSITION OF THE OFFICE THE TIME OF INITIAL BUS DAYS FROM THE APPROVED GROWING AND DEPOSITION OF THE OFFICE THE TIME OFFI THE APPROVED GROWING AND THE APPROVED GR

 - FINISHED GRADING.

 23. THE PROJECT SHALL BE CONSTRUCTED TO MEET ALL REQUIREMENTS AND INTENT OF RSA 430:53 AND CHAPTER ARG 3800 RELATIVE TO INVASIVE SPECIES.

ABOVE NOTES EXCERPTED, ADAPTED AND REPERENCED FROM "NEW HAMPSHIRE STORMMATER MANAGEMENT MANUAL, VOLUME 3 CONSTRUCTION PHASE EROSION AND SEDIMENT CONTROLS, DECEMBER 2008" (NHSMM, VOL. 3)

CIVIL ENGINEERS

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REVISIONS: 06/2/23 - REVISE PER AGT COMMENTS

PROJECT SPECIFIC CONSTRUCTION PHASING:

- REFER TO THE "GENERAL CONSTRUCTION PHASING" NOTES PRIOR TO COMMENCING CONSTRUCTION IN ACCORDANCE WITH THE FOLLOWING
- COMMERCING CONSTRUCTION AND CONTINUES THE POLLOWING PHASING. THE "PERSON CONSTRUCTION AND STREET CONTINUES THE CONTINUES AND CON

- , SIOCOMPLE STREPPED TO-SUR, AND CUT MATERIAL TO BE REUSED ON STRE IN AN APPROPRIATE LOCATION IN ACCORDANCE WITH THE SSELL STOCKPETS.

 PRACTICES.

 PROPERTY OF THE RECESSARY CUTS AND FILLS TO SUBGRADE IN PARRING AND FORWARD APPLICATION.

 PROPERTY OF THE P

- BASE COURSE) WITHIN 3 DAYS OF ACHIEVING PRINSHED SUBGRADE
 LEVATIONS.

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 LEVATIONS.

 CREATER SET SUBGRADES AS SOON AS POSSIBLE AFTER THE
 HISTALLATION OF THE CRANUEL BASE AND CRUSHOD GANKEL, IN GRORE TO
 LIMIT THE SOLE BROSON AND POLLUTION OF THE CRANUE. MATERIALS WITH
 ORGANIC MATERIALS. IN NO CASE SHALL AREAS TO BE PANED BE LEFT
 UNPROTECTED THROUGH OUT THE WINTER NORTHS.

 ALL DISTURBED AREAS SHALL BE STRAILLED AS SOON AS POSSIBLE. IN
 NO CASE SHALL ANY DISTURBED AREAS SHALL BE STRAILLED AS SOON AS POSSIBLE. IN
 NO CASE SHALL ANY DISTURBED AREAS BE LEFT UN-STABILIZED FOR
 LONGER THAN 21 DAYS. IF NECESSARY TEMPORARY STABILIZATION
 MEASURES AS DISCUSSED IN THE "CONGRAL CONSTRUCTION PHASMIC
 MONITOR. AND MISSIAN VOX 3 SHOULD BE EMPLOYED.

 MAINTENANCE STRUCTION OF THE PRAYERY AND PRIMARENT SOURCES, THE PROPERTY SEMINATION.

 LEVEN CONSTRUCTION OF THE PRAYERY AND PRIMARELY AND ANNUALLY,
 EROSON CONTROL AND STORWARTER MANAGEMENT PRACTICES SHOULD BE
 INSPECTED WEDGY, AFTER EVERY 1/2 INCH OF RUMFALL, AND ANNUALLY,
 EROSON CONTROL AND STORWARTER MANAGEMENT PRACTICES WHEN IT
 REACHES PRESCRIBED THE PRISONOUS DISCUSSED IN THE DETAILS FOR EACH
 PRACTICE.

 ALL DAWS DESCRIBED THE PRISONOUS DISCUSSED IN THE DETAILS FOR EACH
 PRACTICE.

 ALL DAWS DESCRIBED THE PROPARY PARAMETS SEDIMENT, EROSON CONTROL

 ALL DAWS DESCRIBED THE PROPARY PARAMETS.
- AND ADMINISTRATION OF THE PERMANENT SEMBERT, EROSION CONTROL AND STORMMARED MARKED PRIMARIENT SEMBERT, EROSION CONTROL AND STORMMARED MARKED PRIMARIENT PRACTICES SHOULD BE REPARED OR REPLACED MARKED AND PROMISED FOR PROPERTY BHARL BE OBSECTED OF PROPERTY BHARL BE OF STEPHIOLOGY CORPORATION FOR THE THE PROPERTY BHARLED STABLED THE STEPHIOLOGY CONTROL PROPERTY SEMBERT ON THE OWNER OF THE STEPHIOLOGY CONTROL PROPERTY SEMBERT ON THE OWNER AND EROSION CONTROL PRACTICES SHALL BE REMOVED. ANY DISTURBANCE CREATED DURING REMOVAL SHALL BE REPARED IN AN APPROPRIATE MANIME.

WINTER STABILIZATION & CONSTRUCTION PRACTICES:

- MANTEMANCE REQUERIENTS:

 1. MANTEMANCE MEASURES SHALL BE PERFORMED THROUGHOUT CONSTRUCTION, INCLUDING OVER THE WINTER PERIOD. AFTER EACH RAMFALL, SHOWSTORM, OR PERIOD OF THAMMIG AND RUNOFF, THE SITE CONTRACTOR SHALL CONDUCT INSPECTION OF ALL INSTALLED EROSIGNER CONTROL PRACTICES AND PERFORM REPAIRS AS NEEDED TO INSURE THEM CONTRICED FUNCTION.

 2. FOR MANY MACE OF THE WINTER SEASON, THE CONTRACTOR SHALL CONDUCT AN INSPECTION IN THE SPRING TO ASSENTIAN THE CONTROL OF AN INSPECTION IN THE SPRING TO ASSENTIAN THE CONTROL OF A INSPECTION IN THE SPRING TO ASSENTIAN THE CONTROL OF A INSPECTION AND REPAIR ANY DAMAGED AREAS OR BARE SPOTS AND RESSED AS REQUIRED TO ACHIEVE AN ESTABLISHED VECETATIVE COVER (AT

- VEGETATION AND REPAIR ANY DAMAGED AREAS OR BARE SPOTS AND RESERVED AS RECURRED TO ACHIEVE AN ESTABLISHED VEGETATIVE COVER (AT LEAST 85% OF AREA VEGETATED WITH HEALTHY, VICOROUS GROWTH.)

 SPECIAL DRIVES.

 THE FOLLOWING STABILIZATION TECHNIQUES SHALL BE EMPLOYED DURING THE PERIOD FROM COTIORER 15 THROUGH MAY 13.

 1. THE AREA OF DEPOSED, UNSTABILIZED SOIL SHALL BE LIMITED TO 1_ACRE AND SHALL BE PROPOSED SOIL SHALL BE LIMITED TO 1_ACRE AND SHALL BE PROPOSED OF THE AREA OF DEPOSED, UNSTABILIZED SOIL SHALL BE LIMITED TO 1_ACRE AND SHALL BE PROPOSED SOIL SHALL BE LIMITED TO 1_ACRE AND SHALL BE PROPOSED SOIL SHALL BE LIMITED TO 1_ACRE AND SHALL BE PROPOSED SOIL SHALL BE LIMITED TO 1_ACRE AND SHALL BE PROPOSED SOIL SHALL BE THAN 15 T

PERMANENT EROSION AND SEDIMENTATION CONTROL TAX MAP 240, LOT 49 SHAW DRIVE ROCHESTER NH PREPARED FOR: GNM SOLAR 17, LLC

SEPTEMBER 2022

FILE NO 104

PLAN NO. C-3235

DWG. NO. 21033 SP-2