

LEGEND		
DESCRIPTION	EXISTING	PROPOSED
SANITARY SEWER	⑤ — s — ⑤	⑤ — 8" PVC — ⑤
FORCE MAIN	— FM —	— 8" SFM —
WATER MAIN	— W —	— 6" W —
TEMPORARY WATER		— 6" W —
STORM DRAIN	⑩ — d — ⑩	⑩ — 12" RCP — ⑩
GAS	— G —	— 4" G PL —
ELECTRIC	— E —	— E —
UNDERGROUND ELECTRIC	— UGE —	— UGE —
TELEPHONE	— T —	— T —
GRINDER PUMP	⊙	● GP
SANITARY SEWER MANHOLE	⊙	● SMH
STORM DRAIN MANHOLE	⊙	● SDMH
ELECTRICAL MANHOLE	⊙	● EMH
TELEPHONE MANHOLE	⊙	● TMH
AIR RELEASE VALVE MANHOLE	⊙	● ARMH
FORCE MAIN CLEANOUT MANHOLE	⊙	● FMCO
CLEANOUT	⊙	● CO
CATCH BASIN	□	■ CB
CATCH BASIN (CURB INLET)	□	■ CB
HYDRANT	⊙	●
TEMPORARY HYDRANT		⊙
GATE VALVE	⊙	●
CHECK VALVE	⊙	●
CURB STOP	⊙	●
BUTTERFLY VALVE	⊙	●
BALL VALVE	⊙	●
REDUCER	⊙	●
CAP OR PLUG	⊙	●
GAS GATE VALVE	⊙	●
UTILITY POLE	⊙	●
GUY POLE	⊙	●
LIGHT POST	⊙	●
EDGE OF PAVEMENT	— EOP —	— EOP —
EDGE OF UNPAVED ROAD	— — — —	— — — —
CURB	— CURB —	— CURB —
SIDEWALK	— SIDEWALK —	— SIDEWALK —
RAILROAD	— RAILROAD —	— RAILROAD —
STONE WALL	— STONE WALL —	— STONE WALL —
RETAINING WALL	— RET. WALL —	— RET. WALL —
FENCE	— FENCE —	— FENCE —
INDIVIDUAL DECIDUOUS TREE	⊙	●
INDIVIDUAL EVERGREEN TREE	⊙	●
TREE LINE	— TREE LINE —	— TREE LINE —
SURVEY MARKER	⊙	●
PROPERTY LINE	— PROPERTY LINE —	— PROPERTY LINE —
EASEMENT LINE	— EASEMENT LINE —	— EASEMENT LINE —
LIMIT OF WORK	— LIMIT OF WORK —	— LIMIT OF WORK —
APPROX. LIMIT OF REFUSE	— APPROX. LIMIT OF REFUSE —	— APPROX. LIMIT OF REFUSE —
SPOT ELEVATIONS	x 141.5	x 141.5
CONTOUR LINES	— 56 —	— 56 —
DEPRESSION CONTOUR LINES	— DEPRESSION CONTOUR LINES —	— DEPRESSION CONTOUR LINES —
HOUSE NUMBER	— HOUSE NUMBER —	— HOUSE NUMBER —
FLOOR ELEVATION	FL=56.7	FL=56.7
SILL ELEVATION	S=56.7	S=56.7
WETLAND	— WETLAND —	— WETLAND —
WETLAND FLAGS	— WETLAND FLAGS —	— WETLAND FLAGS —
RIP RAP	— RIP RAP —	— RIP RAP —
STATE HIGHWAY STATION	⊙	●
SURFACE MOUNTED DELINEATOR	⊙	●
GUARD POST	⊙	●
BOLLARD	⊙ B	● B
SIGN	— SIGN —	— SIGN —
BENCH MARK	⊙	●
AUGER	⊕ A-1	⊕ A-1
PERCOLATION TEST	⊕ 1	⊕ PT-1
TEST PIT	⊕ 1	⊕ TP-1
BORING	⊕ B-10	⊕ B-11
PROBE	⊕ P-10	⊕ P-11
GROUNDWATER MONITORING WELL	⊕ WS-1	⊕ WS-1
GAS MONITORING WELL	⊕ GMW-10	⊕ GMW-10
GAS VENT	⊕ GV	⊕ GV
HAY BALES	— HAY BALES —	— HAY BALES —
ROCK OUTCROP	— ROCK OUTCROP —	— ROCK OUTCROP —
DRAINAGE DITCH / SWALE	— DRAINAGE DITCH / SWALE —	— DRAINAGE DITCH / SWALE —

NOTE: ITEMS SHOWN IN THE LEGEND MAY NOT BE PRESENT IN THESE PLANS

ABBREVIATIONS

AC	ASBESTOS CEMENT PIPE
ACOMP	ASPHALT COATED CORRUGATED METAL PIPE
ARV	ARR RELEASE VALVE
ASTM	AMERICAN SOCIETY FOR TESTING AND MATERIALS
BC	BITUMINOUS CONCRETE
BIT	BITUMINOUS
BLDG	BUILDING
BM	BENCH MARK
BO	BLOW OFF
BY	BUTTERFLY VALVE
CATV	CABLE TELEVISION
CC	CONCRETE CURB
CI	CAST IRON
CL	CENTERLINE
CL	CEMENT LINED
CMP	CORRUGATED METAL PIPE
CONC	CONCRETE
CU FT	CUBIC FEET
CY	CUBIC YARD
D	STORM DRAIN, DEPTH FROM RIM TO INVERT
DI	DROP INLET, DUCTILE IRON
DIA	DIAMETER
DMH	DRAIN MANHOLE
DWG	DRAWING
E	EAST, ELECTRIC
EA	EACH
EF	EACH FACE
EL	ELEVATION
ELEV	ELEVATION
EOP	EDGE OF PAVEMENT
EW	EACH WAY
EXIST	EXISTING
FLG	FLANGE
FRP	FIBERGLASS REINFORCED PLASTIC
FT	FEET, FOOT
G	NATURAL GAS
GALV	GALVANIZED
GC	GRANITE CURB
GR	GRANITE
HC	HOUSE CONNECTION
HORIZ	HORIZONTAL
HP	HIGH PRESSURE
HYD	FIRE HYDRANT
I	INVERT
INV	INVERT
ID	INSIDE DIAMETER
IP	IRON PIPE
LB	POUND
LF	LINEAR FEET
LS	LUMP SUM
MAX	MAXIMUM
MB	MAIL BOX
MECH	MECHANICAL
MH	MANHOLE
MIN	MINIMUM
MISC	MISCELLANEOUS
MJ	MECHANICAL JOINT
N	NORTH
NE	NORTH EAST
NHDES	NEW HAMPSHIRE DEPARTMENT OF ENVIRONMENTAL SERVICES
NHDOT	NEW HAMPSHIRE DEPARTMENT OF TRANSPORTATION
NW	NORTH WEST
NF	NOT FOUND
NO OR #	NUMBER
OD	OUTSIDE DIAMETER
POCP	PRESTRESSED CONCRETE CYLINDER PIPE
PE	PLAIN END, POLYETHYLENE
t	PROPERTY LINE
PL	PLATE
PS	PUMP STATION
PVC	POLYVINYL CHLORIDE
PVMT	PAVEMENT
RCP	REINFORCED CONCRETE PIPE
ROW	RIGHT-OF-WAY
RQD	ROCK QUALITY
S	SEWER, SOUTH
SE	SOUTH EAST
SECT	SECTION
SF	SQUARE FEET
SHT	SHEET
SPEC	SPECIFICATIONS
SO FT	SQUARE FEET
SS	SEWER SERVICE, STAINLESS STEEL
STA	STATION
STL	STEEL
SW	SIDEWALK, SOUTH WEST
T	HYDROSTATIC THRUST, TELEPHONE
TBM	TEMPORARY BENCH MARK
THK	THICK (NESS)
TYP	TYPICAL
UP	UTILITY POLE
VC	VITRIFIED CLAY
VERT	VERTICAL
W	WEST, WEST
WI	WITH
W/O	WITHOUT

GENERAL CONSTRUCTION NOTES

- THE CONTRACTOR SHALL CALL DIGSAFE AT 811 OR 1-888-344-7233 AT LEAST 72 HOURS, SATURDAYS, SUNDAYS, AND HOLIDAYS EXCLUDED, PRIOR TO EXCAVATING AT ANY LOCATION. A COPY OF THE DIGSAFE PROJECT REFERENCE NUMBER(S) SHALL BE GIVEN TO THE OWNER PRIOR TO EXCAVATION.
- LOCATIONS OF EXISTING PIPES, CONDUITS, UTILITIES, FOUNDATIONS AND OTHER UNDERGROUND OBJECTS WERE OBTAINED FROM THE BEST AVAILABLE RECORDS AND ARE NOT WARRANTED TO BE CORRECT. THE CONTRACTOR SHALL HAVE NO CLAIM ON THAT ACCOUNT SHOULD THEY BE OTHER THAN SHOWN.
- LOCATIONS OF EXISTING UTILITY AND PROPERTY LINE INFORMATION, EDGE OF PAVEMENT, UTILITY POLE LOCATIONS, CONSTRUCTION EASEMENT, AND PERMANENT EASEMENT WERE OBTAINED BY INFORMATION PROVIDED BY THE OWNER.
- ASSESSORS INFORMATION REPRESENTED ON THESE DRAWINGS IS INCLUDED FOR ILLUSTRATIVE PURPOSES ONLY. ASSESSORS INFORMATION IS NOT INTENDED TO BE AN AUTHORITATIVE RECORD OF PROPERTY BOUNDARIES OR A SOURCE OF INFORMATION FOR AN ACTUAL SURVEY OR LEGAL DESCRIPTION OF THE PROPERTY. NO WORK HAS BEEN PERFORMED TO DETERMINE THE DEPICTED PROPERTY LINES AND THEREFORE, THESE DRAWINGS ARE NOT INTENDED TO DELINEATE ANY EXISTING OR PROPOSED STRUCTURES, FEATURES OR BOUNDARIES RELATIVE TO PROPERTY LINES. AUTHORITATIVE RECORDS OF PROPERTY LINES MAY BE LOCATED AT THE STATE OR MUNICIPAL AGENCY RESPONSIBLE FOR MAINTAINING PUBLIC RECORDS IN WHICH THE PARCEL IS LOCATED. LEGALLY AUTHORITATIVE MAPS OF PROPERTY LINES MAY ONLY BE PRODUCED BY A PROFESSIONAL LAND SURVEYOR.
- CONTRACTOR SHALL HIRE INDEPENDENT UTILITY LOCATOR TO VERIFY LOCATION OF ALL UTILITIES WITHIN THE PROPOSED CONSTRUCTION EASEMENT PRIOR TO CONSTRUCTION.
- TEST PITS TO LOCATE EXISTING UTILITIES MAY BE ORDERED BY THE ENGINEER.
- CONTRACTOR SHALL SECURE THE SITE WITH TEMPORARY CHAIN LINK FENCE. ALL OPEN EXCAVATIONS SHALL BE SECURED WITH TEMPORARY BARRICADES AND ORANGE SAFETY FENCE AT END OF EACH WORK DAY. OWNER SHALL NOT BE LIABLE FOR THEFT OR DAMAGE TO CONTRACTOR'S STORED MATERIALS OR EQUIPMENT.
- STONE WALLS, FENCES, MAIL BOXES, SIGNS, CURBS, LIGHT POLES, ETC. SHALL BE REMOVED AND REPLACED AS NECESSARY TO PERFORM THE WORK. UNLESS OTHERWISE INDICATED, ALL SUCH WORK SHALL BE INCIDENTAL TO CONSTRUCTION OF THE PROJECT.
- ALL AREAS DISTURBED BY THE CONTRACTOR BEYOND PAYMENT LIMITS SHALL BE RESTORED AT NO ADDITIONAL COST TO THE OWNER.
- THE CONTRACTOR SHALL NOT STORE ANY APPARATUS, MATERIALS, SUPPLIES, OR EQUIPMENT ON DRAINAGE STRUCTURES OR WITHIN 100 FEET OF WETLANDS.
- THE CONTRACTOR SHALL MAINTAIN LOCAL TRAFFIC ACCESS TO ALL STREETS THROUGHOUT THE DURATION OF THE PROJECT.
- CONTRACTOR SHALL MAINTAIN EXISTING FLOWS IN THE SYSTEM BYPASSING AS NECESSARY TO PREVENT SURCHARGING, AT NO ADDITIONAL COST TO THE OWNER, AS APPROVED BY THE ENGINEER. SEE SECTION 01 14 19.13 TEMPORARY BYPASS PUMPING SYSTEM AND SECTION 01 14 19.22 HANDLING EXISTING FLOWS.
- THE CONTRACTOR SHALL NOT TRACK OR SPILL EARTH, DEBRIS, OR OTHER CONSTRUCTION MATERIAL ON PUBLIC OR PRIVATE STREETS. THE CONTRACTOR SHALL BE RESPONSIBLE FOR THE IMMEDIATE ASSOCIATED CLEAN UP.
- CONTRACTOR SHALL REMOVE AND DISPOSE OF ALL DEBRIS AND EXCESS EXCAVATED MATERIAL FROM WITHIN THE CONSTRUCTION LIMIT OF WORK TO A SUITABLE SITE PROVIDED BY THE CONTRACTOR, IN COMPLIANCE WITH ALL STATE AND CITY REGULATIONS.
- ALL AREAS THAT ARE EXCAVATED, FILLED, OR OTHERWISE DISTURBED BY THE CONTRACTOR SHALL BE LOAMED, GRADED, LIMED, FERTILIZED, SEEDED, AND MULCHED, UNLESS OTHERWISE NOTED. THE TOP SIX INCHES OF SOIL SHALL BE LOAM. THE CONTRACTOR SHALL GRADE TO MEET EXISTING CONDITIONS.
- ALL PAVEMENT DISTURBED BY THE CONTRACTOR'S OPERATIONS SHALL BE REPLACED IN ACCORDANCE WITH THE SPECIFICATIONS AND AS SHOWN ON THE DRAWINGS. CONTRACTOR SHALL MATCH EXISTING GRADES TO THE EXTENT POSSIBLE WHERE EXISTING PAVEMENT IS REMOVED AND REPLACED.
- IN PAVED AREAS THE TOPS OF THE MANHOLE COVERS SHALL BE SET FLUSH WITH THE PAVED SURFACE.
- ALL PENETRATIONS, PIPES AND CONDUITS INTO THE WETWELL SHALL HAVE GASKETS/FITTINGS ON BOTH ENDS TO MAKE EXPLOSION PROOF AND GAS AND WATER TIGHT.
- ALL WALL SLEEVES AND WALL CASTINGS SHALL HAVE WATERSTOPS. SEE MECHANICAL DRAWINGS FOR LOCATIONS OF PENETRATIONS.
- A MINIMUM OF 5 FEET OF COVER OR 2 INCHES OF CELLULAR GLASS INSULATION REQUIRED ON ALL LIQUID CARRYING PIPES.
- REFER TO SPECIFICATION SECTION 31 00 00 AND CIVIL DETAILS FOR PIPE AND STRUCTURE BEDDING, COMPACTION, AND BACKFILL REQUIREMENTS.
- CONCRETE USED FOR PIPE ANCHOR BLOCKS, BACKING, PIPE CRADLES, ARCHES, AND FILL SHALL HAVE A MINIMUM COMPRESSIVE STRENGTH OF 3000 PSI AT 28 DAYS.
- APPROVED JOINT RESTRAINT METHODS SHALL BE PROVIDED FOR ALL UNDERGROUND PIPING WHERE ANY BENDS, TEES, PLUGS, OR WYES ARE INSTALLED. CONCRETE THRUST BLOCKS, ANCHOR BLOCKS, AND TIE RODS MAY BE USED FOR 6-INCH AND 8-INCH PIPE WHERE JOINT RESTRAINT IS NOT FEASIBLE. FOR THRUST BLOCK DETAILS AND MINIMUM BLOCK BEARING AREAS, SEE DETAILS AND SPECIFICATIONS.
- ALL STRUCTURES AND PIPING LOCATED ADJACENT TO ANY TRENCH OR OPEN CUT EXCAVATION SHALL BE PROTECTED AND FIRMLY SUPPORTED BY THE CONTRACTOR UNTIL THE EXCAVATION IS BACKFILLED. DAMAGE TO ANY SUCH STRUCTURES CAUSED BY OR RESULTING FROM THE CONTRACTOR'S OPERATIONS SHALL BE REPAIRED AT THE CONTRACTOR'S EXPENSE. ALL UTILITIES REQUIRING REPAIR, RELOCATION, OR ADJUSTMENT AS A RESULT OF THE PROJECT SHALL BE COORDINATED THROUGH THE OWNER.
- ALL EXISTING UTILITIES ENCOUNTERED DURING CONSTRUCTION SHALL BE EITHER NOT DISTURBED, REPLACED, OR RELOCATED. ALL UTILITIES WHICH ARE REPLACED OR RELOCATED SHALL BE CONSTRUCTED OF NEW MATERIALS APPROVED BY THE ENGINEER AND SIMILAR TO THOSE OF THE EXISTING UTILITY.
- CONTRACTOR SHALL FULLY CLEAN THE INTERIORS OF BOTH WETWELLS. CLEANING SHALL INCLUDE THE USE OF HYDRAULIC CLEANING EQUIPMENT AND VACUUM TRUCKS TO REMOVE SLUDGE, DIRT, GREASE, ETC. FROM THE INTERIOR WALLS AND BOTTOMS OF THE WET WELL. ANY GRATING IN THE WETWELLS SHALL ALSO BE CLEANED. THE WETWELL SHALL BE PUMPED TO ALLOW THE WATER LEVEL TO DROP SO THAT THE ENTIRE WETWELL INTERIOR IS VIEWABLE. CLEANING SHALL ALSO INCLUDE REMOVAL OF ALL FOREIGN OBJECTS OR DEBRIS FROM THE WET WELLS WHICH SHALL BE REMOVED EITHER MANUALLY OR MECHANICALLY. ALL DEBRIS, SOLIDS OR SEMI-SOLIDS RESULTING FROM THE CLEANING OPERATIONS SHALL BE REMOVED FROM THE SITE AND DISPOSED OF AT A LEGALLY PERMITTED SITE FOR THAT PURPOSE. AT A MINIMUM ALL MATERIALS SHALL BE REMOVED FROM THE SITE AT THE END OF EACH WORKDAY. UNDER NO CIRCUMSTANCES WILL THE CONTRACTOR BE ALLOWED TO ACCUMULATE DEBRIS, ETC., ON THE SITE OF WORK BEYOND THE STATED TIME, EXCEPT IN TOTALLY ENCLOSED CONTAINERS AND AS APPROVED BY THE ENGINEER. CONTRACTOR SHALL BE RESPONSIBLE FOR ALL FEES AND TIPPING CHARGES FOR DISPOSAL. THE CONTRACTOR MUST FOLLOW ALL CURRENT APPLICABLE LOCAL, STATE AND FEDERAL RULES AND LAWS REGARDING THE APPROPRIATE DISPOSAL OF WASTE MATERIALS FROM CLEANING OPERATIONS. UNDER NO CIRCUMSTANCES SHALL SEWAGE OR SOLIDS REMOVED IN THE CLEANING PROCESS BE DUMPED INTO STREETS, DITCHES, CATCH BASINS, STORM DRAINS, SEWER MANHOLES, WETWELLS, CLEANOUTS, OR DUMPS.
- WRITTEN DIMENSIONS IN THE CONTRACT DRAWINGS SHALL PREVAIL OVER SCALE DISTANCES. REPORT ANY DISCREPANCIES IMMEDIATELY TO THE ENGINEER.
- ELEVATIONS REFERENCED ARE NORTH AMERICAN VERTICAL DATUM OF 1988 (NAVD88).
- POTABLE WATER IS NOT AVAILABLE ON SITE.

Project:
CITY OF ROCHESTER, NH



LEDGEVIEW SEWER PUMP STATION
UPGRADE

54A LEDGEVIEW DRIVE
ROCHESTER, NH 03868



Weston & Sampson Engineers, Inc.
100 International Drive, Suite 152
Portsmouth, NH 03801
978.532.1900 800.SAMPSON
www.westonandsampson.com

Consultants:

Revisions:

No.	Date	Description
1	03/07/2024	90% DESIGN REVIEW
2	04/24/2024	ISSUED FOR BIDDING

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Date: 4 / 24 / 2024

Drawn By: AJB

Reviewed By: JMS

Approved By: CMP

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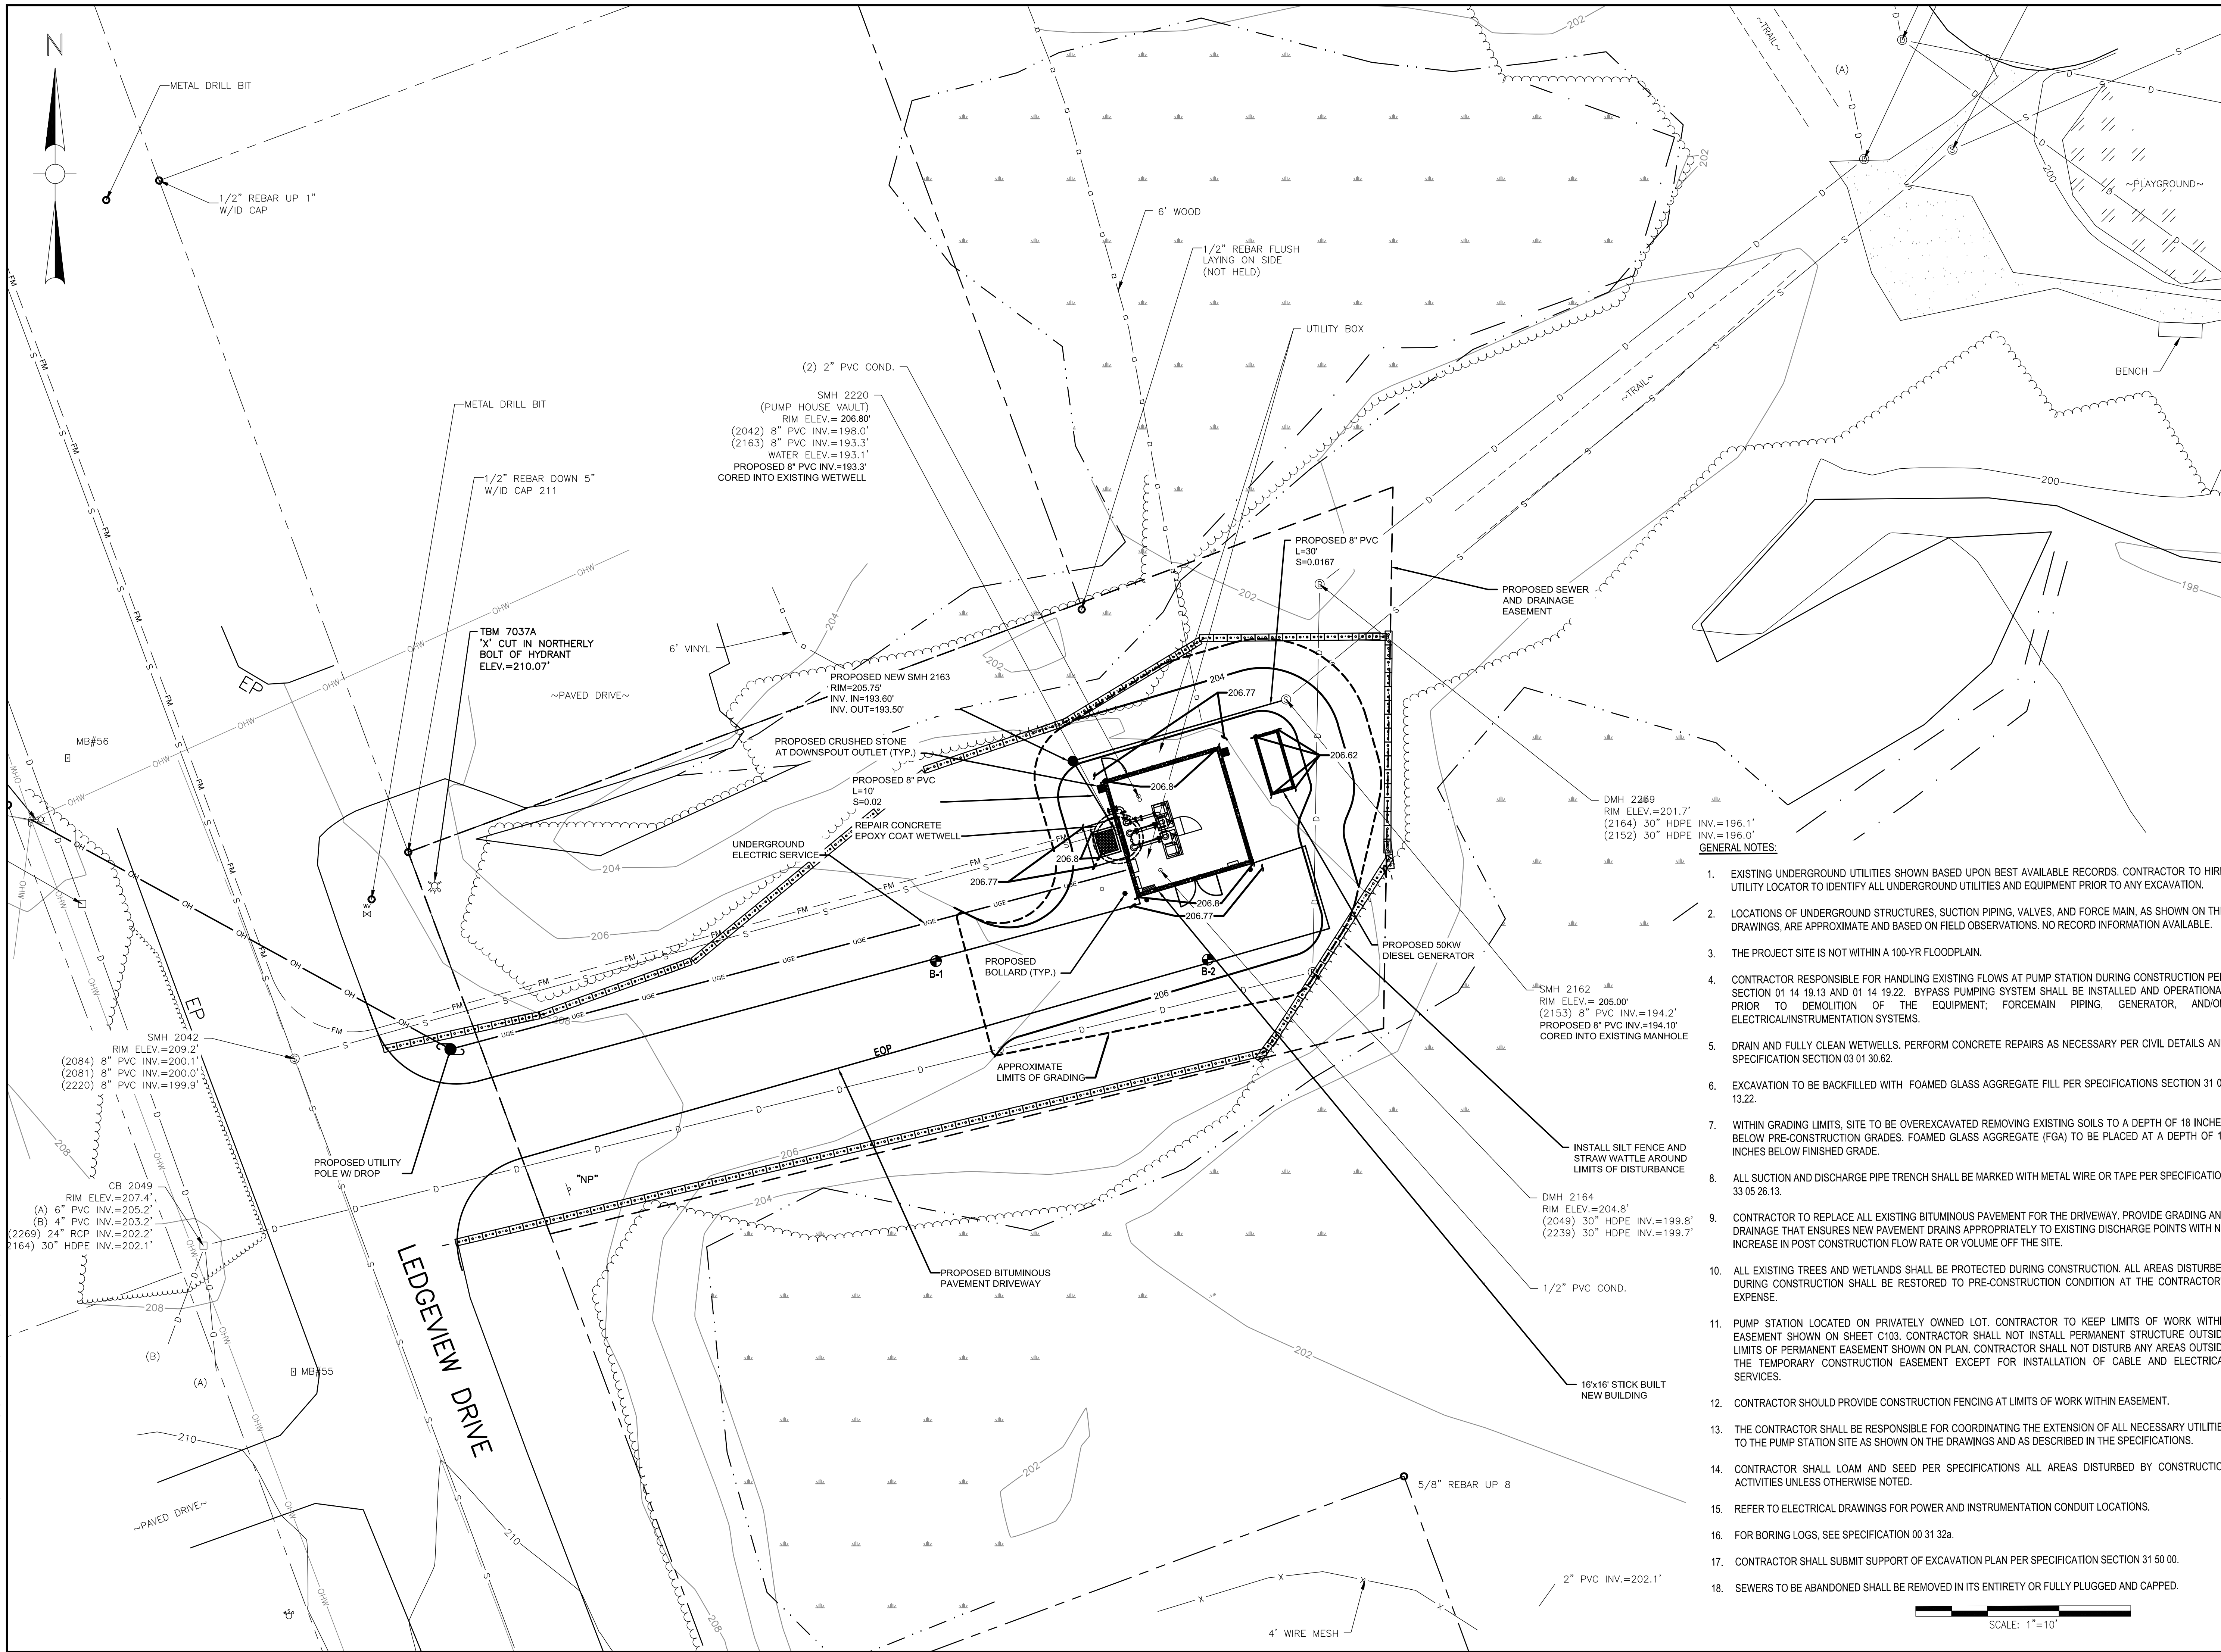
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Drawing Title:

**ABBREVIATIONS,
NOTES, AND LEGEND**

Sheet Number:

G001




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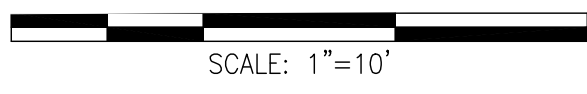
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 W&S File No.:


Drawing Title:
PROPOSED SITE PLAN

Sheet Number:
C102

- GENERAL NOTES:**
- EXISTING UNDERGROUND UTILITIES SHOWN BASED UPON BEST AVAILABLE RECORDS. CONTRACTOR TO HIRE UTILITY LOCATOR TO IDENTIFY ALL UNDERGROUND UTILITIES AND EQUIPMENT PRIOR TO ANY EXCAVATION.
 - LOCATIONS OF UNDERGROUND STRUCTURES, SUCTION PIPING, VALVES, AND FORCE MAIN, AS SHOWN ON THE DRAWINGS, ARE APPROXIMATE AND BASED ON FIELD OBSERVATIONS. NO RECORD INFORMATION AVAILABLE.
 - THE PROJECT SITE IS NOT WITHIN A 100-YR FLOODPLAIN.
 - CONTRACTOR RESPONSIBLE FOR HANDLING EXISTING FLOWS AT PUMP STATION DURING CONSTRUCTION PER SECTION 01 14 19.13 AND 01 14 19.22. BYPASS PUMPING SYSTEM SHALL BE INSTALLED AND OPERATIONAL PRIOR TO DEMOLITION OF THE EQUIPMENT; FORCEMAIN PIPING, GENERATOR, AND/OR ELECTRICAL/INSTRUMENTATION SYSTEMS.
 - DRAIN AND FULLY CLEAN WETWELLS. PERFORM CONCRETE REPAIRS AS NECESSARY PER CIVIL DETAILS AND SPECIFICATION SECTION 03 01 30.62.
 - EXCAVATION TO BE BACKFILLED WITH FOAMED GLASS AGGREGATE FILL PER SPECIFICATIONS SECTION 31 05 13.22.
 - WITHIN GRADING LIMITS, SITE TO BE OVEREXCAVATED REMOVING EXISTING SOILS TO A DEPTH OF 18 INCHES BELOW PRE-CONSTRUCTION GRADES. FOAMED GLASS AGGREGATE (FGA) TO BE PLACED AT A DEPTH OF 12 INCHES BELOW FINISHED GRADE.
 - ALL SUCTION AND DISCHARGE PIPE TRENCH SHALL BE MARKED WITH METAL WIRE OR TAPE PER SPECIFICATION 33 05 28.13.
 - CONTRACTOR TO REPLACE ALL EXISTING BITUMINOUS PAVEMENT FOR THE DRIVEWAY. PROVIDE GRADING AND DRAINAGE THAT ENSURES NEW PAVEMENT DRAINS APPROPRIATELY TO EXISTING DISCHARGE POINTS WITH NO INCREASE IN POST CONSTRUCTION FLOW RATE OR VOLUME OFF THE SITE.
 - ALL EXISTING TREES AND WETLANDS SHALL BE PROTECTED DURING CONSTRUCTION. ALL AREAS DISTURBED DURING CONSTRUCTION SHALL BE RESTORED TO PRE-CONSTRUCTION CONDITION AT THE CONTRACTOR'S EXPENSE.
 - PUMP STATION LOCATED ON PRIVATELY OWNED LOT. CONTRACTOR TO KEEP LIMITS OF WORK WITHIN EASEMENT SHOWN ON SHEET C103. CONTRACTOR SHALL NOT INSTALL PERMANENT STRUCTURE OUTSIDE LIMITS OF PERMANENT EASEMENT SHOWN ON PLAN. CONTRACTOR SHALL NOT DISTURB ANY AREAS OUTSIDE THE TEMPORARY CONSTRUCTION EASEMENT EXCEPT FOR INSTALLATION OF CABLE AND ELECTRICAL SERVICES.
 - CONTRACTOR SHOULD PROVIDE CONSTRUCTION FENCING AT LIMITS OF WORK WITHIN EASEMENT.
 - THE CONTRACTOR SHALL BE RESPONSIBLE FOR COORDINATING THE EXTENSION OF ALL NECESSARY UTILITIES TO THE PUMP STATION SITE AS SHOWN ON THE DRAWINGS AND AS DESCRIBED IN THE SPECIFICATIONS.
 - CONTRACTOR SHALL LOAM AND SEED PER SPECIFICATIONS ALL AREAS DISTURBED BY CONSTRUCTION ACTIVITIES UNLESS OTHERWISE NOTED.
 - REFER TO ELECTRICAL DRAWINGS FOR POWER AND INSTRUMENTATION CONDUIT LOCATIONS.
 - FOR BORING LOGS, SEE SPECIFICATION 00 31 32a.
 - CONTRACTOR SHALL SUBMIT SUPPORT OF EXCAVATION PLAN PER SPECIFICATION SECTION 31 50 00.
 - SEWERS TO BE ABANDONED SHALL BE REMOVED IN ITS ENTIRETY OR FULLY PLUGGED AND CAPPED.

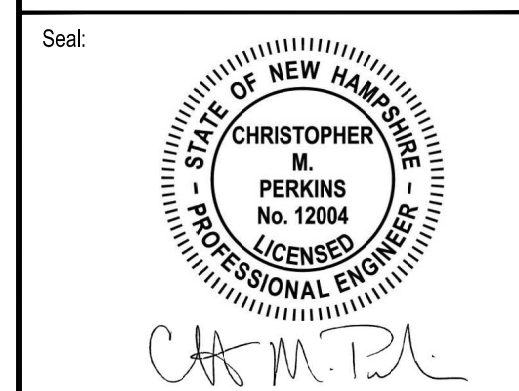

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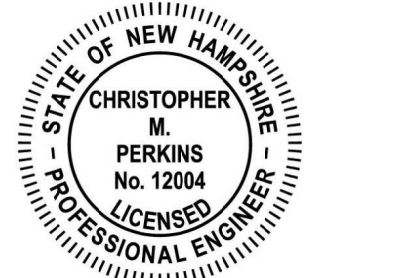
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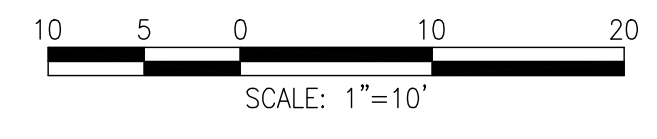
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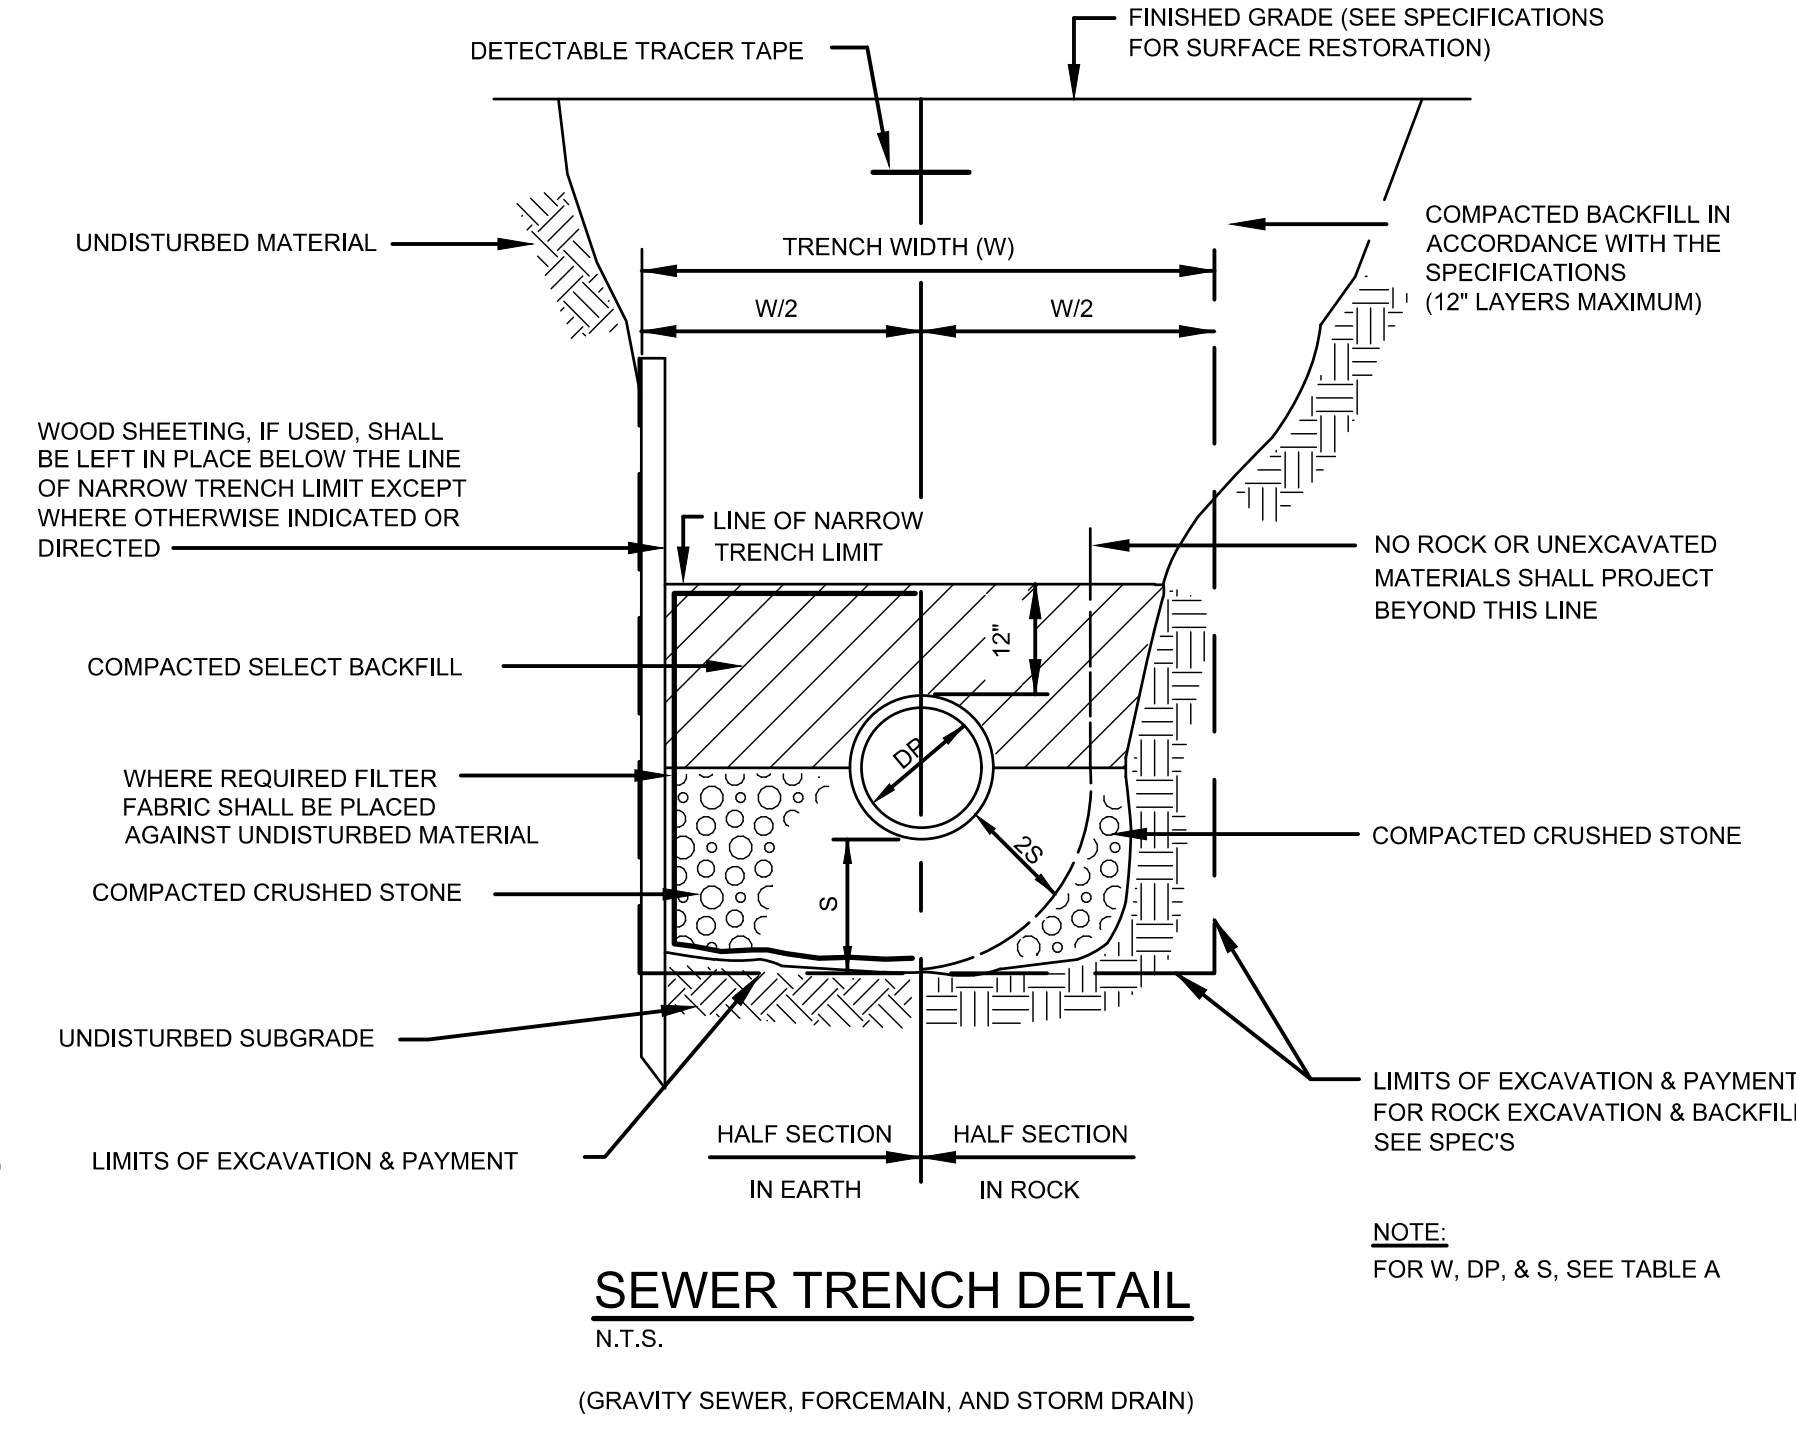
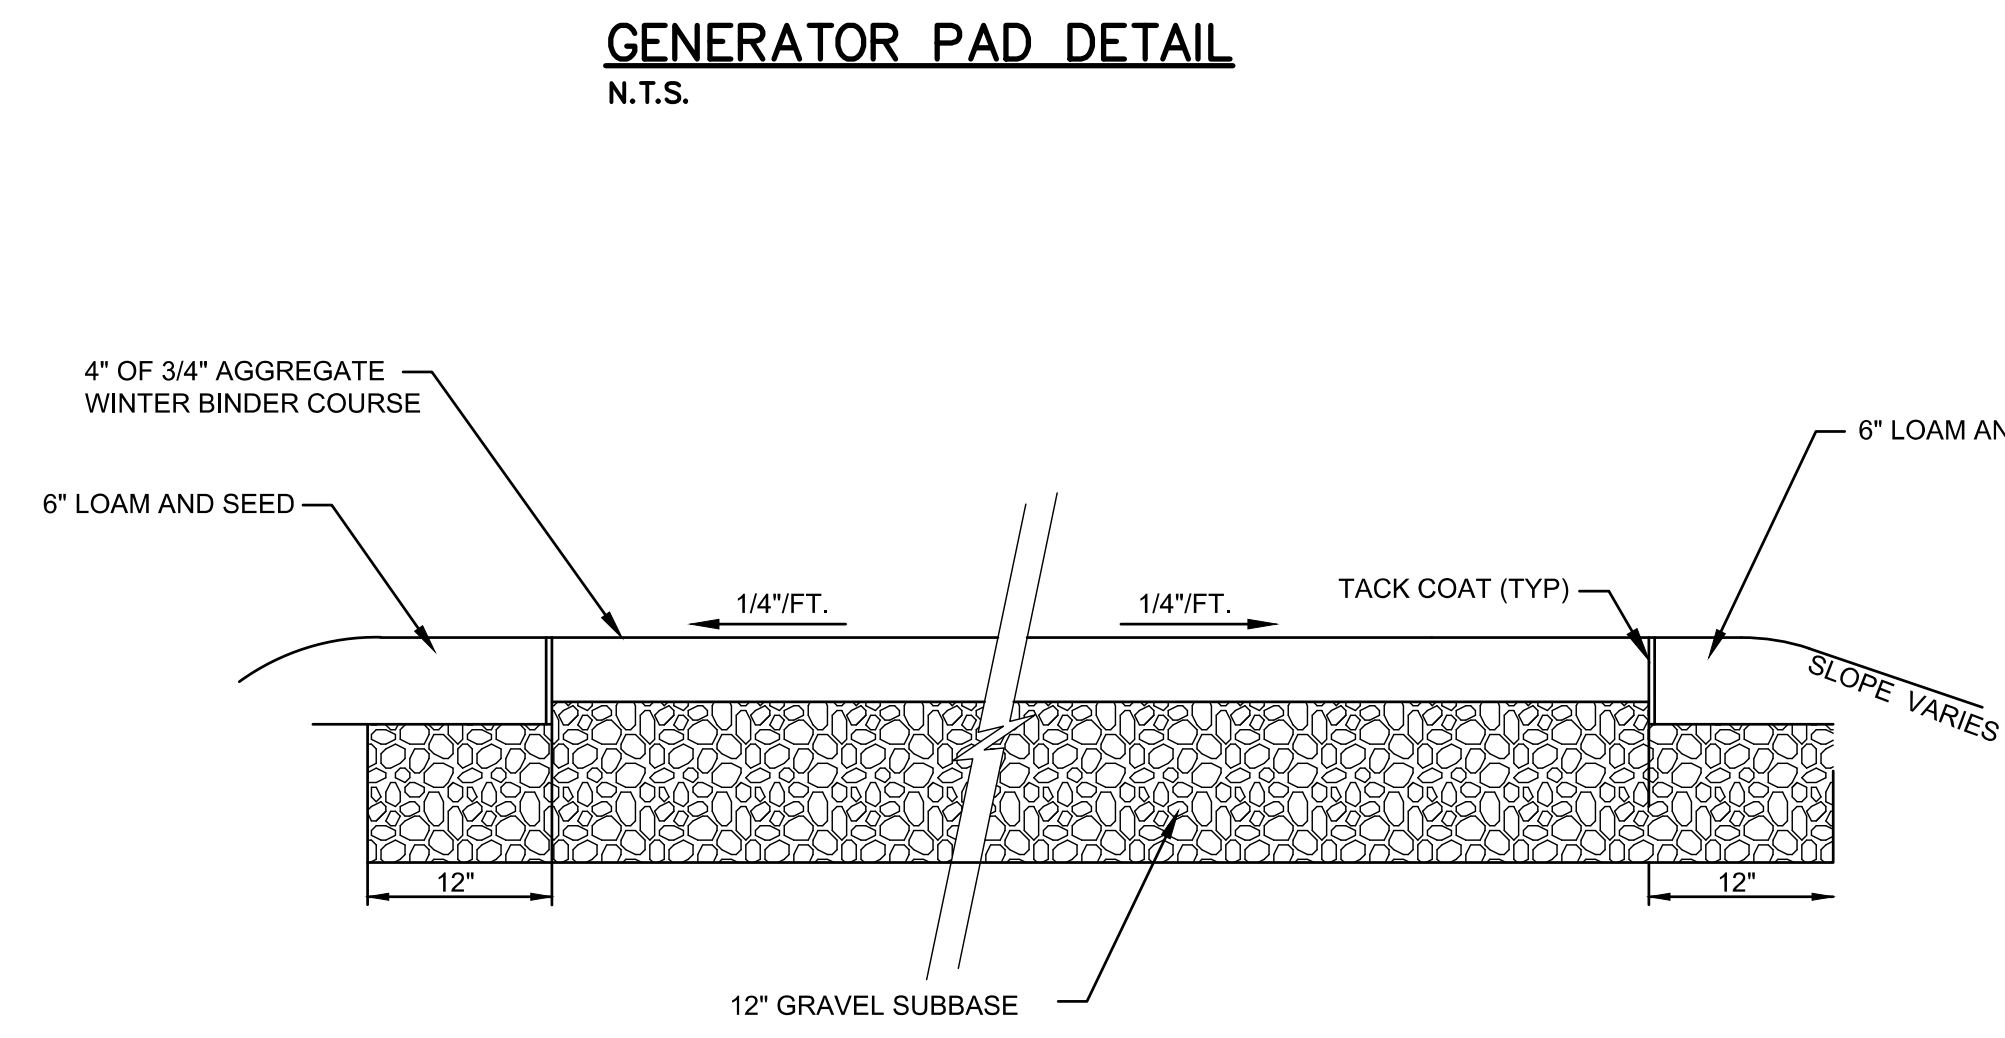
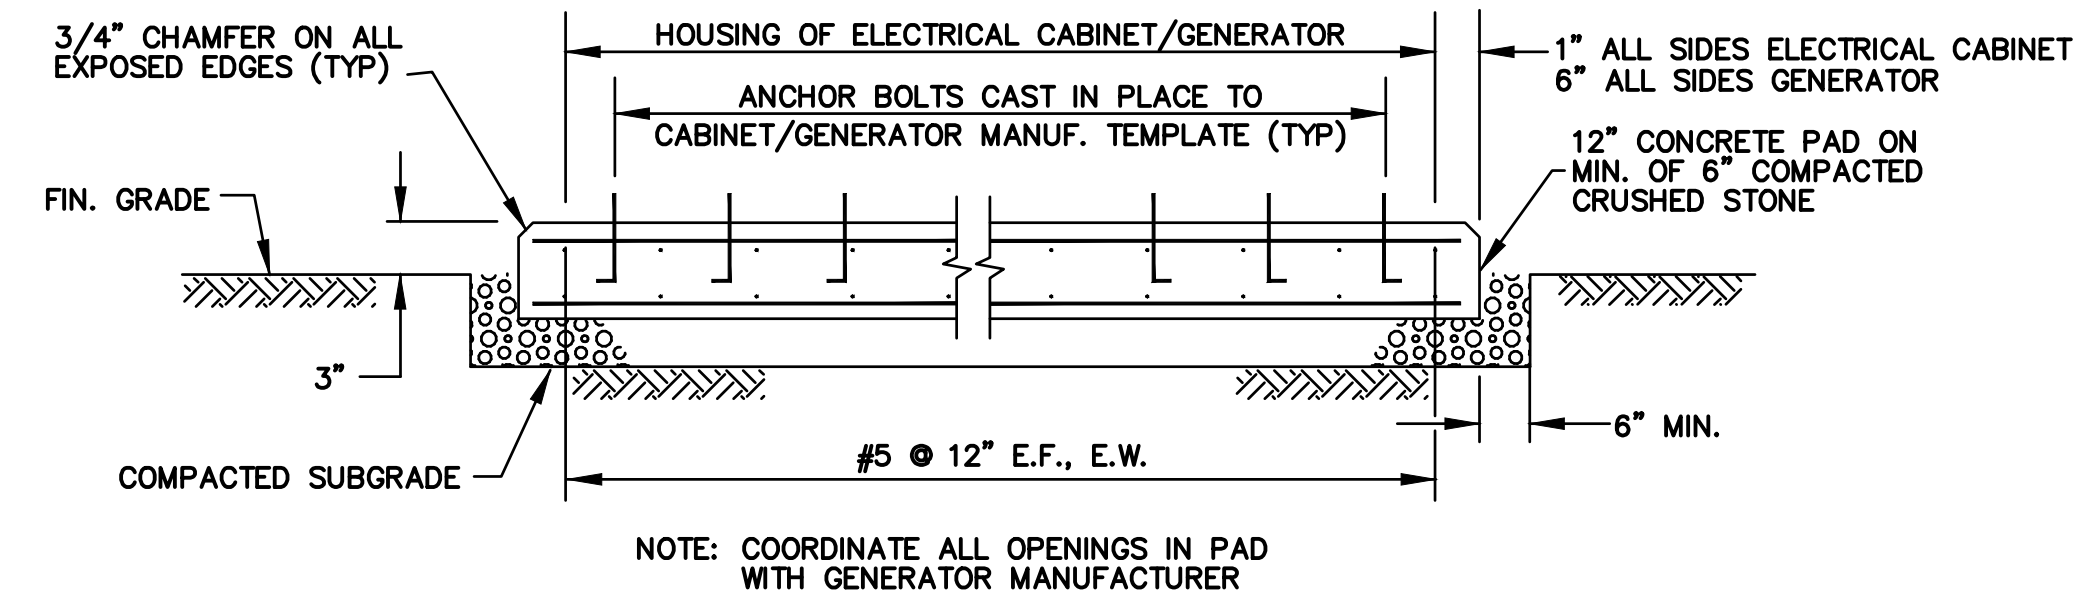
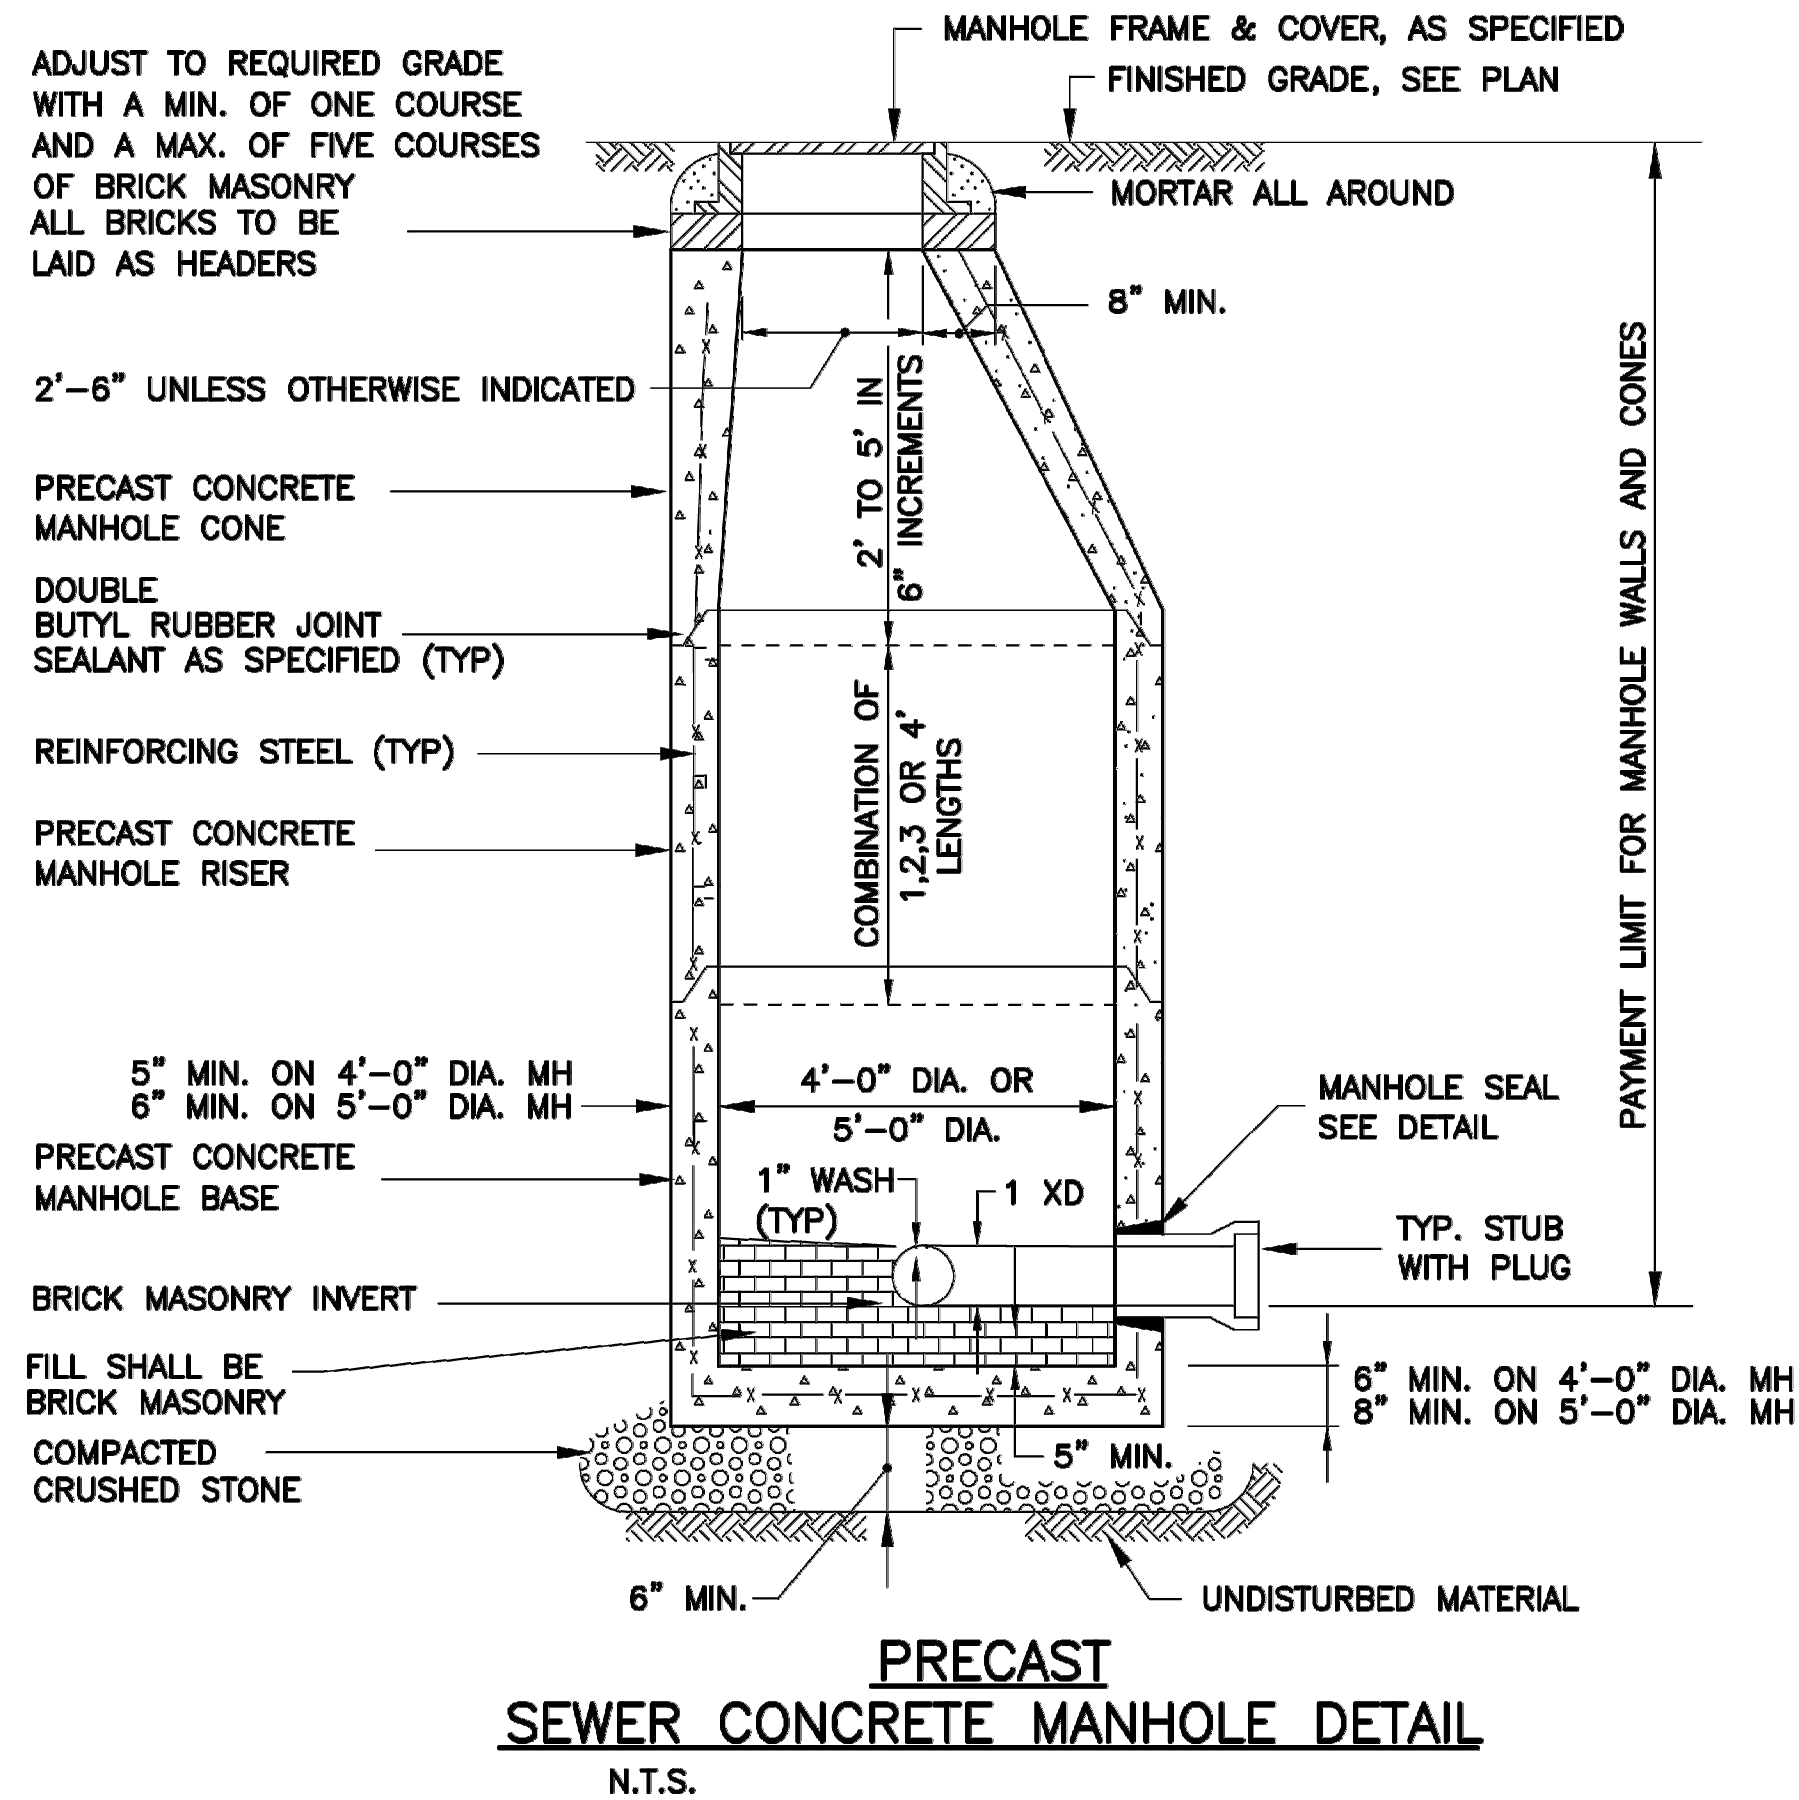
EASEMENT PLAN

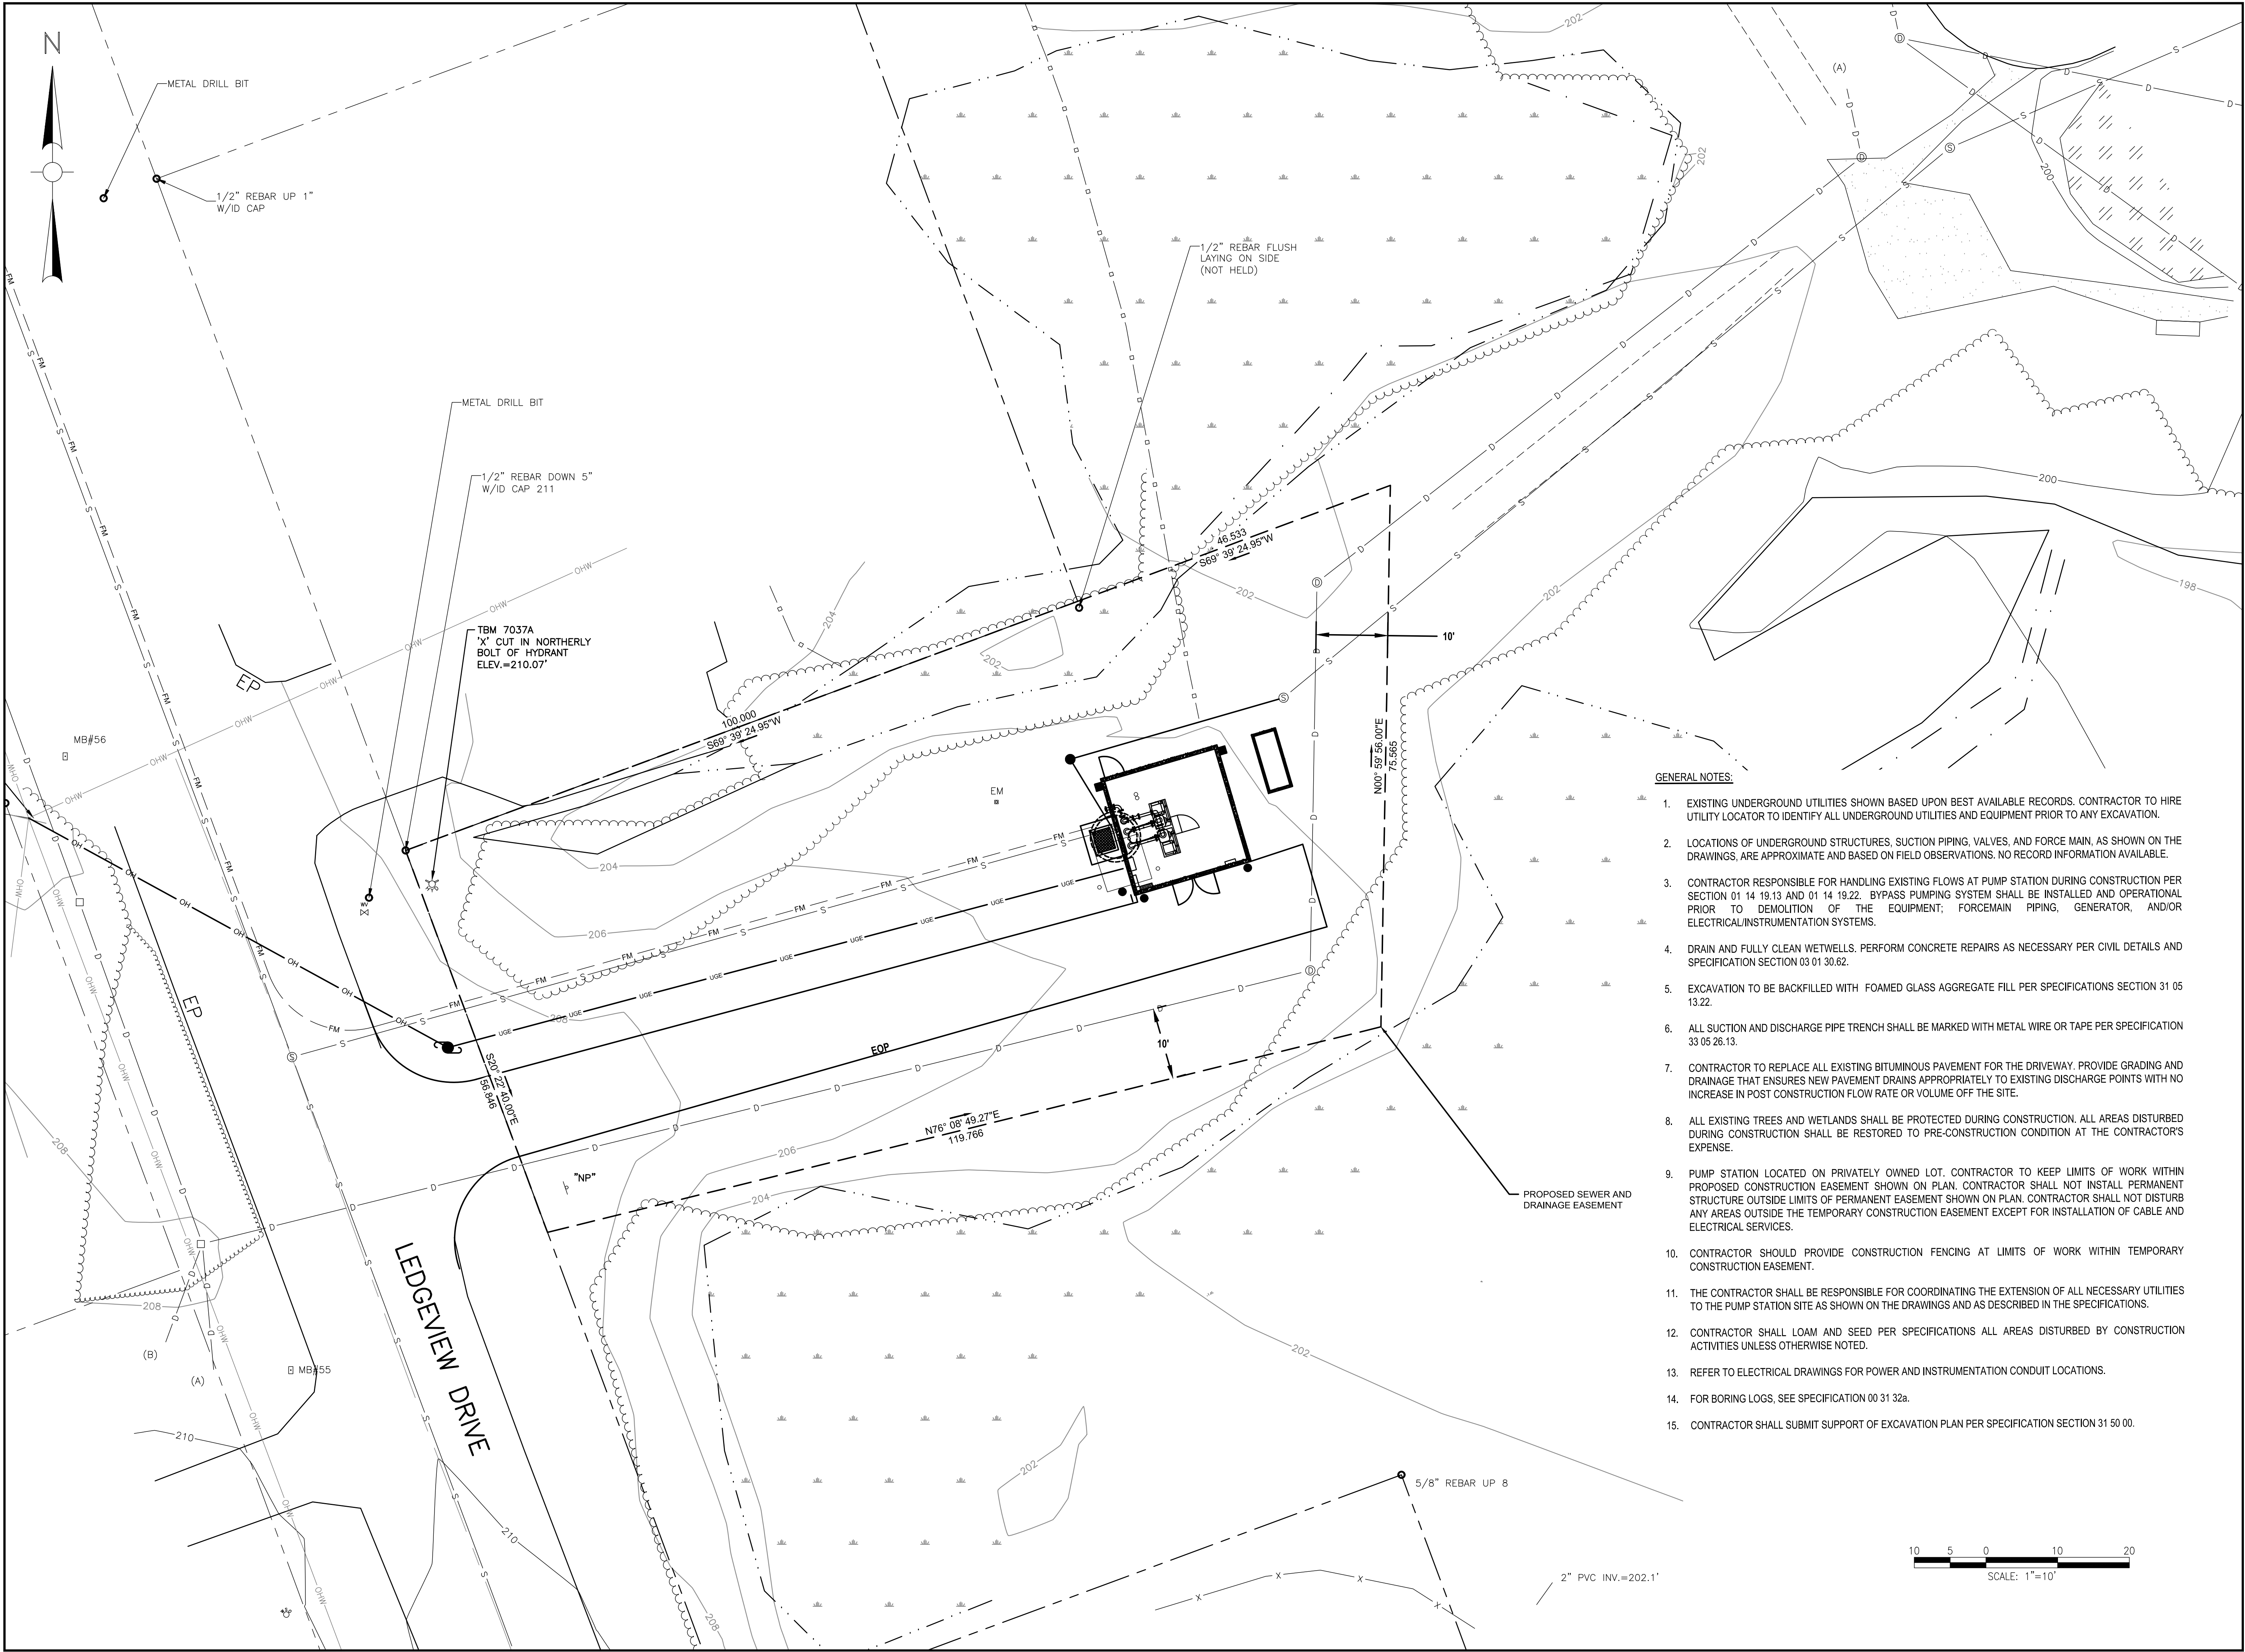Sheet Number:
C103

- GENERAL NOTES:**
- EXISTING UNDERGROUND UTILITIES SHOWN BASED UPON BEST AVAILABLE RECORDS. CONTRACTOR TO HIRE UTILITY LOCATOR TO IDENTIFY ALL UNDERGROUND UTILITIES AND EQUIPMENT PRIOR TO ANY EXCAVATION.
 - LOCATIONS OF UNDERGROUND STRUCTURES, SUCTION PIPING, VALVES, AND FORCE MAIN, AS SHOWN ON THE DRAWINGS, ARE APPROXIMATE AND BASED ON FIELD OBSERVATIONS. NO RECORD INFORMATION AVAILABLE.
 - CONTRACTOR RESPONSIBLE FOR HANDLING EXISTING FLOWS AT PUMP STATION DURING CONSTRUCTION PER SECTION 01 14 19.13 AND 01 14 19.22. BYPASS PUMPING SYSTEM SHALL BE INSTALLED AND OPERATIONAL PRIOR TO DEMOLITION OF THE EQUIPMENT; FORCEMAIN PIPING, GENERATOR, AND/OR ELECTRICAL INSTRUMENTATION SYSTEMS.
 - DRAIN AND FULLY CLEAN WETWELLS. PERFORM CONCRETE REPAIRS AS NECESSARY PER CIVIL DETAILS AND SPECIFICATION SECTION 03 01 30.62.
 - EXCAVATION TO BE BACKFILLED WITH FOAMED GLASS AGGREGATE FILL PER SPECIFICATIONS SECTION 31 05 13.22.
 - ALL SUCTION AND DISCHARGE PIPE TRENCH SHALL BE MARKED WITH METAL WIRE OR TAPE PER SPECIFICATION 33 05 26.13.
 - CONTRACTOR TO REPLACE ALL EXISTING BITUMINOUS PAVEMENT FOR THE DRIVEWAY. PROVIDE GRADING AND DRAINAGE THAT ENSURES NEW PAVEMENT DRAINS APPROPRIATELY TO EXISTING DISCHARGE POINTS WITH NO INCREASE IN POST CONSTRUCTION FLOW RATE OR VOLUME OFF THE SITE.
 - ALL EXISTING TREES AND WETLANDS SHALL BE PROTECTED DURING CONSTRUCTION. ALL AREAS DISTURBED DURING CONSTRUCTION SHALL BE RESTORED TO PRE-CONSTRUCTION CONDITION AT THE CONTRACTOR'S EXPENSE.
 - PUMP STATION LOCATED ON PRIVATELY OWNED LOT. CONTRACTOR TO KEEP LIMITS OF WORK WITHIN PROPOSED CONSTRUCTION EASEMENT SHOWN ON PLAN. CONTRACTOR SHALL NOT INSTALL PERMANENT STRUCTURE OUTSIDE LIMITS OF PERMANENT EASEMENT SHOWN ON PLAN. CONTRACTOR SHALL NOT DISTURB ANY AREAS OUTSIDE THE TEMPORARY CONSTRUCTION EASEMENT EXCEPT FOR INSTALLATION OF CABLE AND ELECTRICAL SERVICES.
 - CONTRACTOR SHOULD PROVIDE CONSTRUCTION FENCING AT LIMITS OF WORK WITHIN TEMPORARY CONSTRUCTION EASEMENT.
 - THE CONTRACTOR SHALL BE RESPONSIBLE FOR COORDINATING THE EXTENSION OF ALL NECESSARY UTILITIES TO THE PUMP STATION SITE AS SHOWN ON THE DRAWINGS AND AS DESCRIBED IN THE SPECIFICATIONS.
 - CONTRACTOR SHALL LOAM AND SEED PER SPECIFICATIONS ALL AREAS DISTURBED BY CONSTRUCTION ACTIVITIES UNLESS OTHERWISE NOTED.
 - REFER TO ELECTRICAL DRAWINGS FOR POWER AND INSTRUMENTATION CONDUIT LOCATIONS.
 - FOR BORING LOGS, SEE SPECIFICATION 00 31 32a.
 - CONTRACTOR SHALL SUBMIT SUPPORT OF EXCAVATION PLAN PER SPECIFICATION SECTION 31 50 00.



WESTON & SAMPSON ENGINEERS, INC. 100 INTERNATIONAL DRIVE, SUITE 152, PORTSMOUTH, NH 03801
 DATE PLOTTED: 04/24/2024 10:58 AM
 PROJECT: LEDGEVIEW SEWER PUMP STATION UPGRADE
 SHEET: C103



DIAMETER OF PIPE (DP)	MAXIMUM TRENCH WIDTH BELOW LINE OF NARROW TRENCH LIMIT (SHEETED OR UNSHEETED) (W)	MINIMUM CLEARANCE (S)
<15"	36"	6"

TABLE A

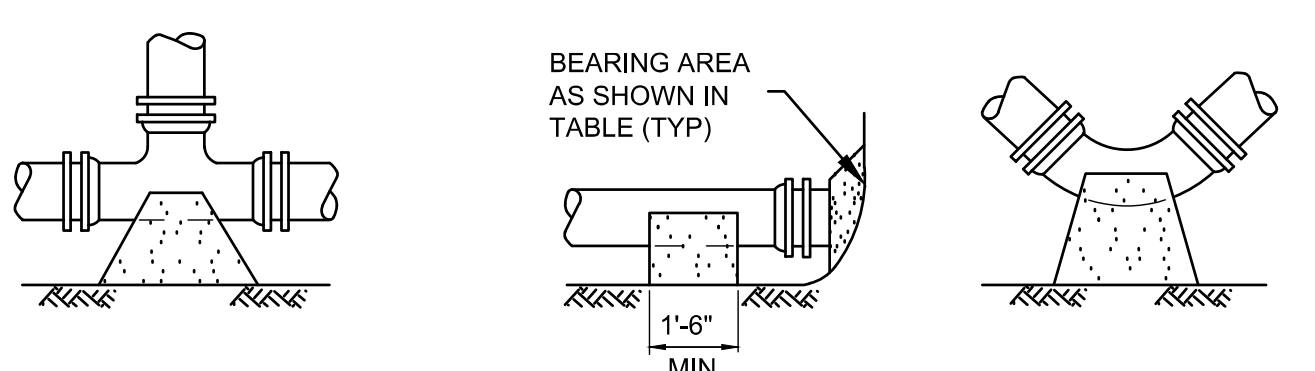
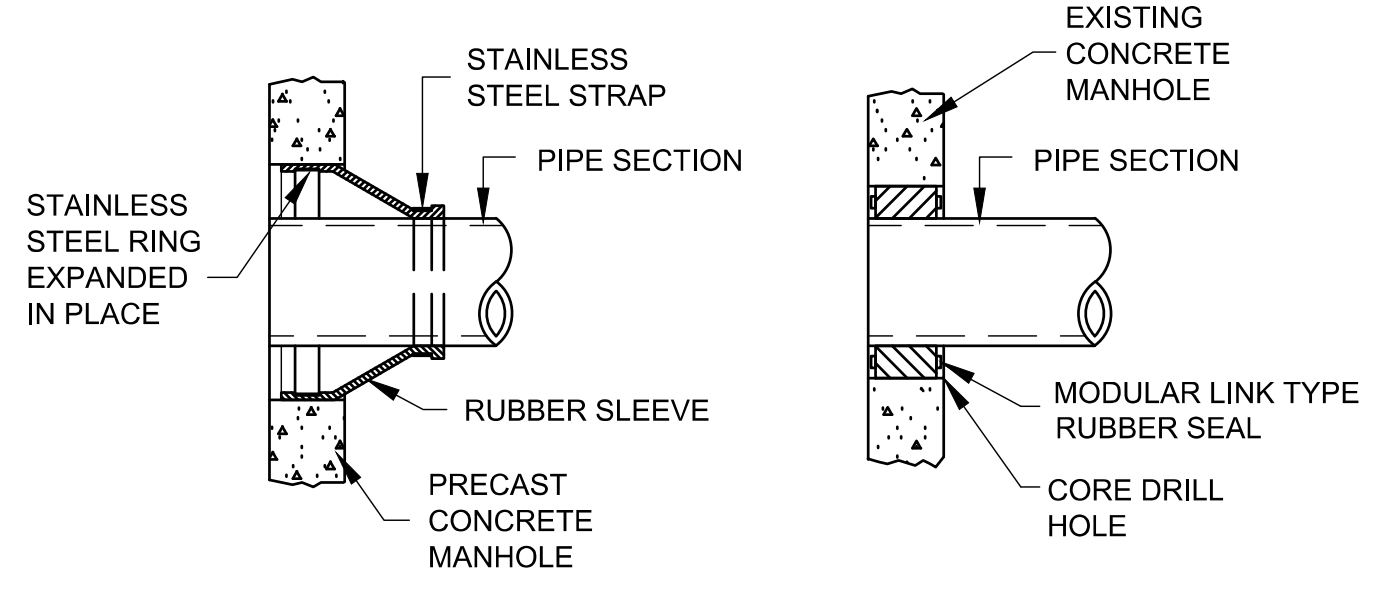
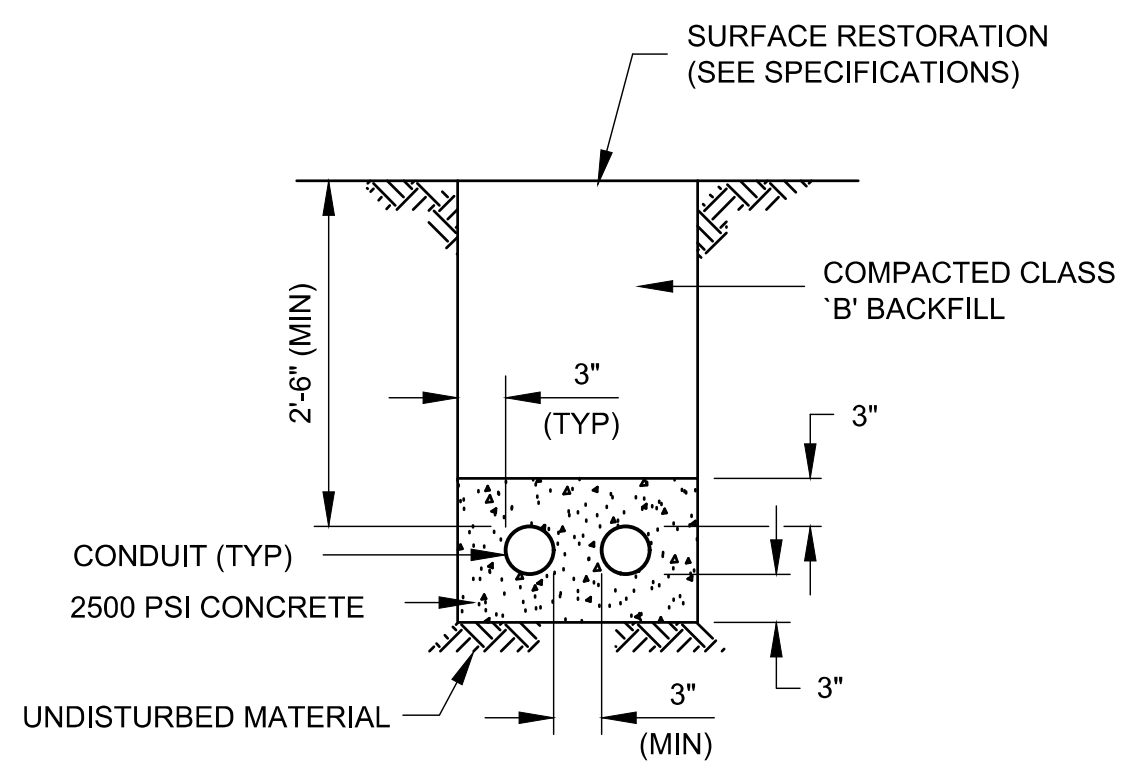
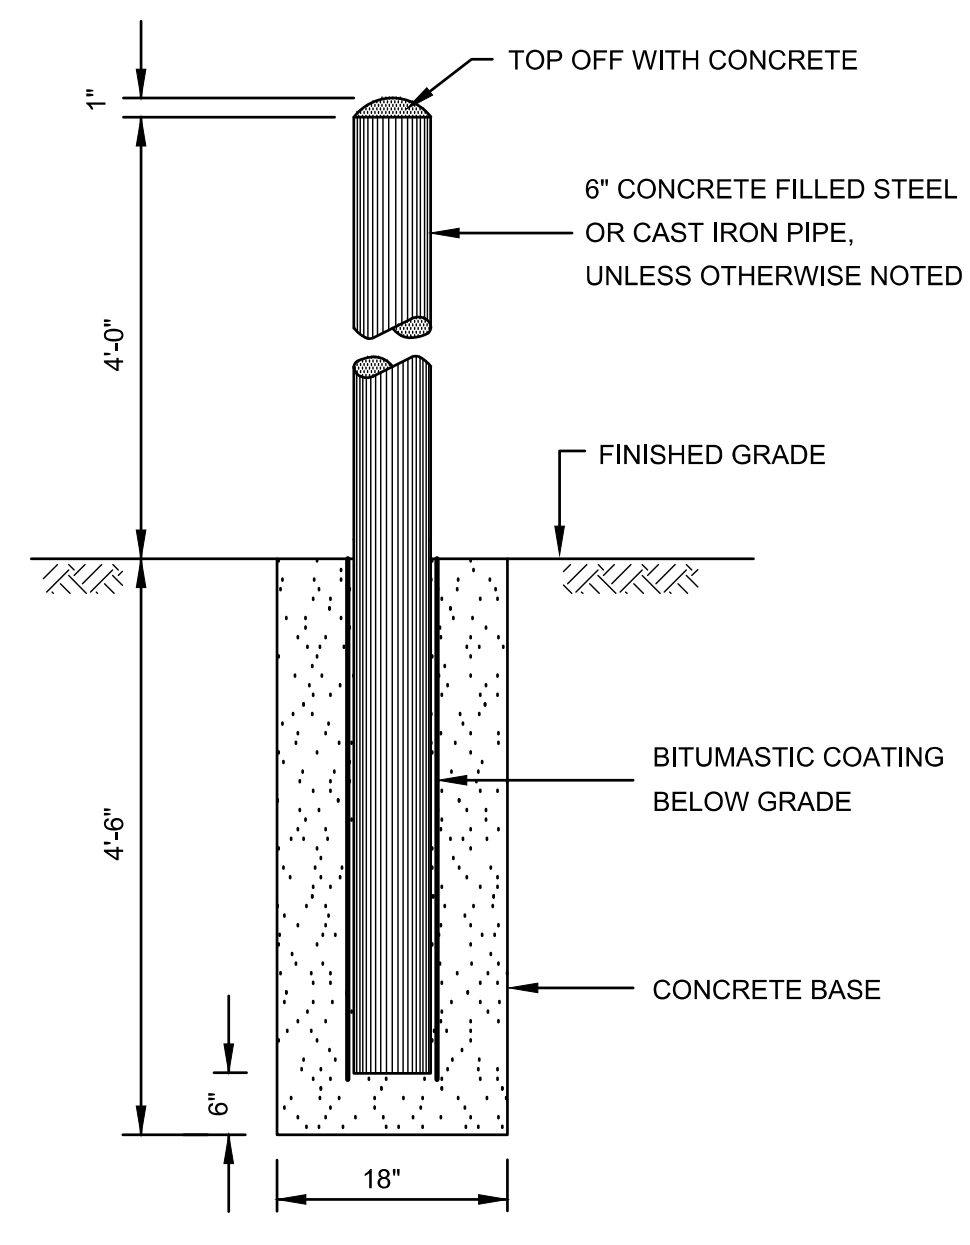



TABLE OF CONCRETE THRUST RESTRAINT MINIMUM BEARING AREAS IN SQUARE FEET AGAINST UNDISTURBED MATERIAL FOR ALL PRESSURE PIPE FITTINGS

SIZE OF MAIN	90° BENDS, TEES, CAPS AND PLUGS	45° BENDS AND WYES	22-12" BENDS	11-14" BENDS
6", 8"	5	4	2	2
10", 12"	12	9	5	2

CONCRETE THRUST RESTRAINT FOR FITTINGS
N.T.S.


NOTES:

- CONCRETE THRUST RESTRAINT SHALL ONLY BE USED WHERE OTHER MEANS OF RESTRAINT ARE NOT FEASIBLE.
- CONTRACTOR SHALL USE CARE TO AVOID PLACEMENT OF CONCRETE ON THE FITTING JOINTS.

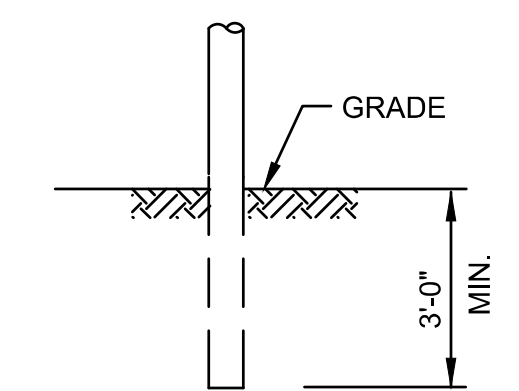

NOTES:

- SEE SPECIFICATION SECTION 01 56 26-TEMPORARY CHAIN LINK FENCE
- PORTABLE/TEMPORARY CHAIN LINK FENCE IS ALLOWABLE.

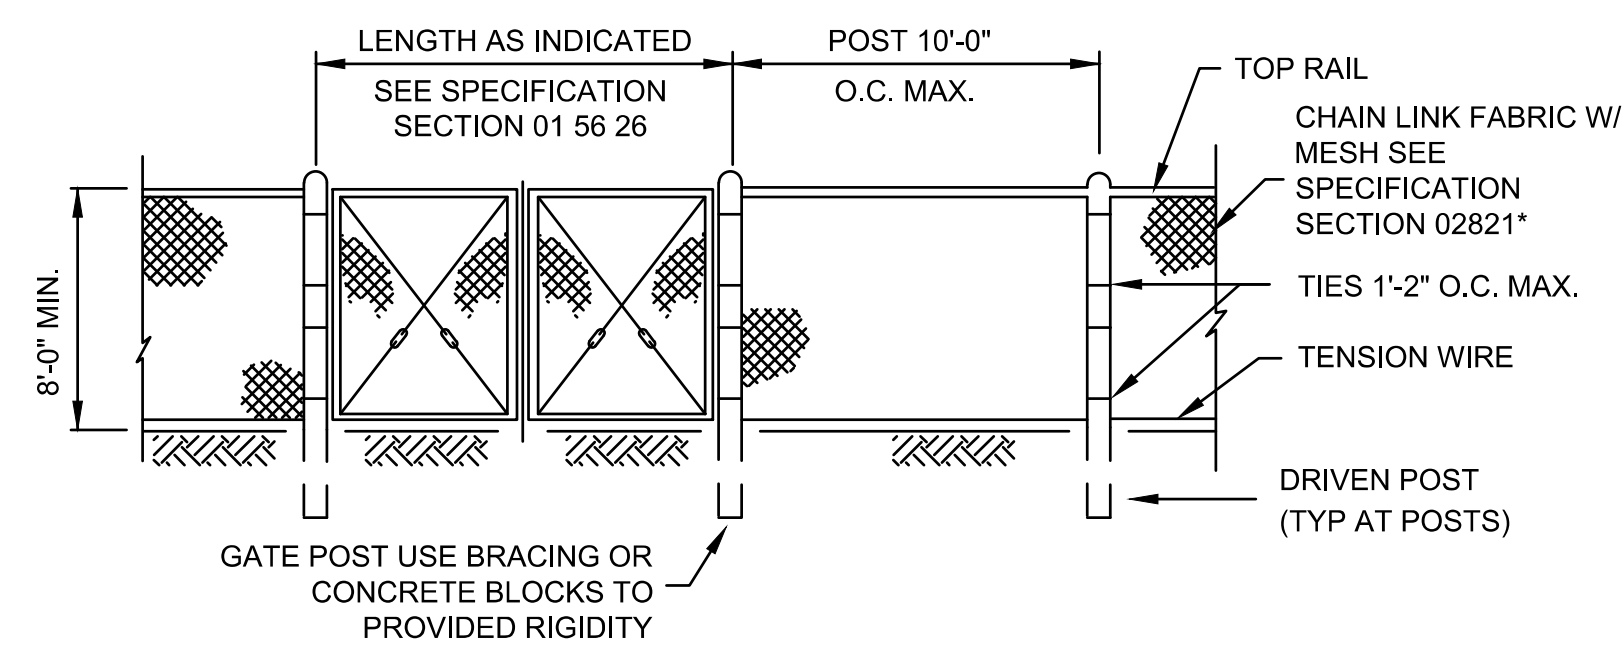

TEMPORARY CHAIN LINK FENCE AND GATE DETAIL
N.T.S.

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Seal:

CHRISTOPHER M. PERKINS
No. 12904
PROFESSIONAL ENGINEER

Issued For:

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Scale: NO SCALE

Date: 4 / 24 / 2024

Drawn By: AJB

Reviewed By: JMS

Approved By: CMP

W&S Project No.: ENG23-0367

W&S File No.:

Drawing Title:

CIVIL DETAILS

Sheet Number:

C501

STRUCTURAL REPAIR NOTES:

GENERAL REPAIR NOTES:

1. WETWELL SHOULD BE THOROUGHLY CLEANED AND POWER WASHED CAREFULLY PRIOR TO ANY OF THE CONCRETE REPAIR PROCEDURES LISTED BELOW.
2. CONTRACTOR TO ASSUME PARTIAL DEPTH CONCRETE REPAIR IS NOT NECESSARY. LIMITS TO BE DETERMINED DURING FIELD SURVEY.
3. COATINGS SHALL BE APPLIED AFTER COMPLETION OF CRACK REPAIRS, FLOOR SLOPE MODIFICATIONS, AND INSTALLATION OF TOP SLAB/CURB.

EPOXY INJECTION CRACK REPAIR:

4. CONTRACTOR TO PERFORM FIELD SURVEY TO DETERMINE LIMITS OF CRACKS AND REQUIRED REPAIRS.
5. AFTER APPROVAL OF LIMITS IS RECEIVED FROM ENGINEER, CONCRETE CRACKS SHALL BE REPAIRED BY EPOXY INJECTION.
6. CRACKS SHALL BE CLEANED IN ACCORDANCE WITH THE PROJECT SPECIFICATIONS PRIOR TO INSTALLATION OF INJECTION PORTS.
7. CLEAN AREAS TO RECEIVE CAPPING ADHESIVE OF OIL, DIRT, AND OTHER SUBSTANCES THAT WOULD INTERFERE WITH BOND, AND CLEAN CRACKS WITH OIL-FREE COMPRESSED AIR OR LOW-PRESSURE WATER TO REMOVE LOOSE PARTICLES.
8. PLACE INJECTION PORTS AS RECOMMENDED BY EPOXY MANUFACTURER, SPACING NO FARTHER APART THAN THICKNESS OF MEMBER BEING INJECTED. SEAL INJECTION PORTS IN PLACE WITH CAPPING ADHESIVE.
9. SEAL CRACKS AT EXPOSED SURFACES WITH A RIBBON OF CAPPING ADHESIVE AT LEAST ¼ INCH THICK BY 1 INCH WIDER THAN CRACK.
10. INJECT CRACKS WITH A WIDTH OF 0.005 INCH TO 0.25 INCH.
11. INJECT EPOXY ADHESIVE, BEGINNING AT WIDEST PART OF CRACK AND WORKING TOWARD NARROWER PARTS, INJECT ADHESIVE INTO PORTS TO REFUSAL, CAPPING ADJACENT PORTS WHEN THEY EXTRUDE EPOXY. CAP INJECTED PORTS AND INJECT THROUGH ADJACENT PORTS UNTIL CRACK IS FILLED.
12. AFTER EPOXY ADHESIVE HAS SET, REMOVE INJECTION PORTS, AND GRIND SURFACES SMOOTH.

PARTIAL DEPTH REPAIR NOTES:


13. CONTRACTOR TO PERFORM FIELD SURVEY TO DETERMINE LIMITS OF DETERIORATION AND REQUIRED REPAIRS. THIS SURVEY SHALL INCLUDE THE WETWELL FLOOR AND SIDEWALLS.
14. AFTER APPROVAL OF LIMITS RECEIVED FROM ENGINEER, CONTRACTOR TO REMOVE DETERIORATED CONCRETE TO SOUND CONCRETE AT REPAIR LOCATIONS.
15. IF MORE THAN 50% OF A PIECE OF REINFORCING STEEL IS EXPOSED, THE CONCRETE SHALL BE REMOVED TO A MINIMUM OF 1" AROUND THE REINFORCING STEEL AS SHOWN ABOVE.
16. IF REINFORCING STEEL IS FOUND TO BE DETERIORATED, SUPPLEMENTARY REINFORCING STEEL IS TO BE PROVIDED.
 - 16.1. PROVIDE 2 - #5 BARS TO SUPPLEMENT A DETERIORATED ¾" SQUARE BAR.
 - 16.2. PROVIDE 1 - #4 BAR TO SUPPLEMENT A DETERIORATED WIRE TIE.
17. SUPPLEMENTARY REINFORCEMENT TO BE LAPPED WITH EXISTING REINFORCEMENT.
18. CONCRETE SURFACE SHALL BE DAMPENED PRIOR TO PATCHING IN ACCORDANCE WITH SPECIAL PROVISIONS.
19. IF LIMITS OF REPAIR ARE LESS THAN 2" DEEP, TYPE A REPAIR IS TO BE PERFORMED AS SHOWN BELOW.
 - 19.1. TYPE A REPAIRS TO BE PATCHED WITH MATERIAL AS SPECIFIED IN SPECIAL PROVISIONS FOR CEMENTITIOUS MORTAR FOR PATCHING.
20. IF LIMITS OF REPAIR ARE MORE THAN 2" DEEP, TYPE B REPAIR IS TO BE PERFORMED AS SHOWN BELOW.
 - 20.1. TYPE B REPAIRS TO BE PATCHED WITH 5000 PSI - 3/8" CEMENT CONCRETE.
21. ALL PATCHES TO BE FINISHED FLUSH WITH SURROUNDING CONCRETE SURFACE.

SKIM COAT:

22. ALL LOOSE OR FLAKING MATERIAL TO BE REMOVED FROM EXISTING FACE OF CONCRETE SURFACE.
23. SKIM COAT TO BE APPLIED PER THE MANUFACTURER'S SPECIFICATIONS AND MUST MATCH EXISTING THICKNESS ON FACE OF CONCRETE SURFACE.
24. SKIM COAT SHOULD BE ONE OF THE FOLLOWING OR EQUAL:
 - 24.1. TNEMEC SERIES 218/219 MORTAR CLAD OR APPROVED EQUAL.

PROTECTIVE COATING ON WETWELL INTERIOR WALLS:

25. PROTECTIVE COATING TO BE APPLIED PER THE MANUFACTURER'S SPECIFICATIONS.
26. TWO TOP COATS SHALL BE APPLIED WITH TOTAL DRY THICKNESS OF 80 MILS.
27. ENTIRE INTERIOR OF STRUCTURE SHALL BE COATED INCLUDING BOTTOM OF TOP SLAB AND SLOPED FLOORS.
28. PROTECTIVE COATING SHOULD BE ONE OF THE FOLLOWING OR EQUAL:
 - 28.1. TNEMEC SERIES 435 PERMA-GLAZE OR APPROVED EQUAL.

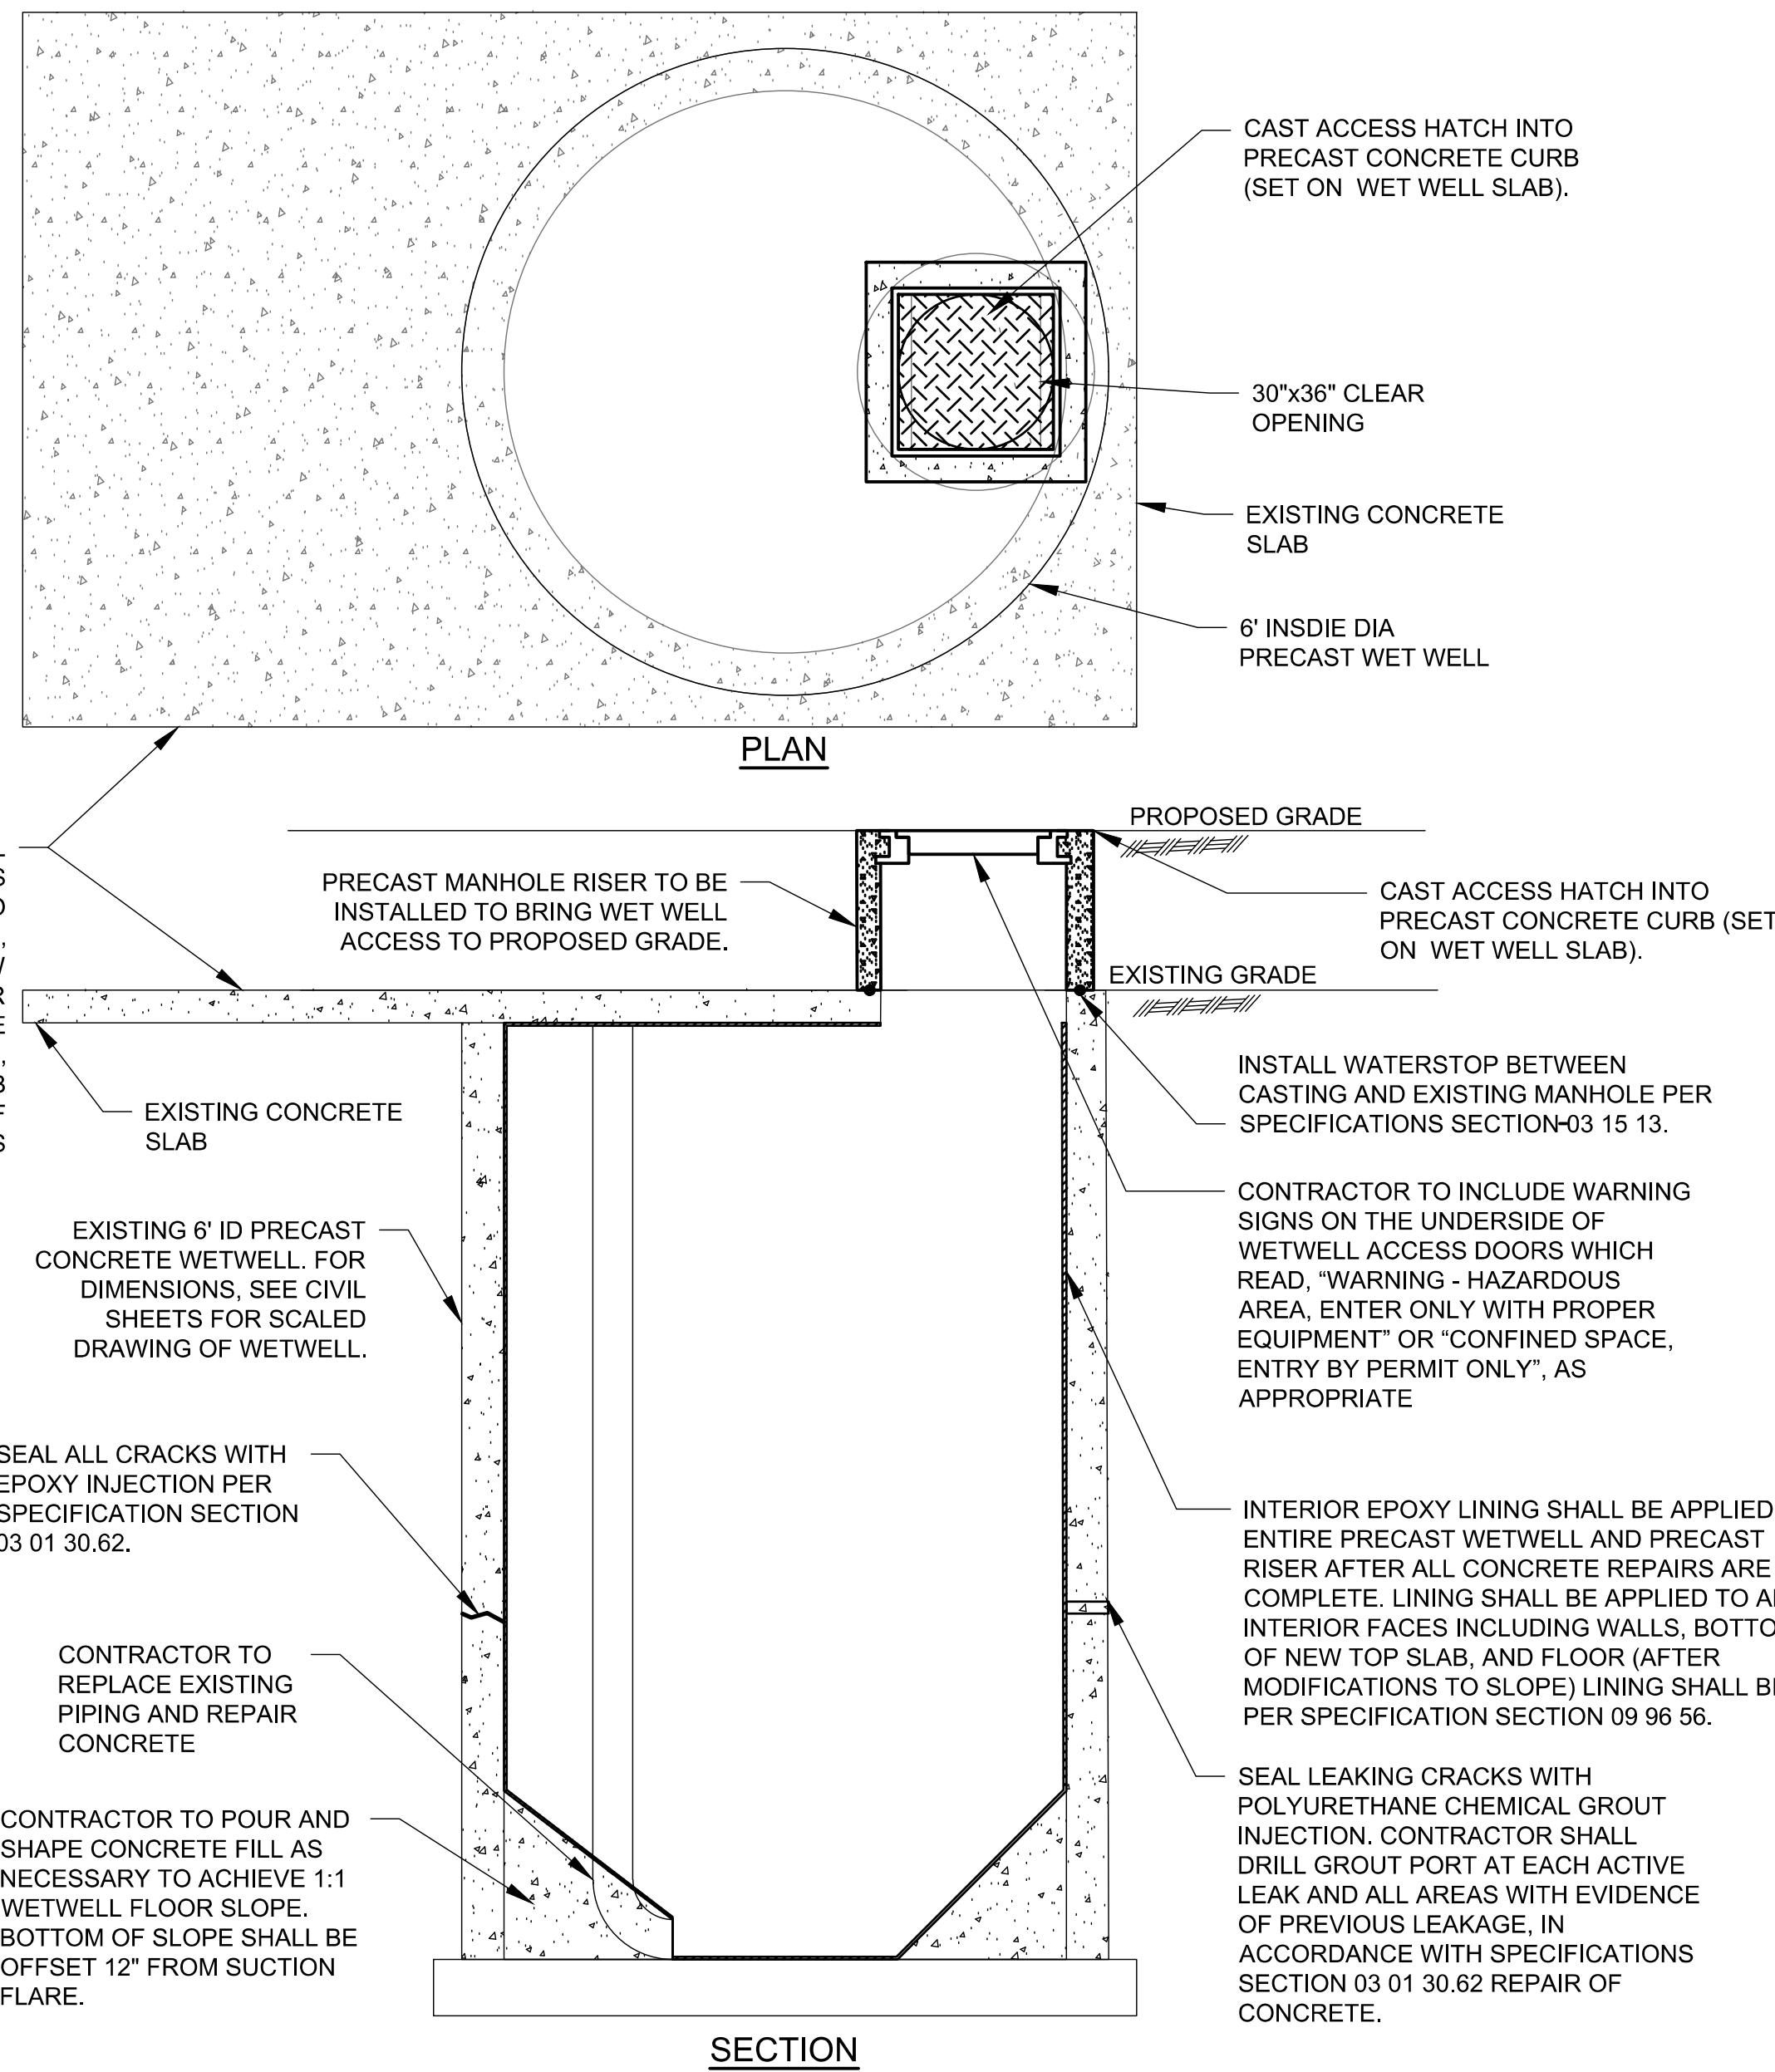


WETWELL REPAIR AND MODIFICATIONS

N.T.S.

NOTES:


1. REMOVE EXISTING MANHOLE FRAMES AND COVERS.
2. INSTALL NEW ALUMINUM FLOOR HATCHES WITH 30"x36" CLEAR OPENING, H20 LOAD RATING, FALL THROUGH PROTECTION, AND LOW PROFILE FRAME (4.5" TALL MAX). SEE SPECIFICATION SECTION 08 34 83 FOR ALL HATCH REQUIREMENTS.
3. WETWELL REPAIRS AND MODIFICATIONS TO BE PERFORMED ON WETWELL.
4. CONTRACTOR TO ASSUME 30 LF OF EPOXY INJECTION REPAIR AND 20 LF OF POLYURETHANE CHEMICAL GROUT REPAIR (TOTAL) FOR COMPARISON OF BIDS.

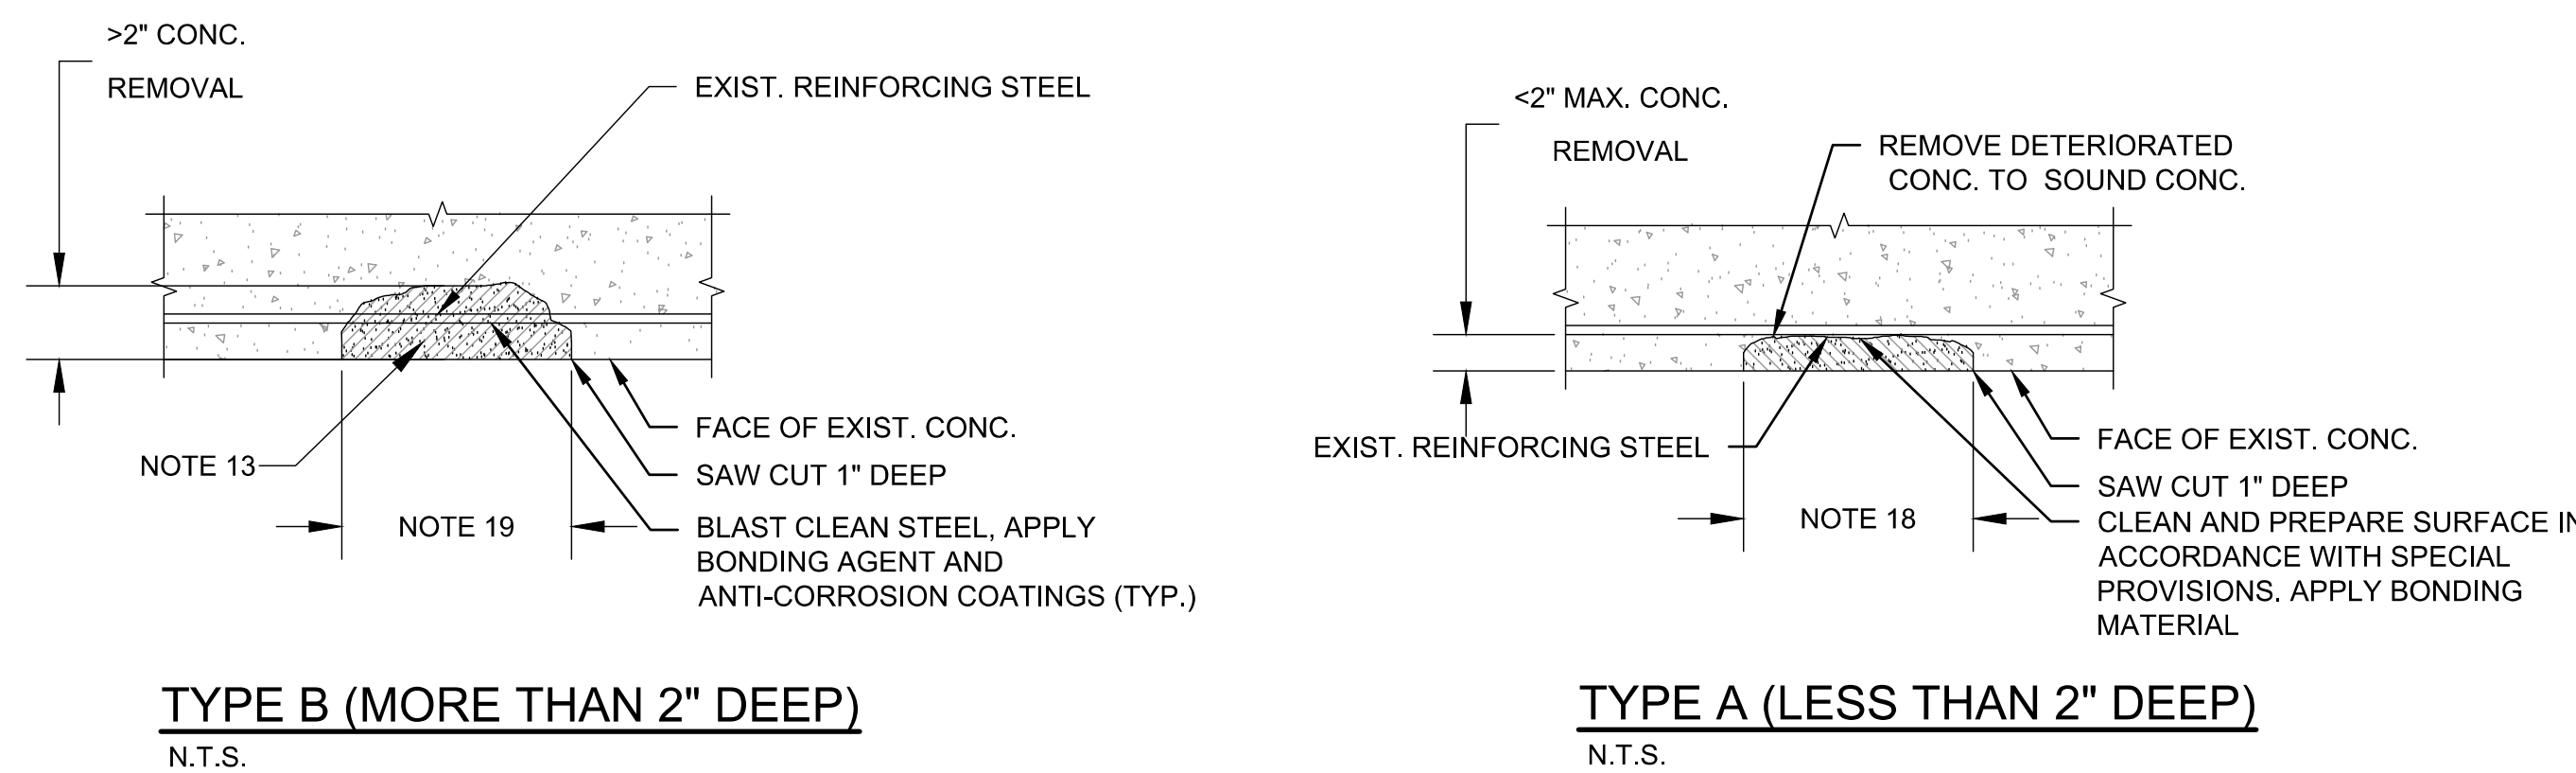

PARTIAL DEPTH CONCRETE REPAIR DETAILS

NOTES:

1. CONTRACTOR TO ASSUME PARTIAL DEPTH CONCRETE REPAIR IS NOT NECESSARY. LIMITS OF CONCRETE REPAIR TO BE DETERMINED BY CONTRACTOR AFTER CLEANING AND INSPECTION OF WETWELL.

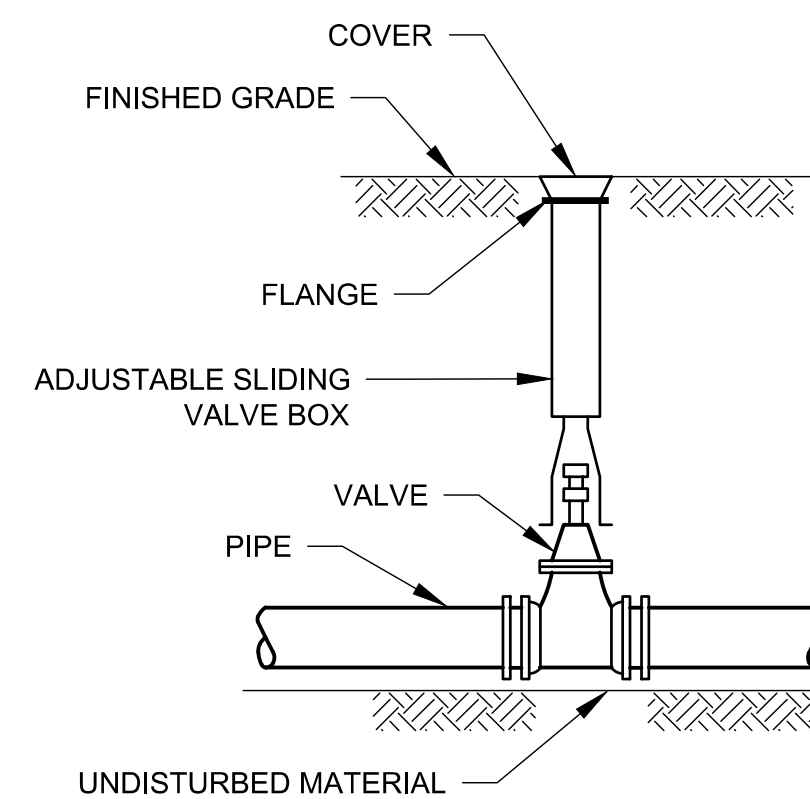

VALVE AND BOX DETAIL

N.T.S.

Project:
CITY OF ROCHESTER, NH

LEDGEVIEW SEWER PUMP STATION UPGRADE

54A LEDGEVIEW DRIVE
ROCHESTER, NH 03868

Weston & Sampson

Weston & Sampson Engineers, Inc.
100 International Drive, Suite 152
Portsmouth, NH 03801
978.532.1900 800.SAMPSON
www.westonandsampson.com

Consultants:

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Revisions:

No.	Date	Description
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Seal:

CHRISTOPHER M. PERKINS
No. 12064
LICENSED PROFESSIONAL ENGINEER

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Reviewed By: JMS
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CIVIL DETAILS

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C502


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CHRISTOPHER M. PERKINS
No. 12004
LICENSED PROFESSIONAL ENGINEER


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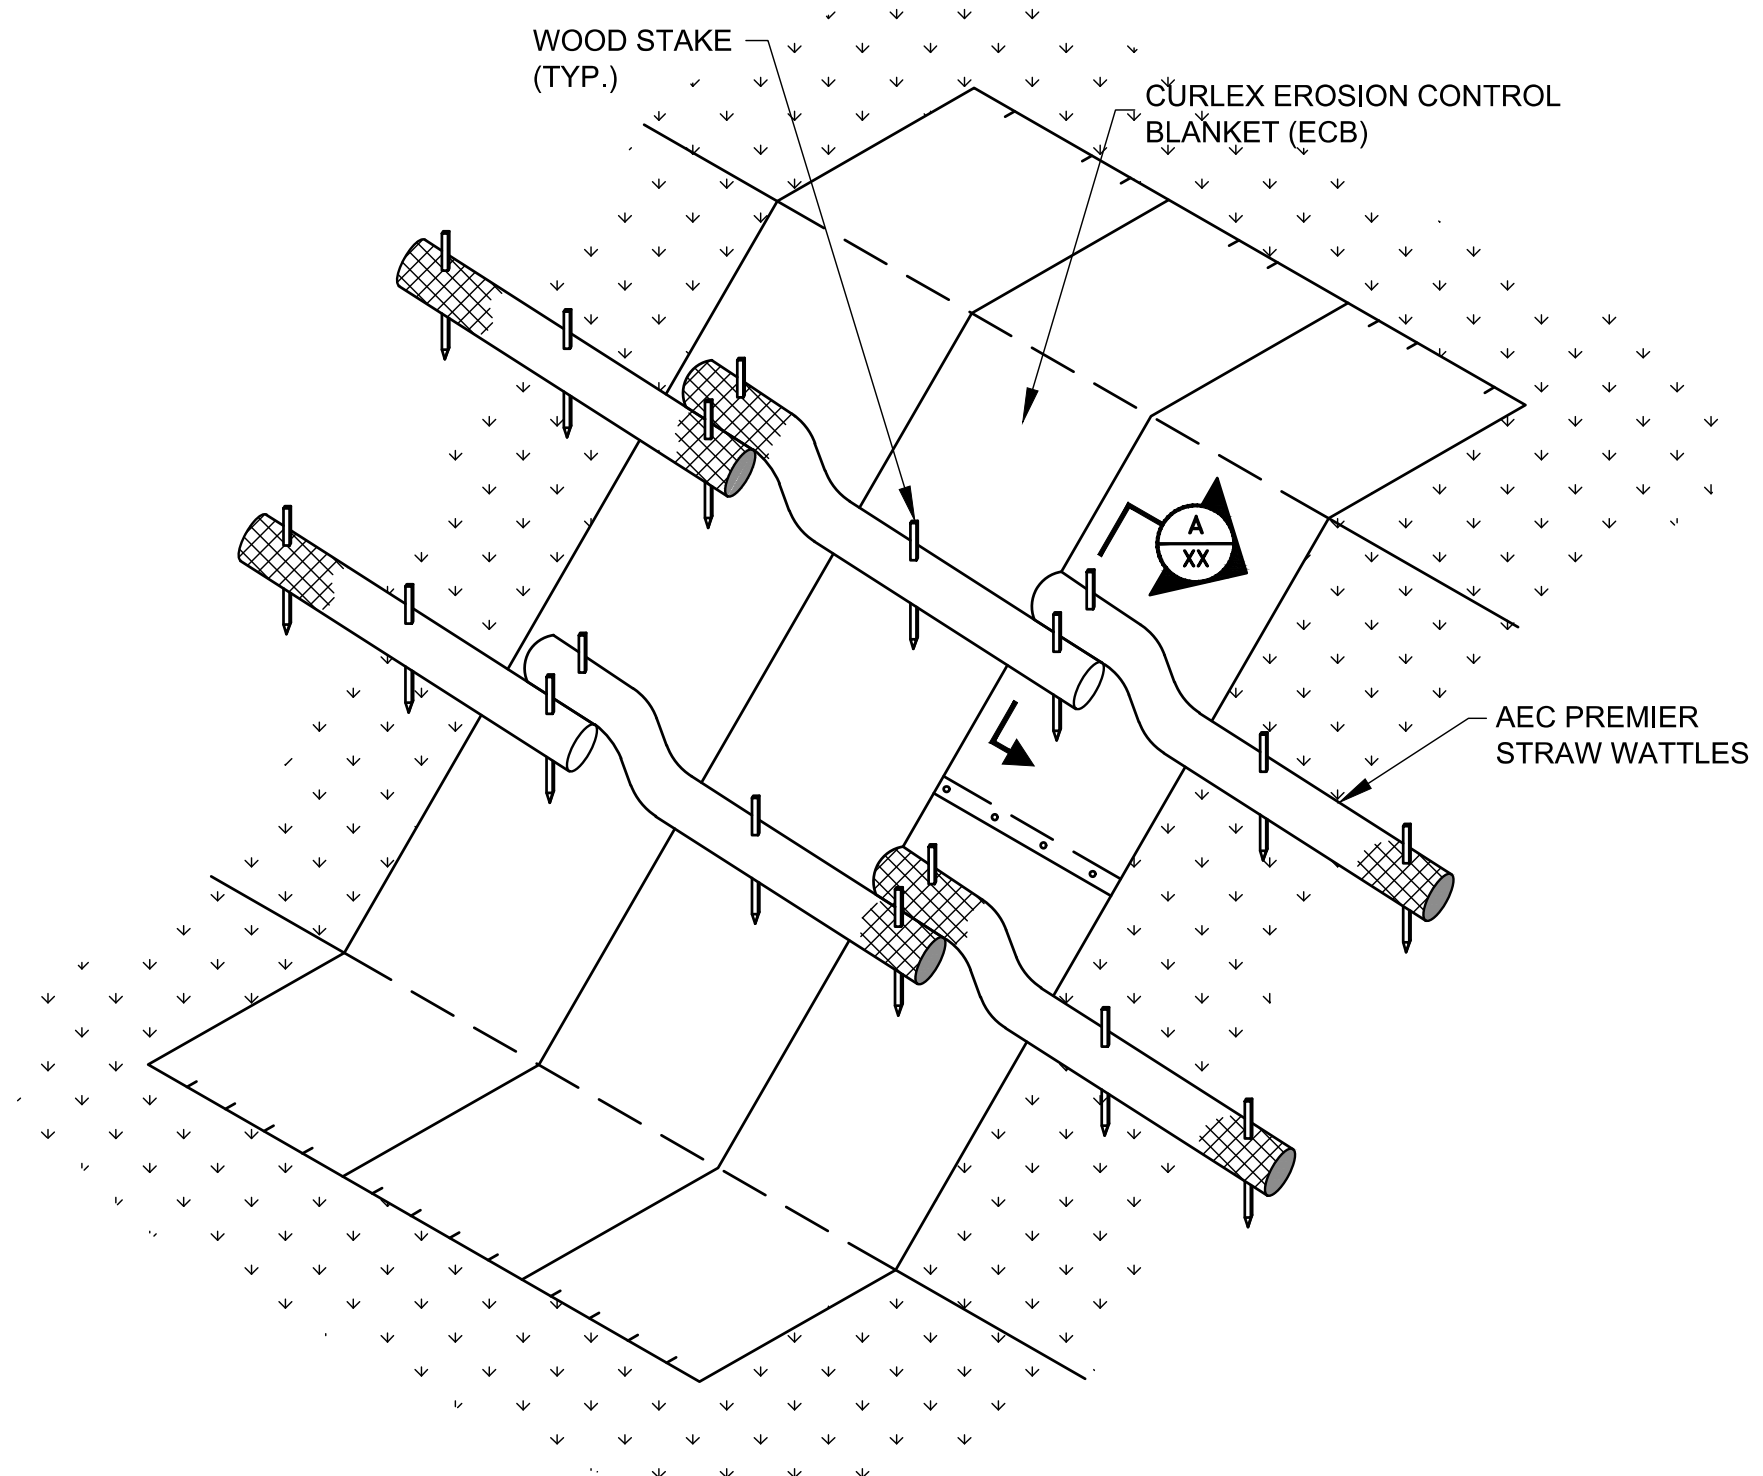
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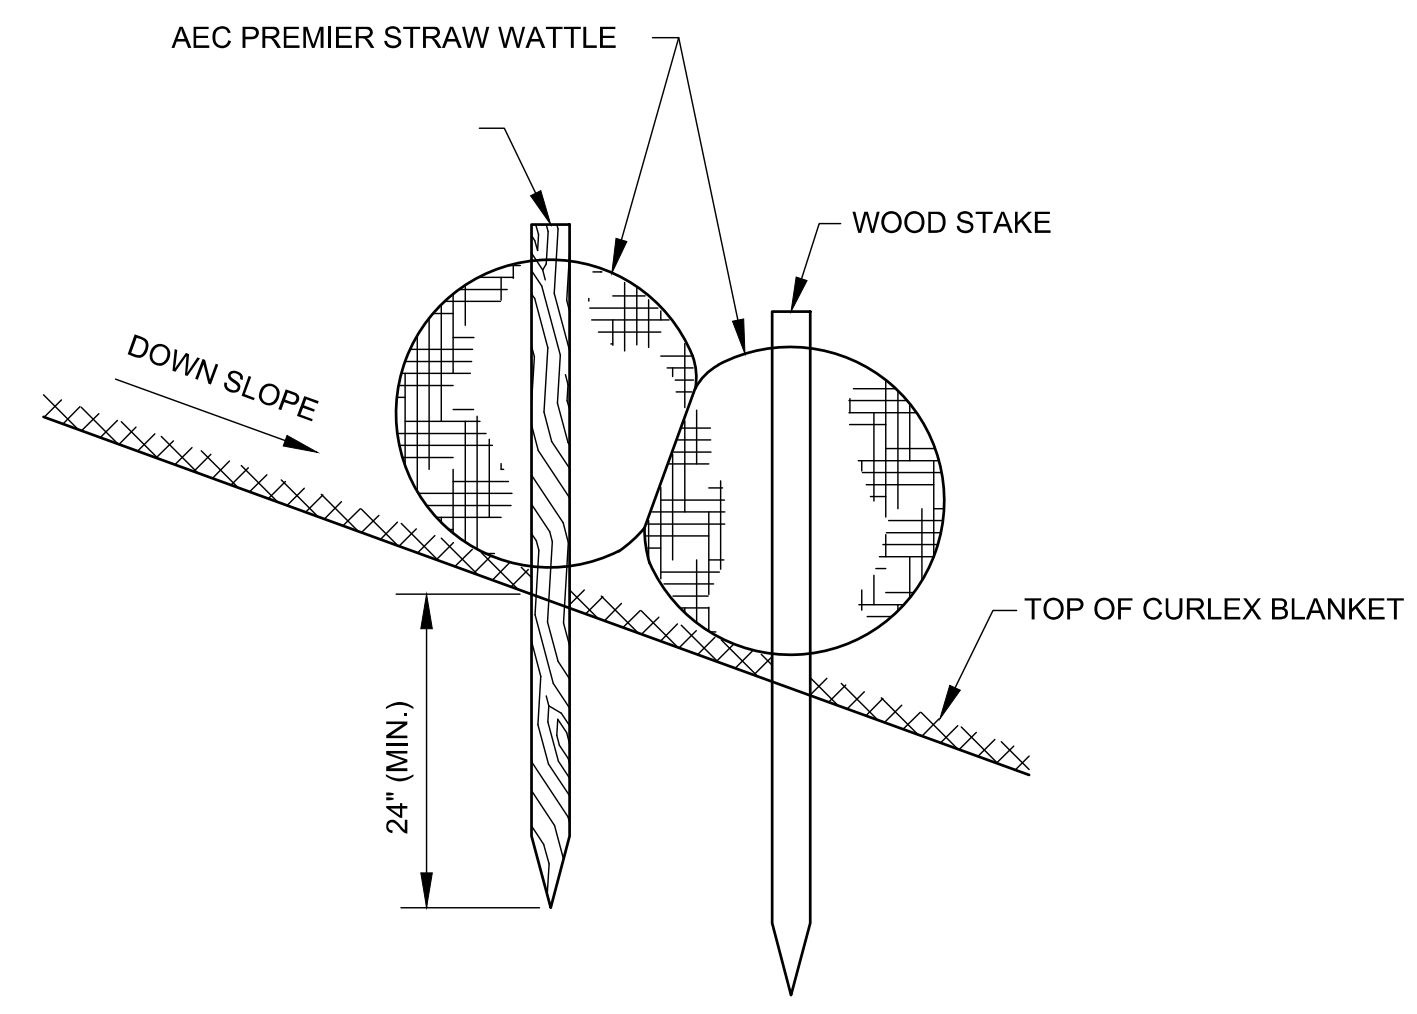
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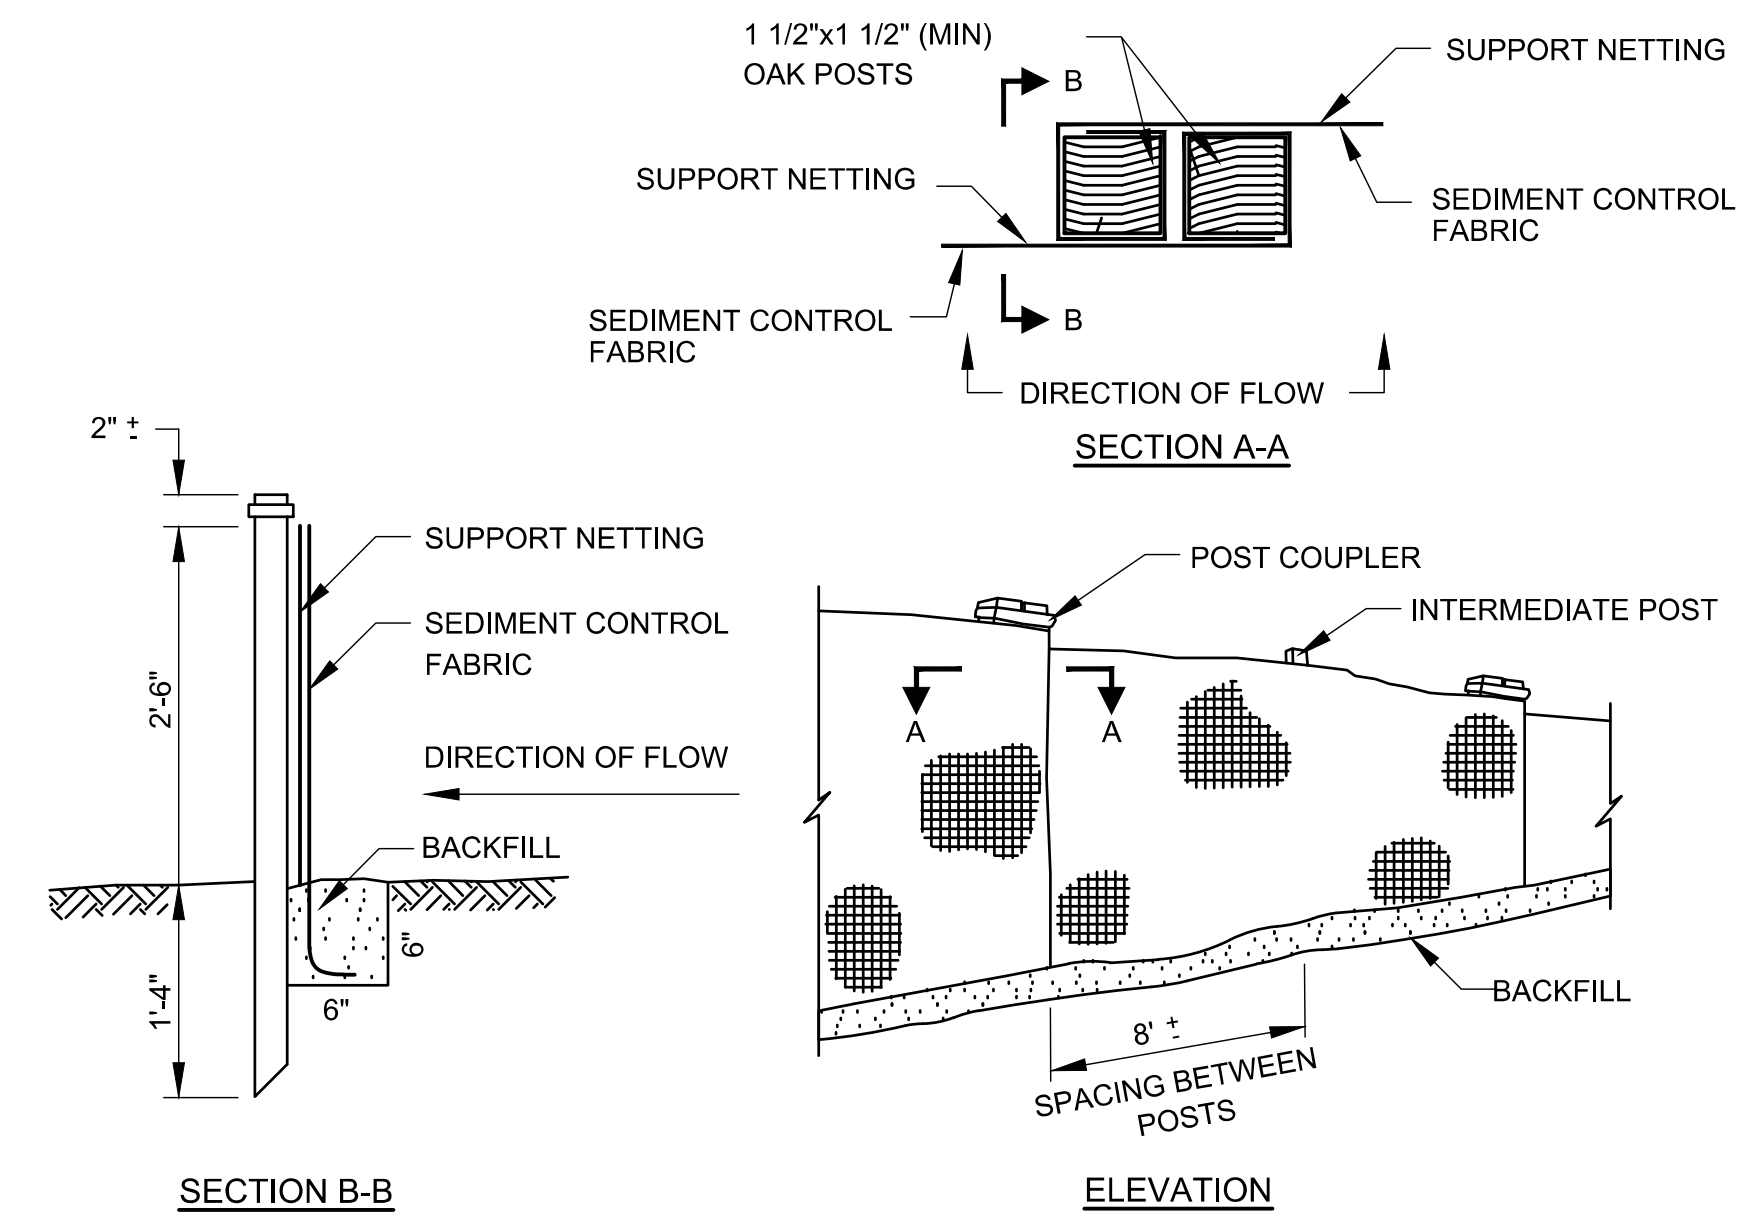
LOAM & SEED
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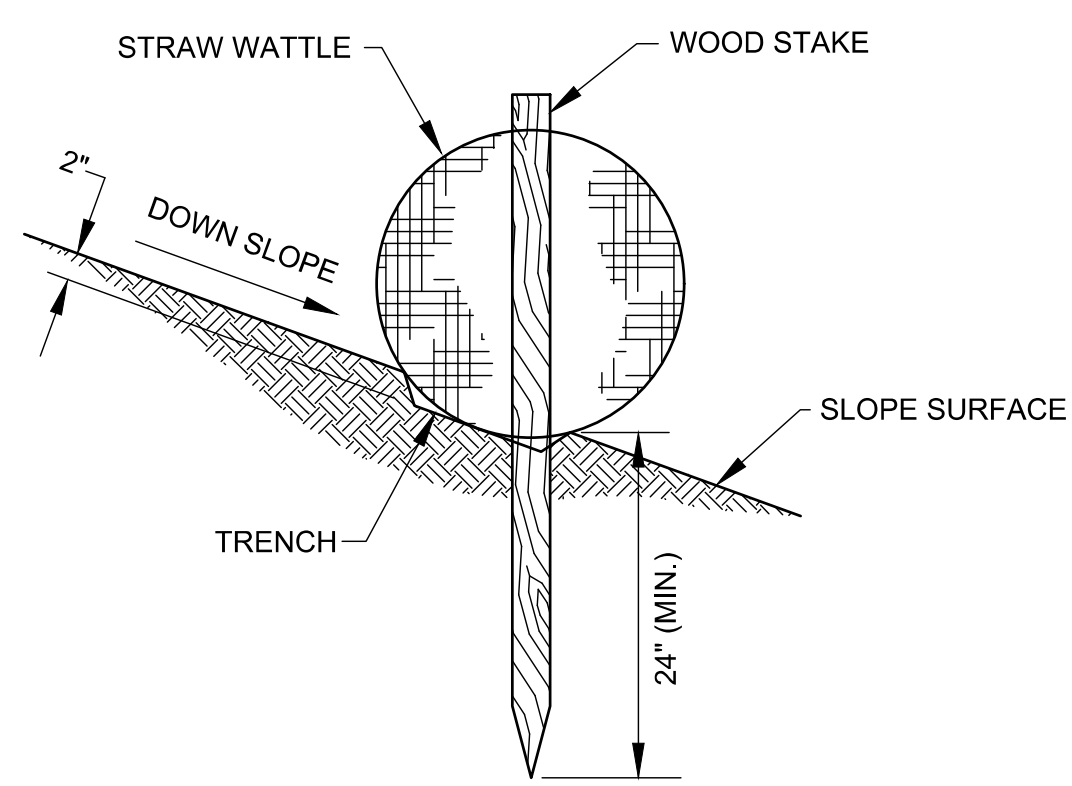
SLOPE DETAIL
N.T.S.




STAKE DETAIL SECTION A-XX
N.T.S.

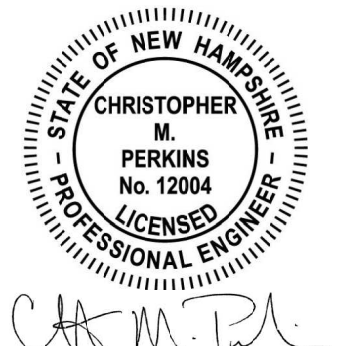


SILT FENCE DETAIL
N.T.S.

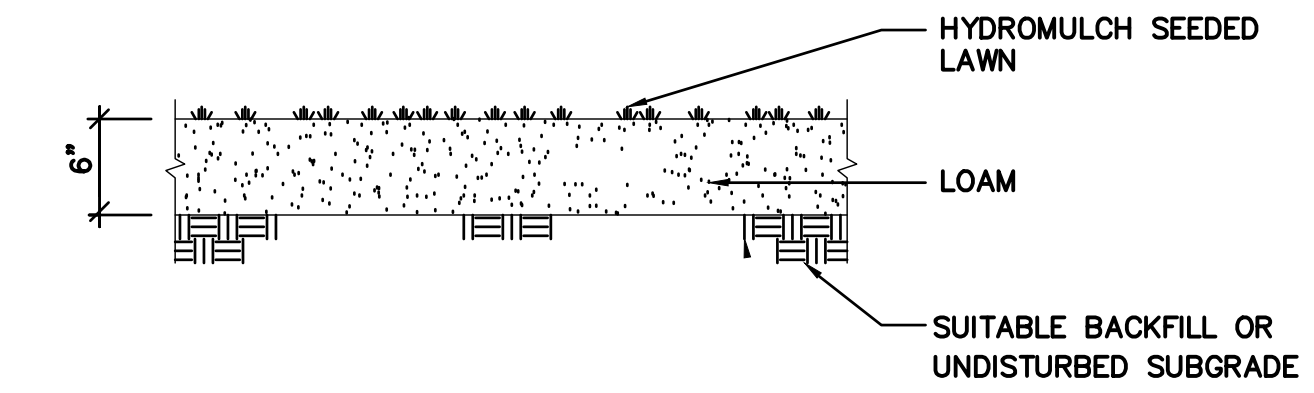

STAKE DETAIL (ON BARE SOIL)
N.T.S.

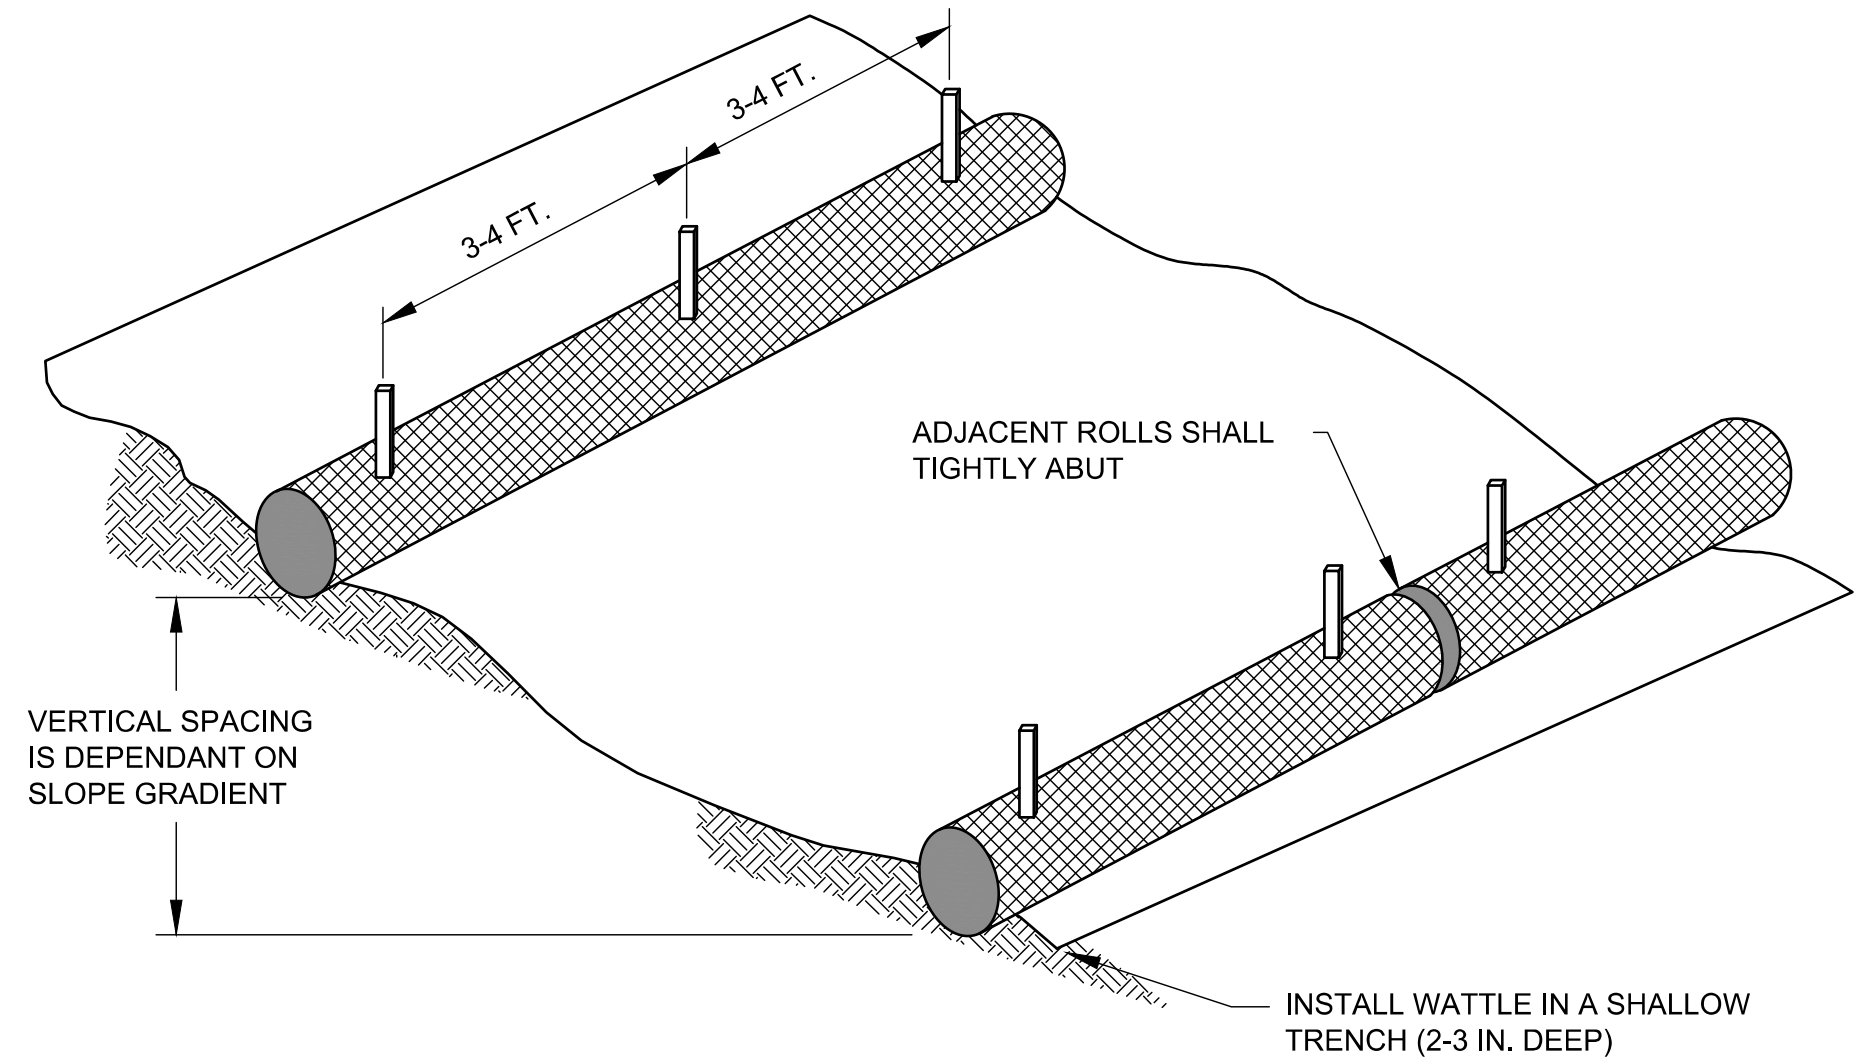

STRAW WATTLE INSTALLATION GUIDE
N.T.S.

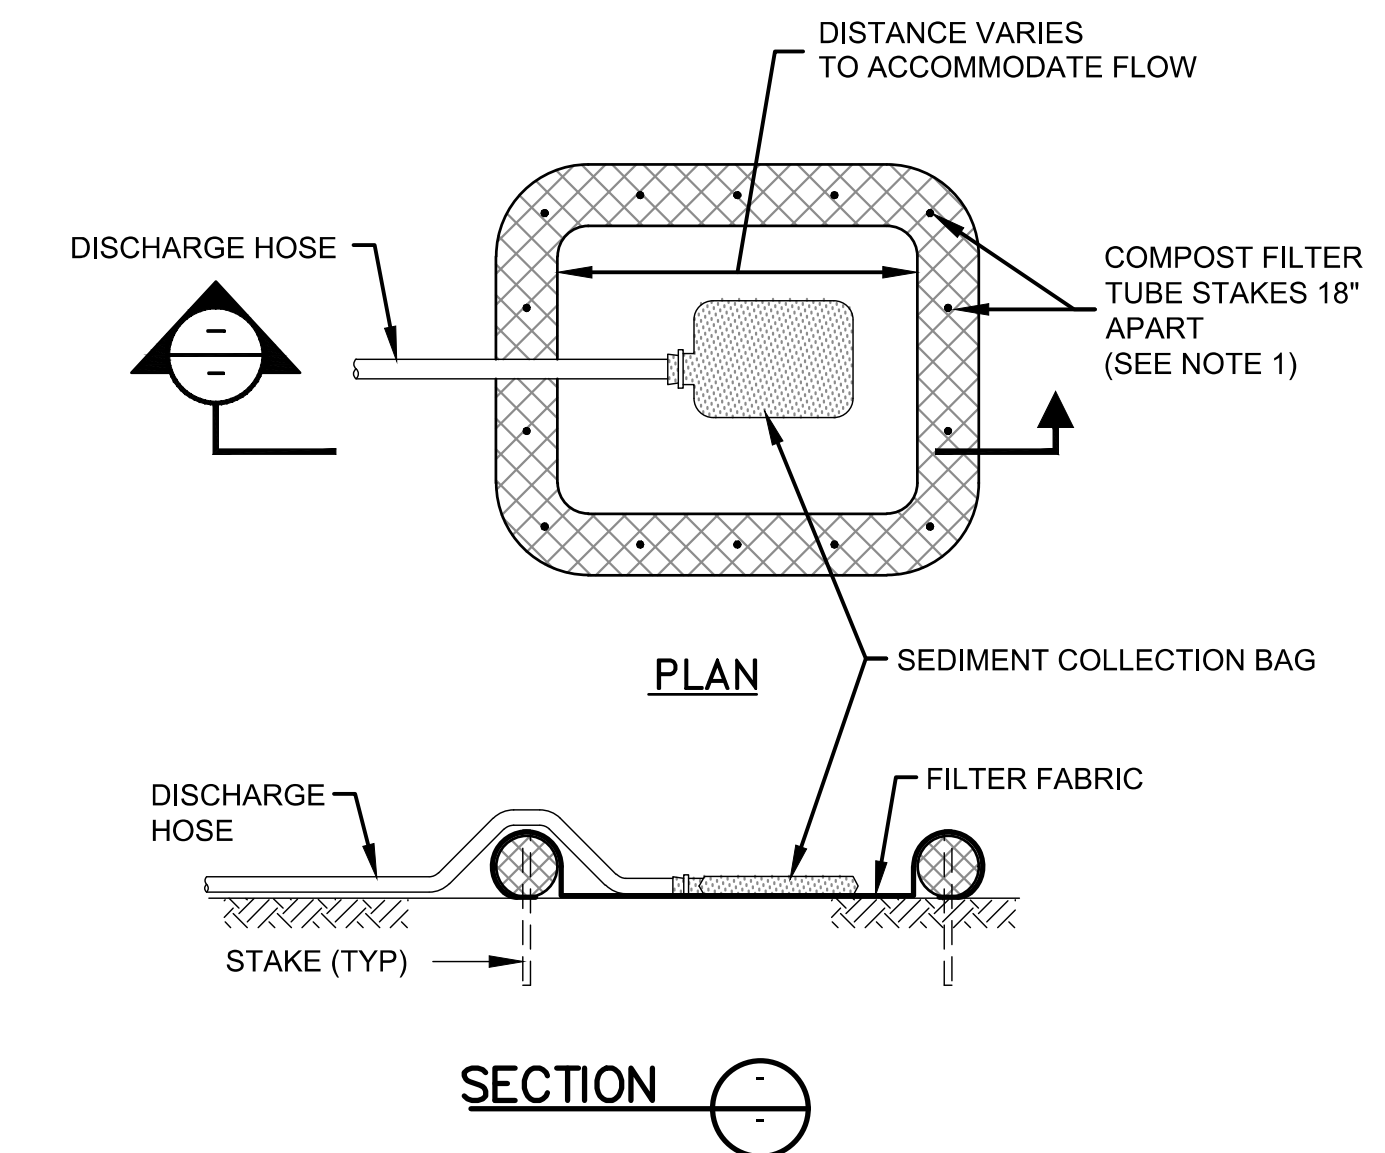

DEWATERING DISCHARGE DISPOSAL DETAIL
N.T.S.

- NOTES:**
- BEGIN AT THE LOCATION WHERE THE WATTLE IS TO BE INSTALLED BY EXCAVATING A 2-3" DEEP X 9" WIDE TRENCH ALONG THE CONTOUR OF THE SLOPE. EXCAVATED SOIL SHOULD BE PLACED UP-SLOPE FROM THE ANCHOR TRENCH.
 - PLACE THE WATTLE IN THE TRENCH SO THAT IT CONTOURS TO THE SOIL SURFACE. COMPACT SOIL FROM THE EXCAVATED TRENCH AGAINST THE WATTLE ON THE UPHILL SIDE. ADJACENT WATTLES SHOULD TIGHTLY ABUT.
 - SECURE THE WATTLE WITH 18-24" STAKES EVERY 3-4' AND WITH A STAKE ON EACH END. STAKES SHOULD BE DRIVEN THROUGH THE MIDDLE OF THE WATTLE LEAVING AT LEAST 2-3" OF STAKE EXTENDING ABOVE THE WATTLE. STAKES SHOULD BE DRIVEN PERPENDICULAR TO SLOPE FACE.

- NOTE:**
- WHEN STAKING IS NOT POSSIBLE, SUCH AS WHEN TUBES MUST BE PLACED ON PAVEMENT, HEAVY CONCRETE OR CINDER BLOCKS CAN BE USED BEHIND TUBES UP TO 5 FT. APART OR AS REQUIRED TO SECURE TUBES IN PLACE.

Weston & Sampson Engineers, Inc. 100 International Drive, Suite 152 Portsmouth, NH 03801 978.532.1900 800.SAMPSON www.westonandsampson.com

GENERAL NOTES:

- 1. COORDINATE THE ARCHITECTURAL DRAWINGS WITH STRUCTURAL, PLUMBING, FIRE PROTECTION AND ELECTRICAL / FIRE ALARM DRAWINGS FOR THE VERIFICATION OF ALL PROJECT REQUIREMENTS.
2. FINISH FIRST FLOOR SLAB ELEVATION HIGH POINT IS 0'-0" FOR THIS PROJECT.
3. ALL INTERIOR DIMENSIONS ARE TAKEN FROM FACE OF STUD / FACE OF MASONRY / CENTERLINE OF COLUMN TO FACE OF STUD / FACE OF MASONRY / CENTERLINE OF COLUMN UNLESS SPECIFICALLY NOTED OTHERWISE. DO NOT SCALE DRAWINGS TO ENLARGED PLANS AND DETAILS FOR FURTHER DIMENSIONING INFORMATION. ALL WORK LINES AND LEVELS SHALL BE LAID OUT BY WRITTEN DIMENSIONS. ANY DEVIATIONS SHALL BE BROUGHT TO THE ATTENTION OF THE DESIGNER. ALL DEVIATIONS AND DISCREPANCIES SHALL BE CORRECTED BY THE CONTRACTOR BEFORE HE BEGINS HIS PORTION OF THE WORK.
4. FIRE EXTINGUISHER AND CABINET QUANTITIES AND LOCATIONS TO BE COORDINATED WITH THE TOWN FIRE DEPARTMENT PRIOR TO ORDERING AND INSTALLATION. CONFORM TO THE STATE FIRE REGS AND NFPA.
5. COORDINATE MASTER BOX, KNOX BOX, AND BEACON LOCATIONS WITH THE ELECTRICAL / FIRE ALARM DRAWINGS AND THE TOWN FIRE DEPARTMENT REQUIREMENTS. ELECTRICAL CONTRACTOR TO PROVIDE KNOX BOX THAT MEET THE TOWN FIRE DEPARTMENT REQUIREMENTS.
6. THE CONTRACTOR SHALL FIELD VERIFY ALL DIMENSIONS & CONDITIONS PRIOR TO THE WORK AND SHALL NOTIFY THE DESIGNER REGARDING ANY DISCREPANCIES.
7. THE CONTRACTOR SHALL SUBMIT ALL SHOP DRAWINGS, SAMPLES, CATALOG CUTS ETC., INCLUDING COLOR CHARTS FOR PAINTS, FOR ALL INTERIOR FINISHES. TO THE DESIGNER FOR SELECTION, REVIEW AND APPROVAL WITH THE OWNER PRIOR TO FABRICATION OR INSTALLATION. THE COLORS MUST BE SUBMITTED IN A TIMELY MANNER AND TOGETHER FOR REVIEW AND COLOR BOARDS. FAILURE TO DO SO IN A TIMELY MANNER WILL FALL ON THE CONTRACTOR'S RESPONSIBILITY AND NOT ON THE OWNER. REFER TO EACH INDIVIDUAL SPECIFICATIONS FOR SIZE, QUANTITY AND TYPE OF COLOR SELECTION.
8. PERFORM ALL WORK IN ACCORDANCE WITH THE STATE BUILDING CODE, AS WELL AS LOCAL CODES AND ORDINANCES.
9. THE CONTRACTOR SHALL BE RESPONSIBLE FOR ALL PERMITS, BACKCHARGES AND FEES AS REQUIRED BY THE TOWN.
10. THE CONTRACTOR SHALL BE RESPONSIBLE FOR DAILY REMOVAL AND LEGAL DISPOSAL OF ALL DEBRIS OFF SITE.
11. THE CONTRACTOR SHALL SEAL ALL THROUGH-WALL & FLOOR PENETRATIONS WITH 3M BARRIER CAULK (O.A.E.) AND SEALANT ON USE SAFING 2500 PSI GROUT. UNLESS OTHERWISE SPECIFIED, ALL REQUIRED FIRE RATED PARTITIONS TO UNDERSIDE OF FLOOR AND ROOF DECK, INCLUDING DEFLECTION HEAD FIRE SAFING.
12. INSTALL A CONTINUOUS SEALANT BEAD ON BACKER ROD AT ALL JUNCTURES OF DISSIMILAR MATERIALS (E.G.: METAL TO CMU, STEEL TO ALUMINUM) AND ALL MATERIAL JOINTS AS REQUIRED BY THE MANUFACTURER'S SPECIFICATION AND RECOMMENDATIONS, INDUSTRY STANDARDS AND GOOD PRACTICE.
13. PROVIDE CONTINUOUS GALVANIZED METAL EDGE TRIM AT ALL GWB WORK.
14. THE CONTRACTOR SHALL INSTALL ALL INTERIOR FINISHES AT ALL SURFACES INDICATED ON THE DRAWINGS IN CONFORMANCE TO STATE BUILDING CODE. ALL DOORS SHALL HAVE LEVER HARDWARE TO CONFORM TO S21 CMR.
15. INSTALL USG .093 (OR APPROVED EQUAL) CONTROL JOINTS AT 30'-0" O.C. MAX. OR AS PER MANUFACTURER'S SUGGESTED DETAILS AND SPECIFICATIONS.
16. THE CONTRACTOR IS RESPONSIBLE FOR PROVIDING A GAP FILLING SYSTEM OR OTHER SYSTEM WHICH SPANS ANY GAP IN THE EXTERIOR WALL SYSTEM WHICH DOES NOT MEET THE MAXIMUM SPAN OF THE APPROVED AIR BARRIER MEMBRANE SYSTEM. THIS SYSTEM SHALL BE PROVIDED TO ALLOW FOR A COMPLETE AIR BARRIER MEMBRANE INSTALLATION. THE SYSTEM SHALL BE COMPATIBLE WITH THE APPROVED AIR BARRIER PRODUCT AND SHALL BE APPROVED BY THE DESIGNER PRIOR TO INSTALLATION.
17. THE ELECTRICAL CONTRACTOR SHALL PROVIDE DISCONNECT SWITCHES, STARTERS AND ALL LINE VOLTAGE WIRING AND CONDUIT TO OH DOOR OPERATORS, THE HAND-OFF-AUTO SWITCH, PUSH BUTTON CONTROL STATION (MOMENTARY UP-STOP-DOWN) AND CONTROLLER IS FURNISHED BY THE OVERHEAD DOOR MANUFACTURER AND INSTALLED BY THE ELECTRICAL CONTRACTOR. THE ELECTRICAL CONTRACTOR IS TO PROVIDE CONDUIT AND WIRING BETWEEN THE HAND-OFF-AUTO SWITCH, THE PUSH BUTTON CONTROL STATION AND CONTROLLER PER OVERHEAD DOOR MANUFACTURER REQUIREMENTS, FURNISHING AND INSTALLATION OF THE MOTOR UNIT, OPTICAL SENSORS, PNEUMATIC DOOR SAFETY BOTTOM, LOW VOLTAGE WIRING AND ALL OTHER ACCESSORIES ASSOCIATED WITH THE OVERHEAD DOORS SHALL BE THE RESPONSIBILITY OF THE OVERHEAD DOOR CONTRACTOR.
18. ALL STRUCTURAL ELEMENTS WHICH PASS IN FRONT OF WINDOWS / CLERESTORIES SHALL BE BACK PAINTED.
19. ALL STRUCTURAL ELEMENTS SHOWN ON THE ARCHITECTURAL DRAWINGS ARE FOR INFORMATION ONLY. REFER TO STRUCTURAL DRAWINGS FOR EXACT SIZES AND LOCATION OF STRUCTURAL ELEMENTS.
20. THE CONTRACTOR SHALL PROVIDE SUPPLEMENTAL FRAMING AND OR BLOCKING AS NECESSARY TO SUPPORT ALL EXTERIOR WALL MOUNTED ELEMENTS.
21. ALL OPENINGS IN EXTERIOR WALLS FOR PLUMBING, FIRE PROTECTION, MECHANICAL, AND ELECTRICAL / FIRE ALARM SYSTEMS SHALL BE SEALED WEATHER-TIGHT BY THE CONTRACTOR. CONTRACTOR TO PROVIDE FIRE RATED SEALANTS AS REQUIRED AT FIRE RATED WALL, FLOOR, CEILING, AND ROOF ASSEMBLIES.
22. THE CONTRACTOR IS TO FIELD MEASURE OH DOOR OPENINGS TO ENSURE PROPER FIT OF OH DOORS.
23. ALL EXPOSED SURFACES (INCLUDING, BUT NOT LIMITED TO; WALLS, UNDERSIDE OF EXPOSED ROOF AND FLOOR DECK, STRUCTURAL STEEL, MISCELLANEOUS METALS, DOORS/FRAMES, DUCTWORK, CONDUIT, AND PIPING) SHALL BE PRIMED AND PAINTED.
24. BLOCKING SHALL BE PROVIDED FOR ALL WALL MOUNTED EQUIPMENT (INCLUDING, BUT NOT LIMITED TO; PLUMBING FIXTURES, TOILET ACCESSORIES, UTILITY SINKS, FIRE EXTINGUISHER CABINETS, SHELVING, COUNTERS, CASEWORK, CABINETS, MEDIA EQUIPMENT, AND WINDOW TREATMENTS). PROVIDE ADDITIONAL METAL STUD FRAMING AS REQUIRED TO SUPPORT BLOCKING.

ABBREVIATIONS:

Table with columns A, B, C, D, E, F, G, H, I, J, K, L, M, N, O, P, Q, R, S, T, U, V, W, X, Y, Z. Each column lists abbreviations and their corresponding full names, such as AC (AIR CONDITION), CAB (CABINET), and W (WASHER).

SYMBOLS:

Diagrammatic symbols for exterior and interior elevations, building sections, wall sections, details, partition types, exterior wall assemblies, door types, window types, roof types, specific demolition and construction notes, change in elevation, dimension lines, control joints, elevation or work point, column grids, existing column grids, align surfaces, revision markers, and room tags.

LEGEND:

Legend showing material patterns and their corresponding names: RIGID/SEMI-RIGID INSULATION, CONCRETE, SAND / P.C. CONCRETE, PARTICLE BOARD / MDF, PLYWOOD/MDO, FINISH WOOD, ALUMINUM, STEEL, PVC, FIBER CEMENT, CONCRETE MASONRY UNIT, BRICK, MORTAR, GROUT, TERRA COTTA, EARTH, GRAVEL, SPRAY FOAM, INSULATED METAL PANEL, WOOD STUDS/FRAMING (DIMENSIONAL LUMBER), WOOD BLOCKING, BATT INSULATION / SOUND ATTENUATION BLANKET, MATCHLINE.

Project information: CITY OF ROCHESTER, NH; LEDGEVIEW SEWER PUMP STATION UPGRADE; 54A LEDGEVIEW DRIVE, ROCHESTER, NH 03688.

Weston & Sampson logo and contact information: Weston & Sampson Engineers, Inc., 55 Walkers Brook Drive, Suite 100, Reading, MA 01868. Phone: 978.532.1900, 800.SAMPSON.

Consultants table with columns: No., Date, Description. Row 1: 03/07/2024, 90% DESIGN REVIEW. Row 2: 04/24/2024, ISSUED FOR BIDDING.








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Professional seal for Daniel G. Tenney III, Licensed Architect, State of New Hampshire, No. 04378.

Issued For BIDDING notice. Includes scale (As indicated), key plan, date (04/24/2024), drawn by (DGG), reviewed by (JC), approved by (DT), W&S Project No. (ENG23-0367), and W&S File No.

Drawing title: ABBREVIATIONS, SYMBOLS, LEGEND & GENERAL NOTES. Sheet Number: A001.

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FLOOR PLAN GENERAL NOTES:

- EQUIPMENT SHOWN FOR REFERENCE ONLY. SEE PROCESS DRAWINGS FOR MORE INFO.
- ALL INTERIOR DIMENSIONS ARE TAKEN FROM FACE OF PLYWOOD WALL BOARD TO FACE OF PLYWOOD WALL BOARD UNLESS SPECIFICALLY NOTED OTHERWISE.

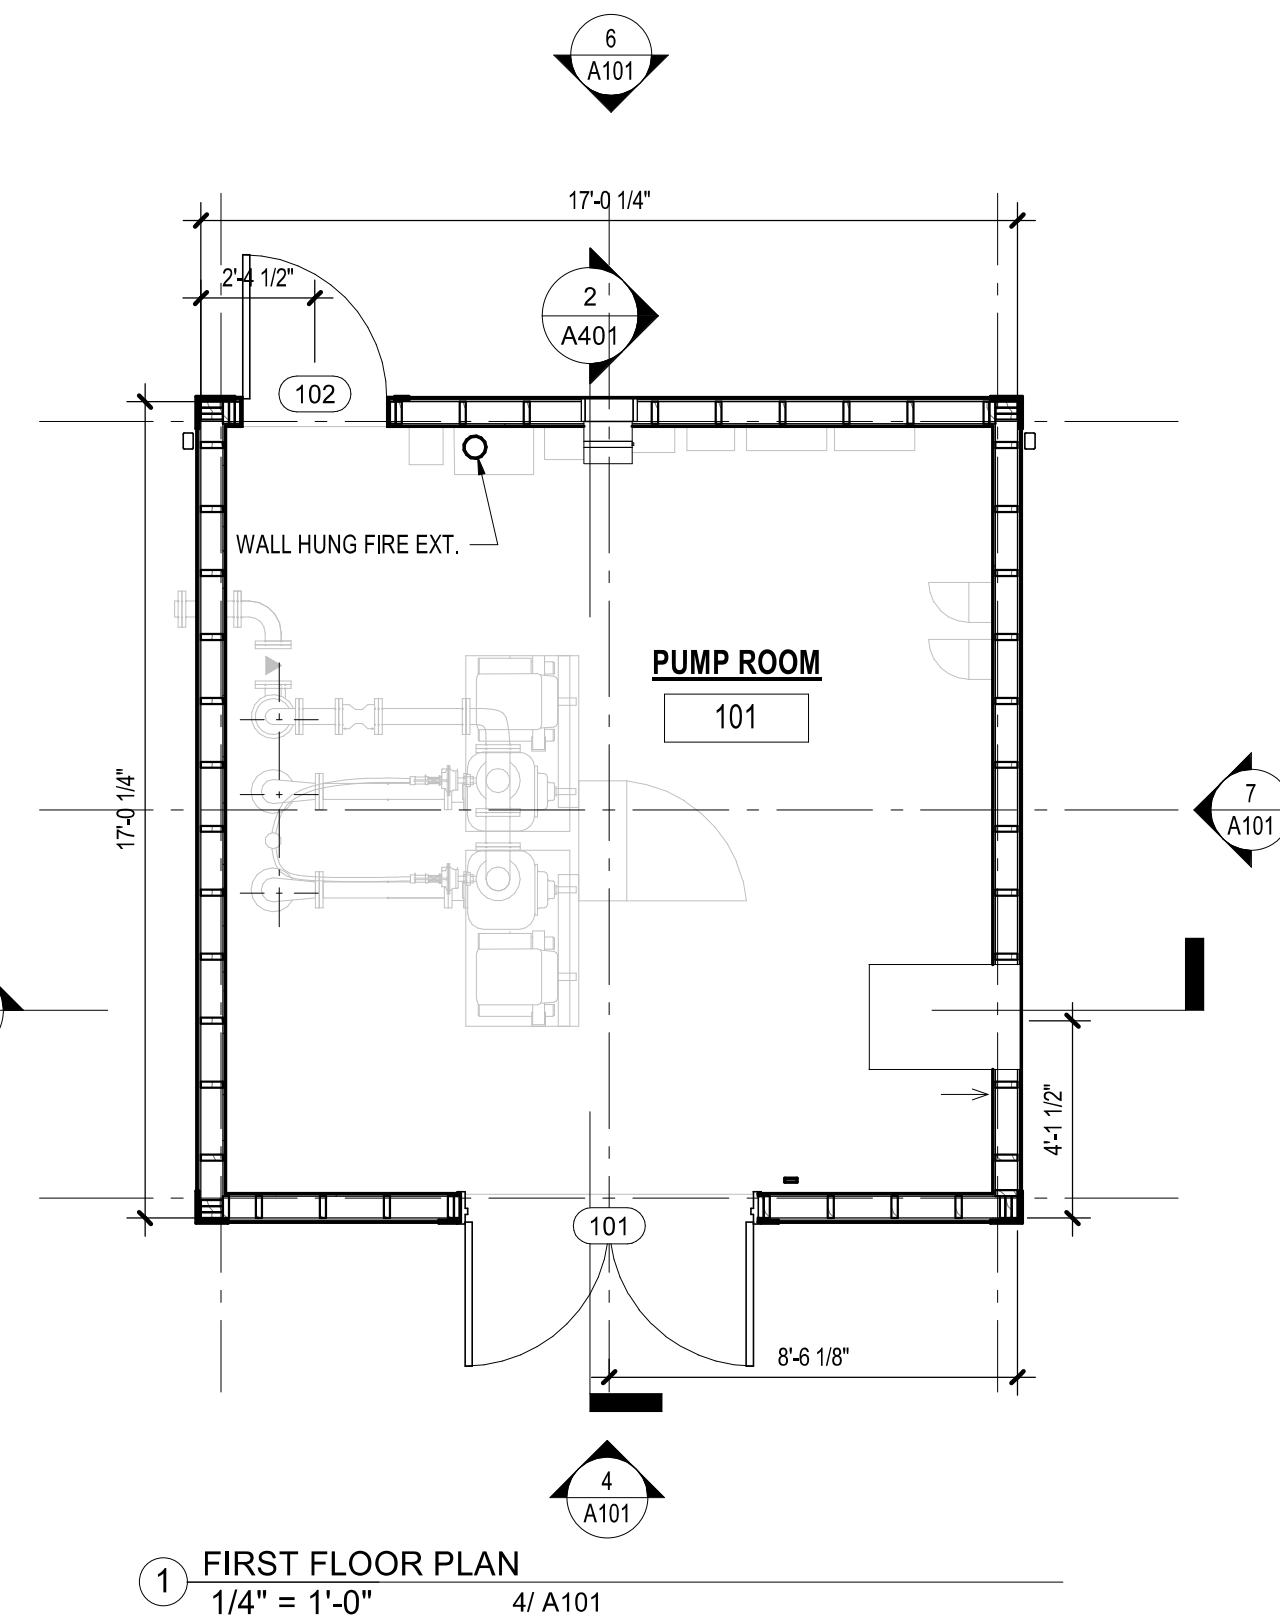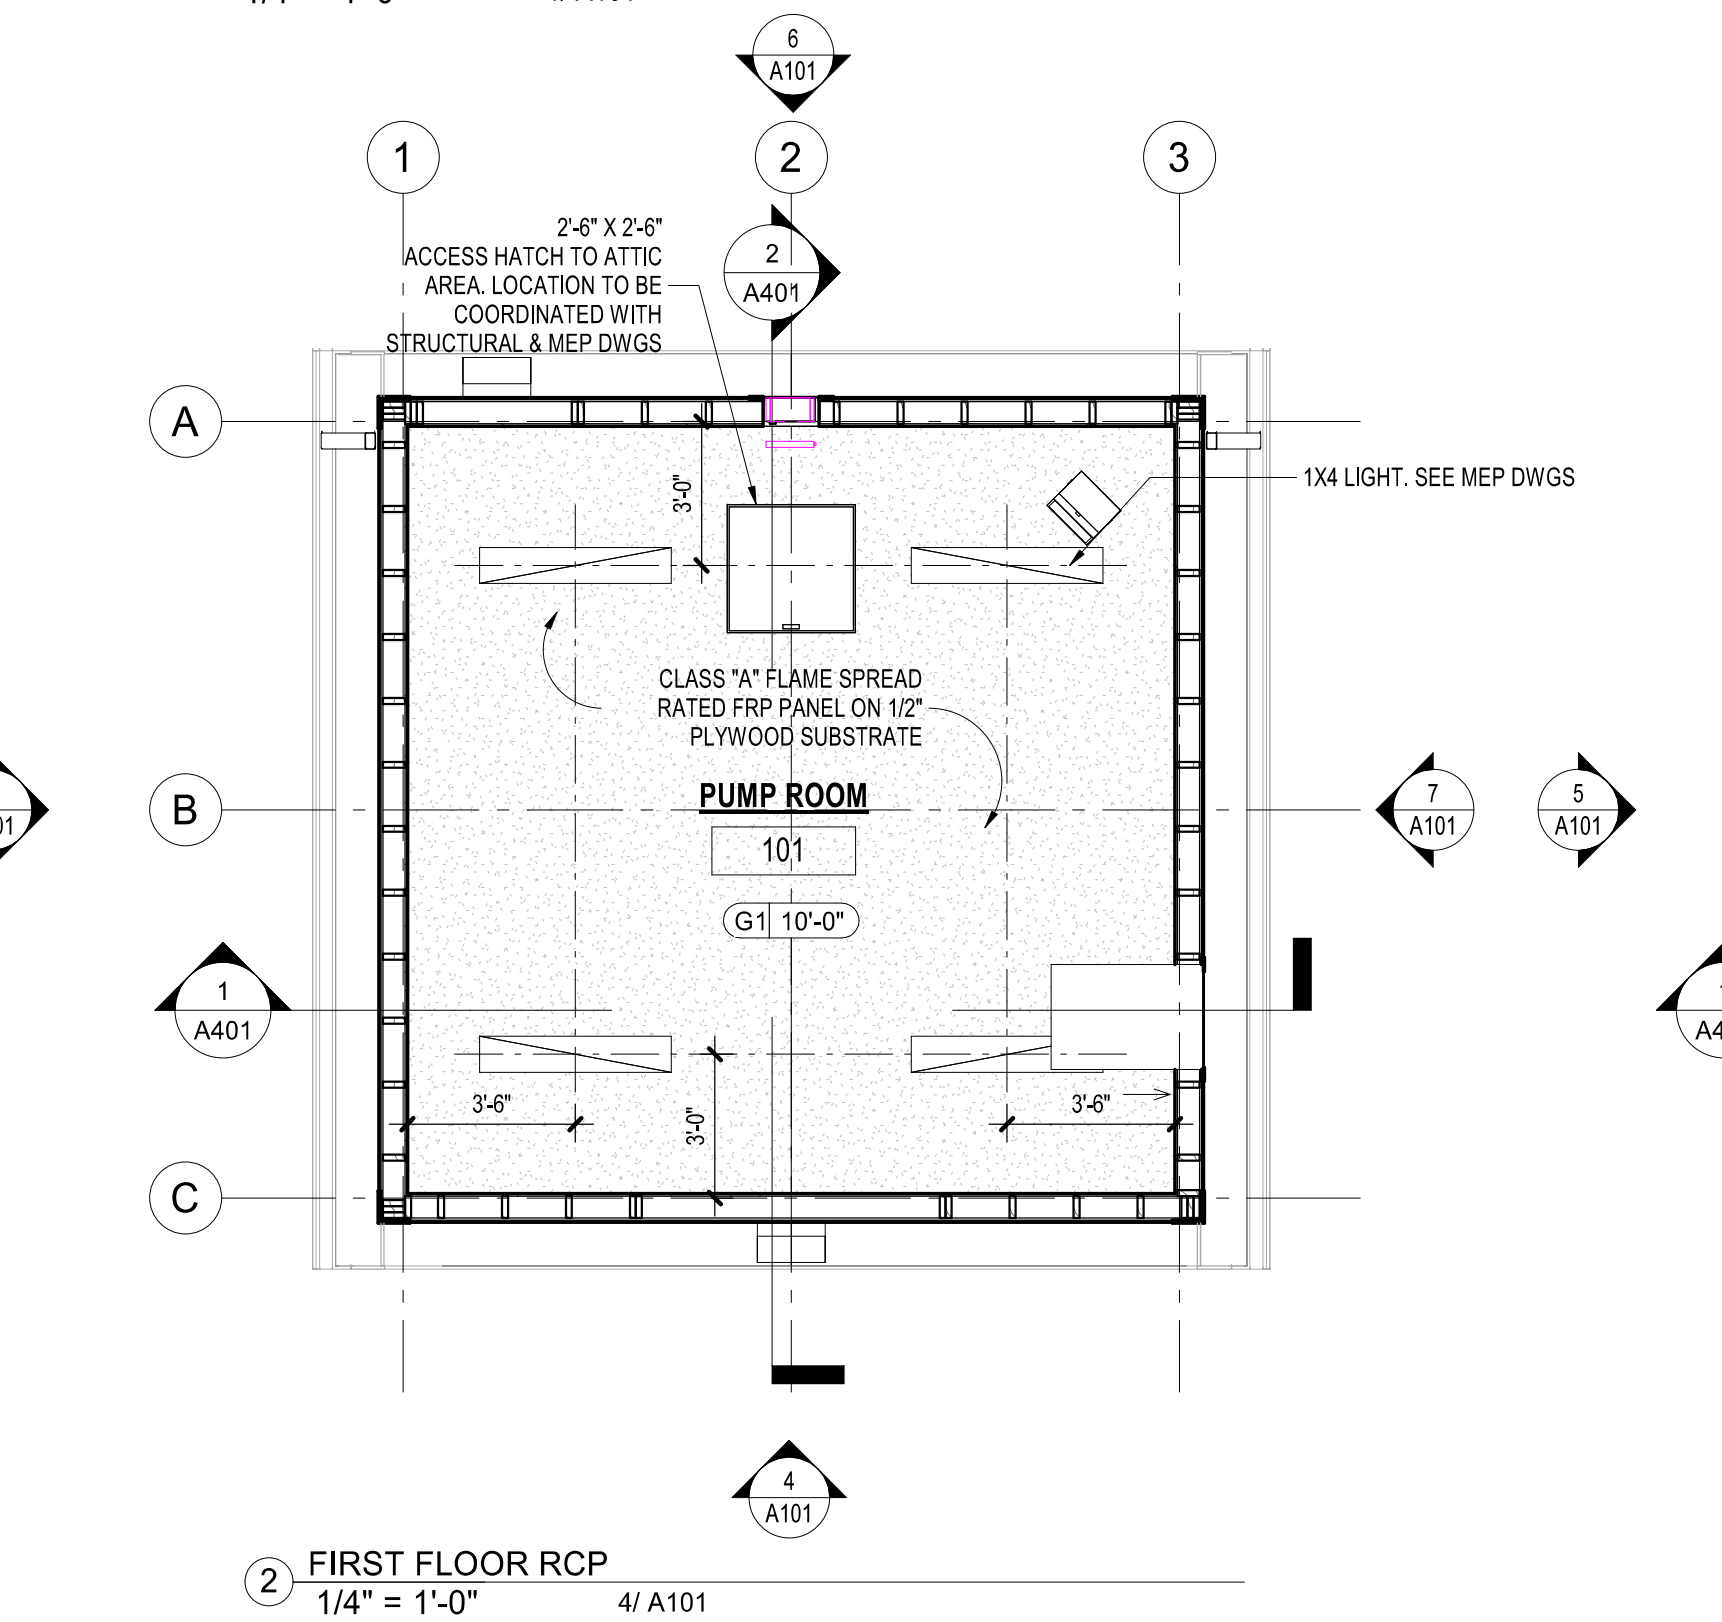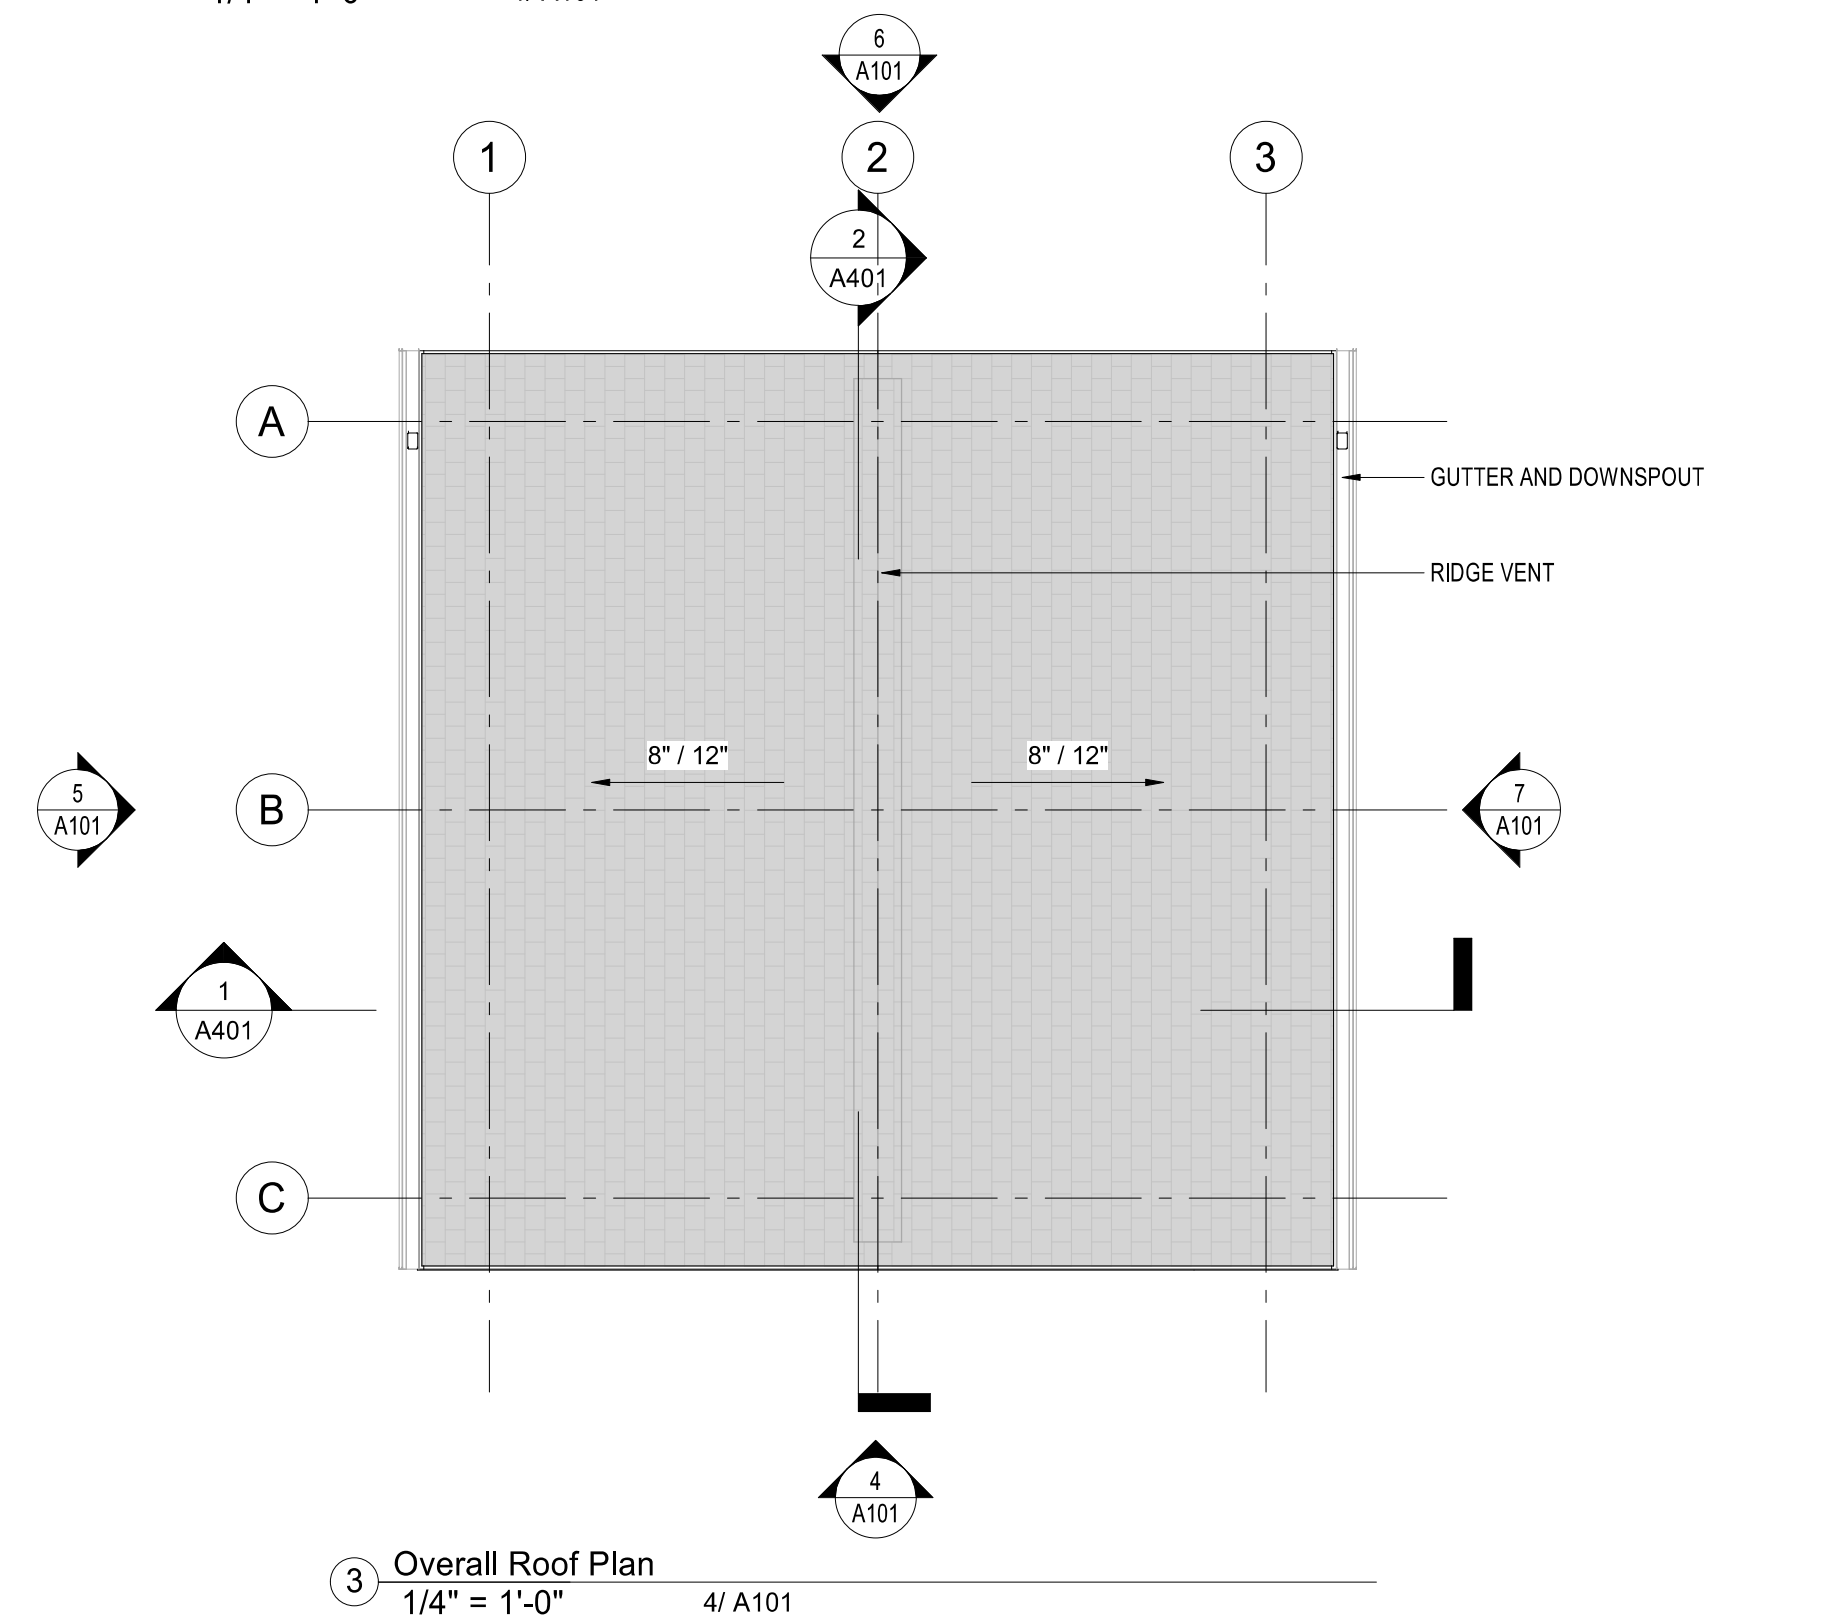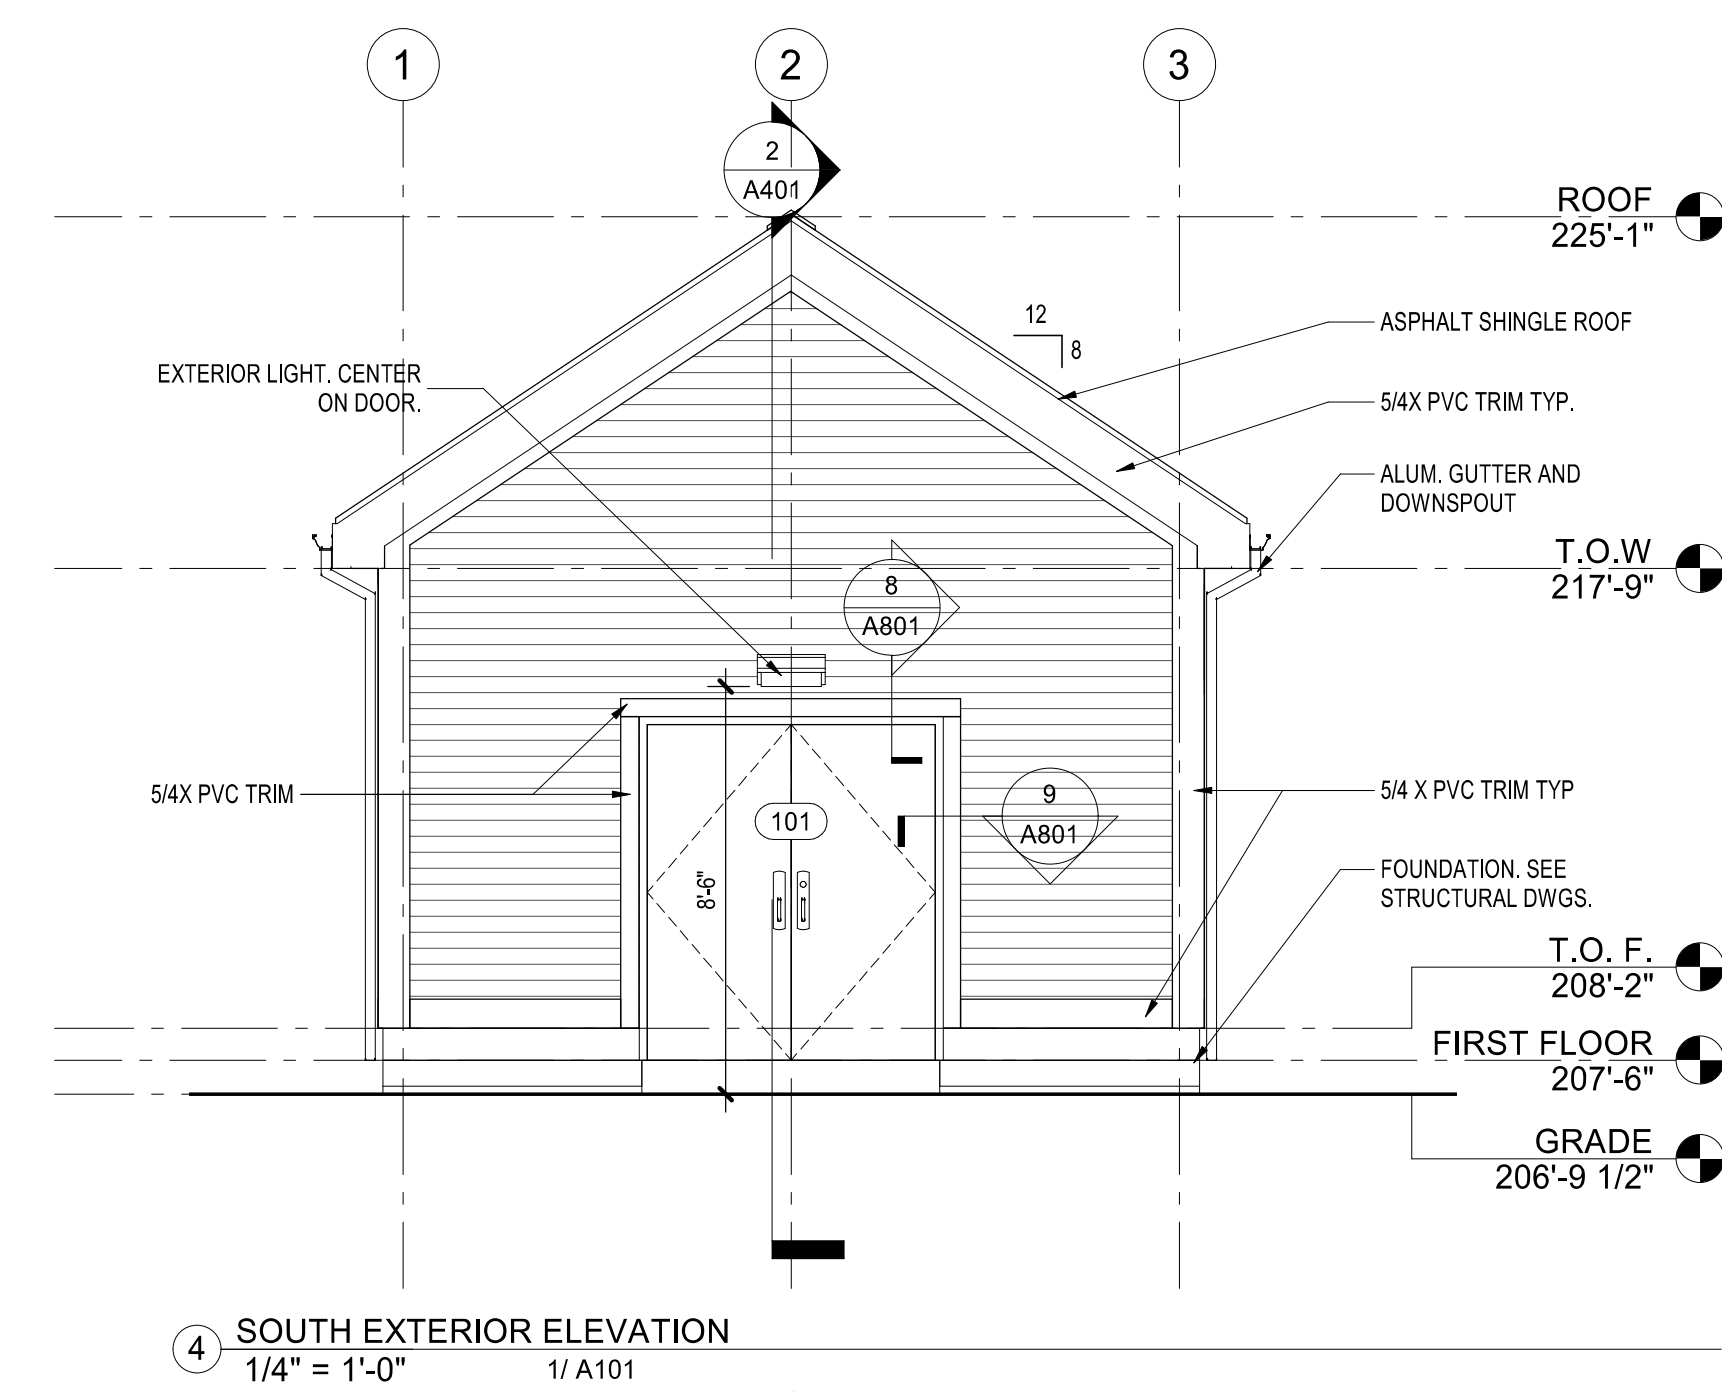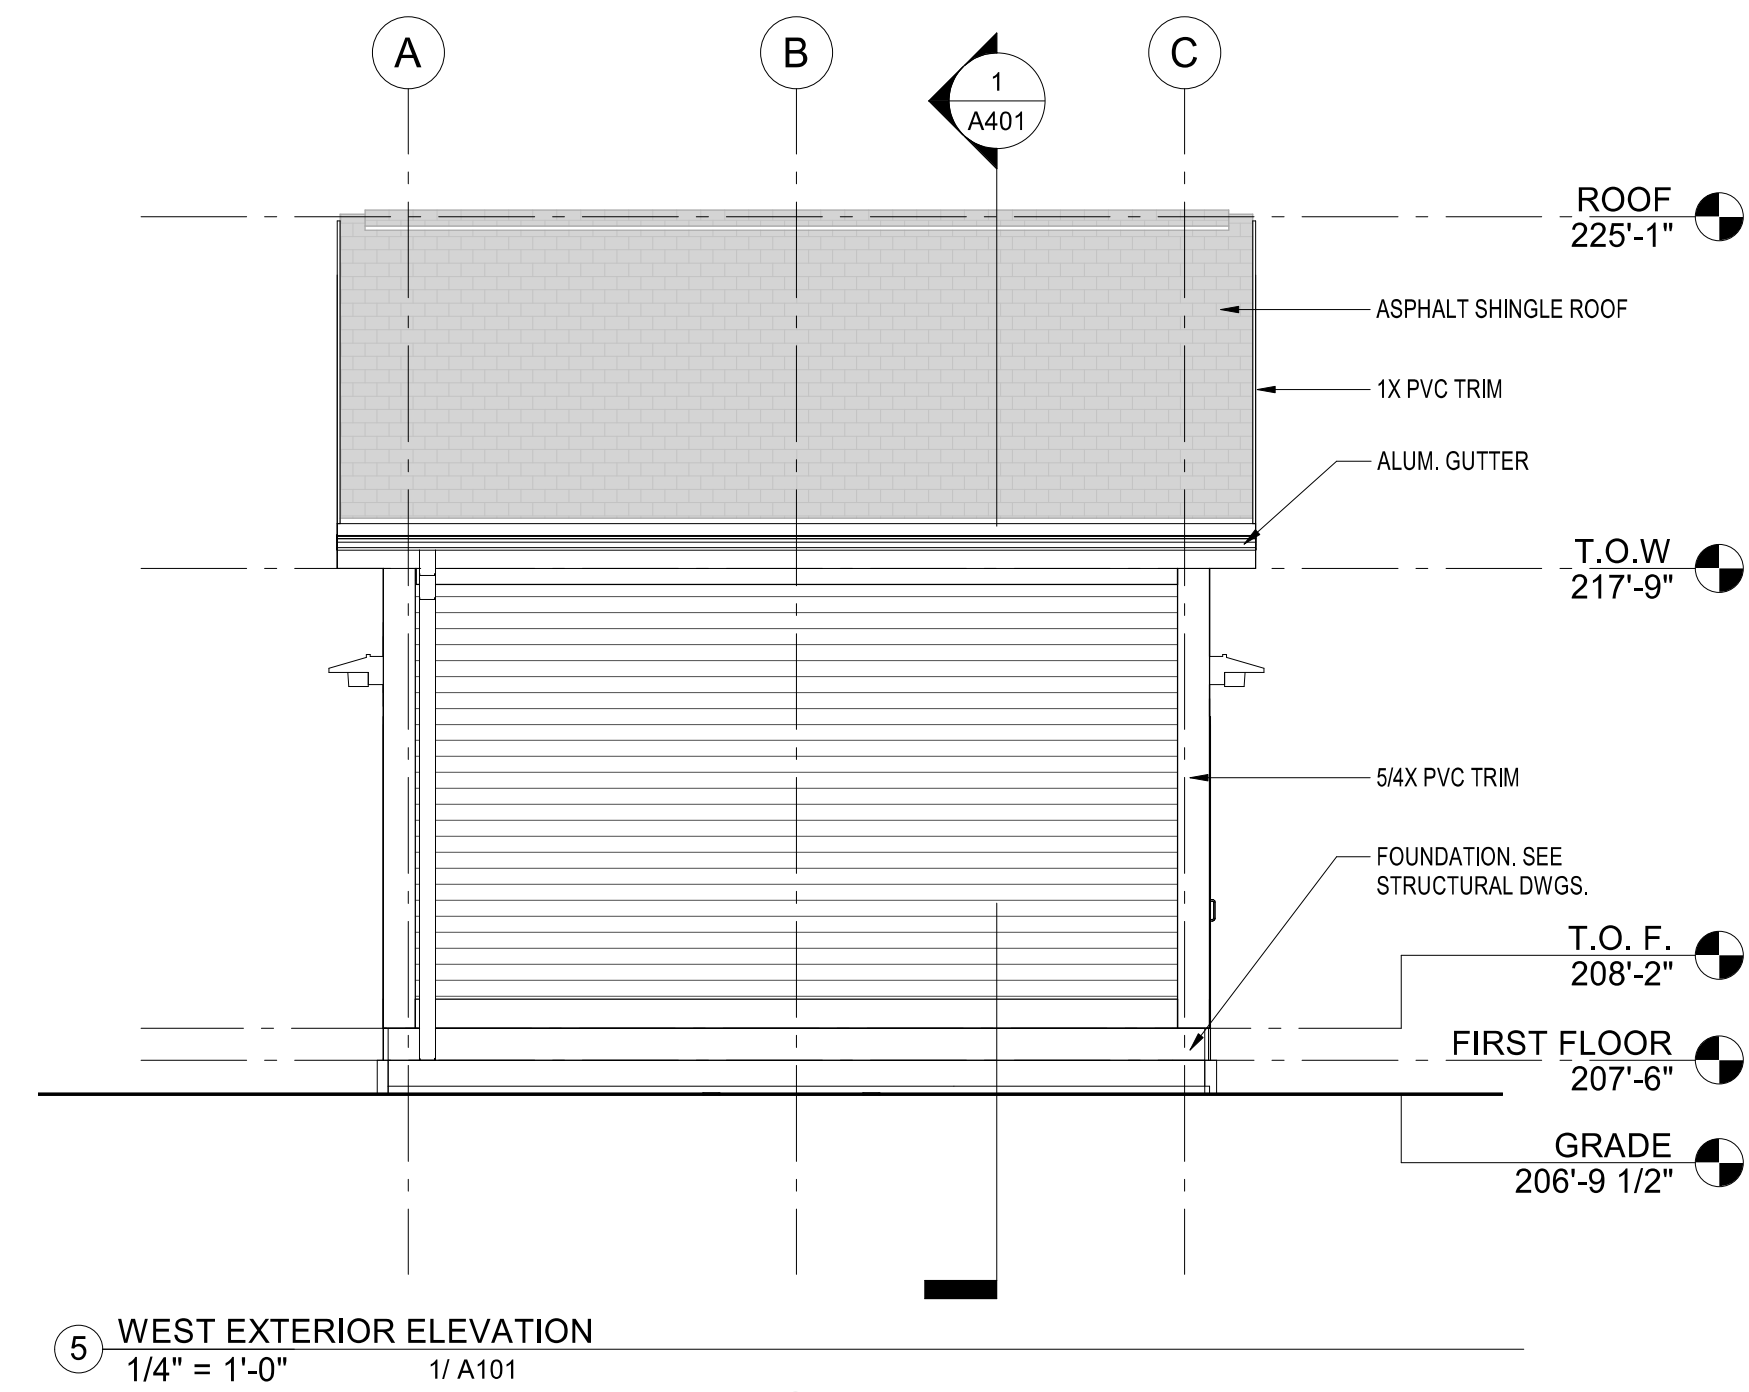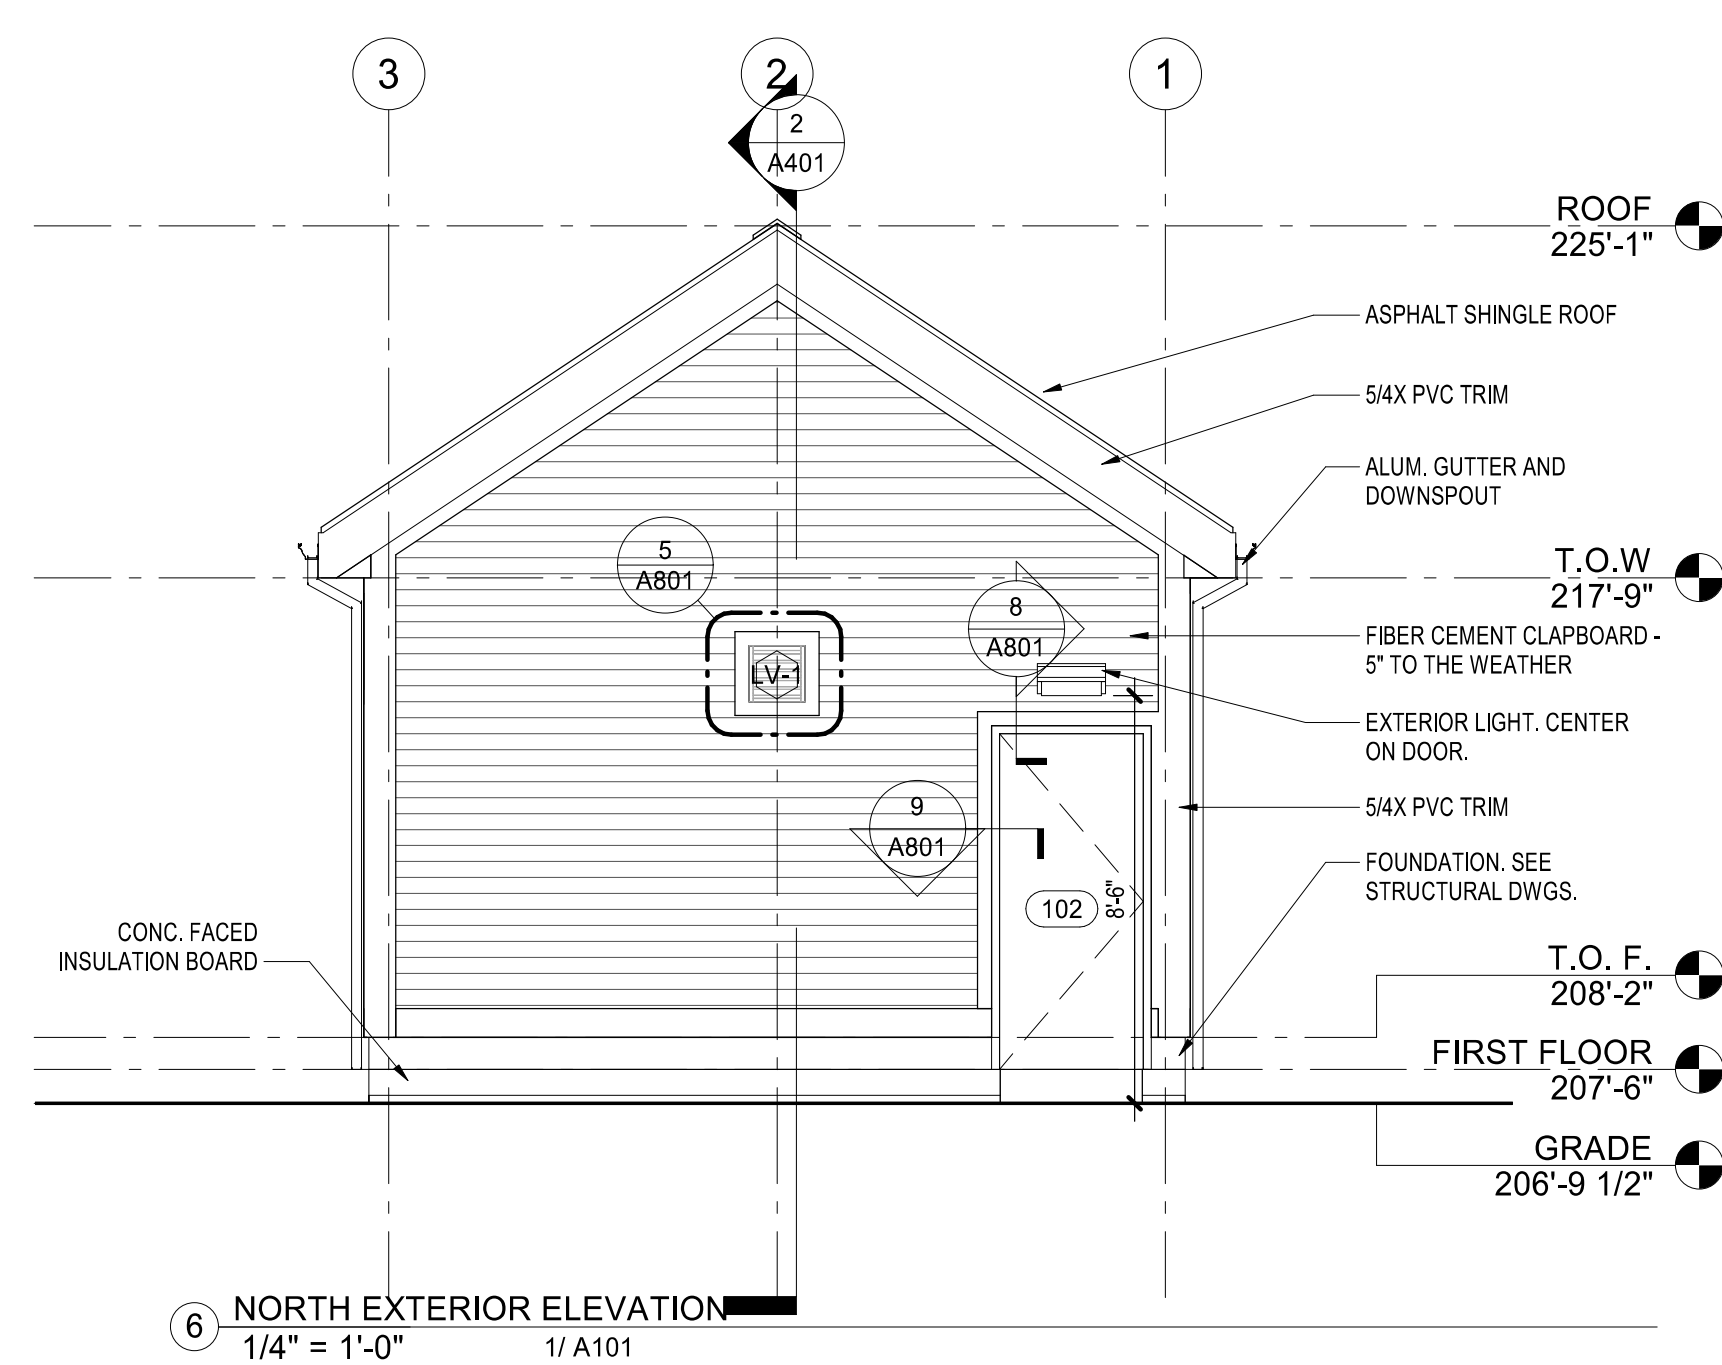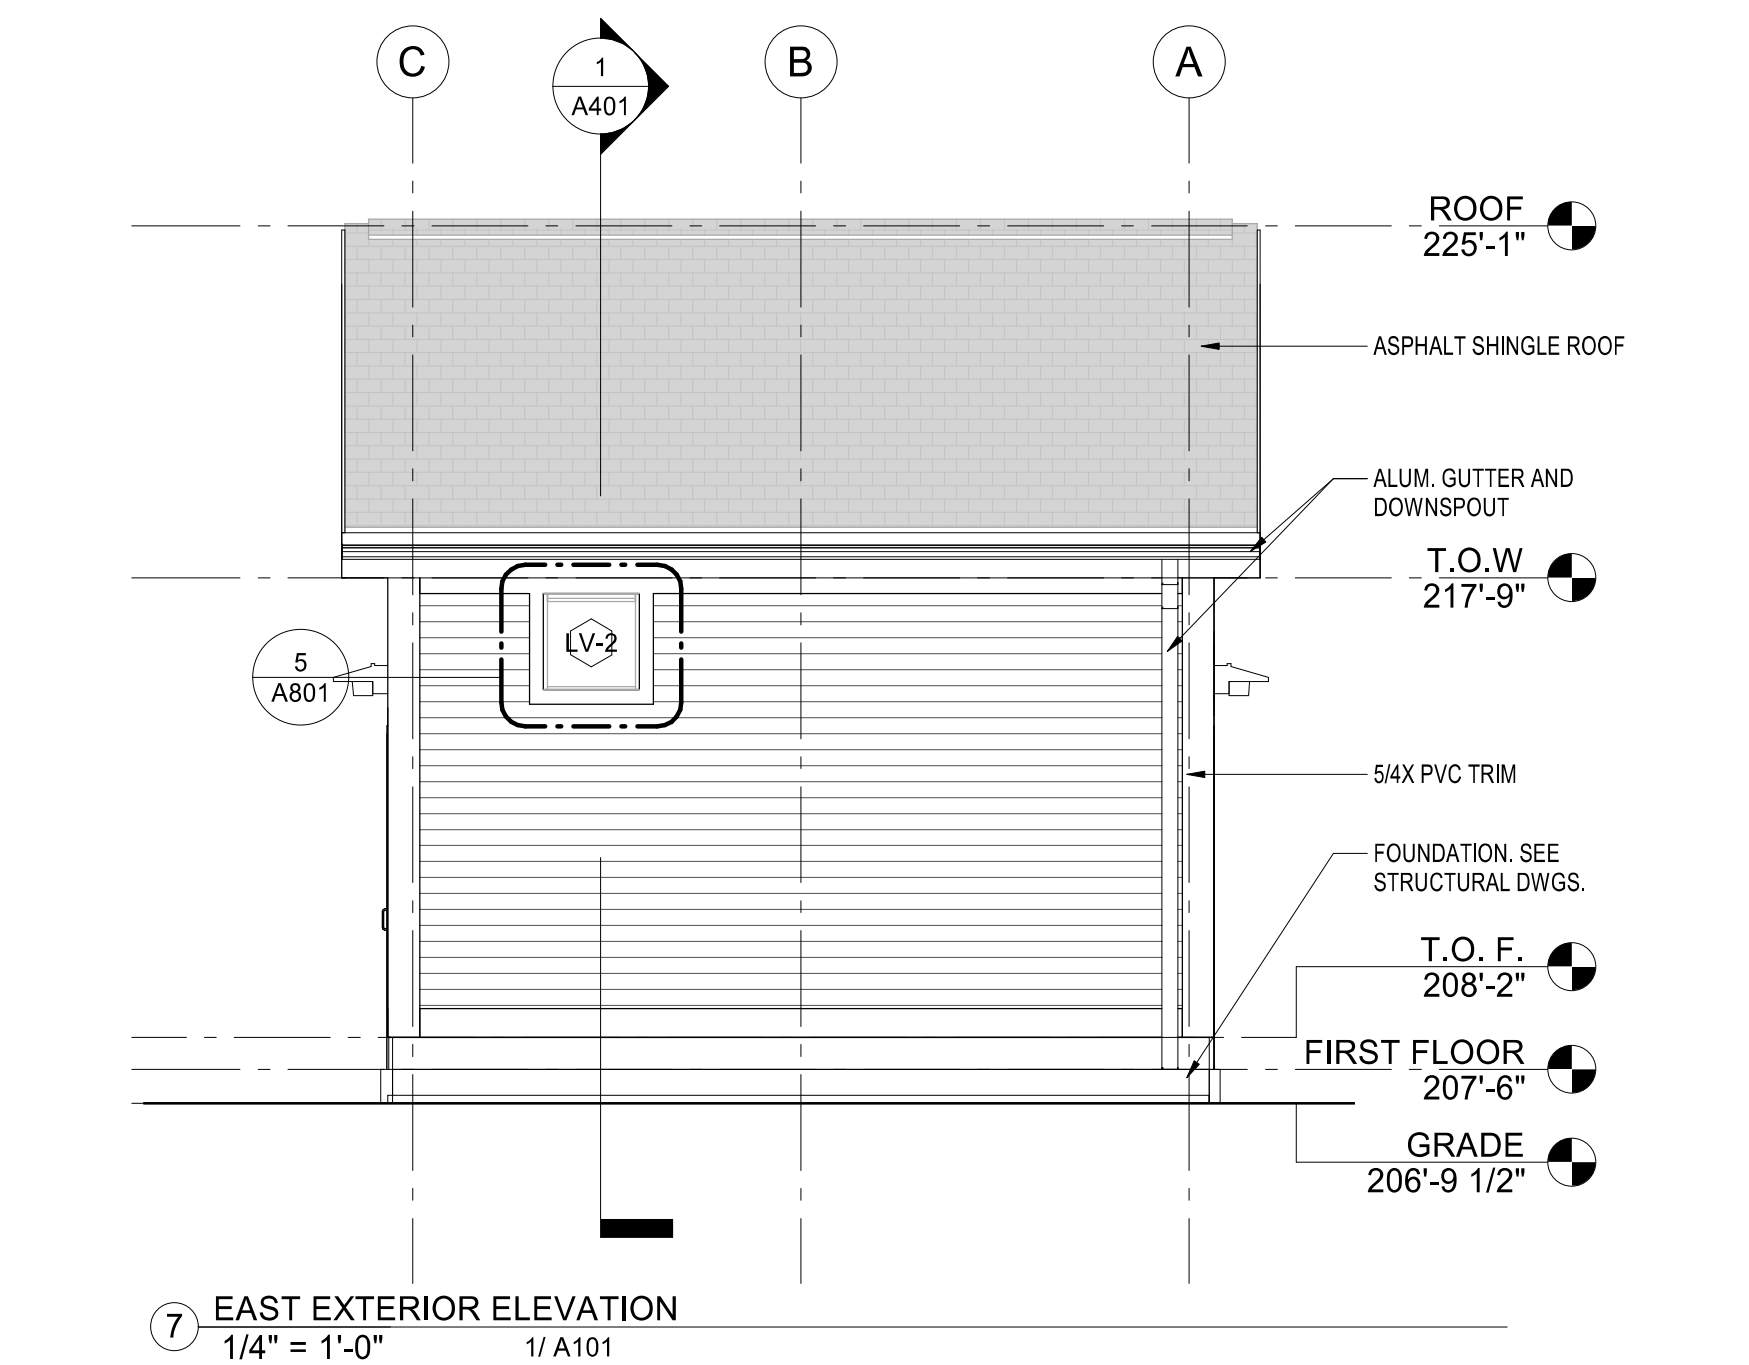Project:
CITY OF ROCHESTER, NH

LEDGEVIEW SEWER PUMP STATION UPGRADE

54A LEDGEVIEW DRIVE
ROCHESTER, NH 03868

Weston & Sampson
Weston & Sampson Engineers, Inc.
55 Walkers Brook Drive, Suite 100
Reading, MA 01867
978.532.1900 800.SAMPSON
www.westonandsampson.com

Consultants:

Revisions:

No.	Date	Description
1	03/07/2024	90% DESIGN REVIEW
2	04/24/2024	ISSUED FOR BIDDING

COA:

Seal:

Issued For:
ISSUED FOR BIDDING





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Key Plan:

Date: 04/24/2024
Drawn By: DGG
Reviewed By: JC
Approved By: DT
W&S Project No.: ENG23-0367
W&S File No.:

Drawing Title:
OVERALL FLOOR PLANS

Sheet Number:
A101

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NOTE: 3D VIEWS ARE PROVIDED FOR REFERENCE ONLY. REFER TO PLANS, ELEVATIONS, SECTIONS, DETAILS AND SCHEDULES FOR BUILDING REQUIREMENTS.

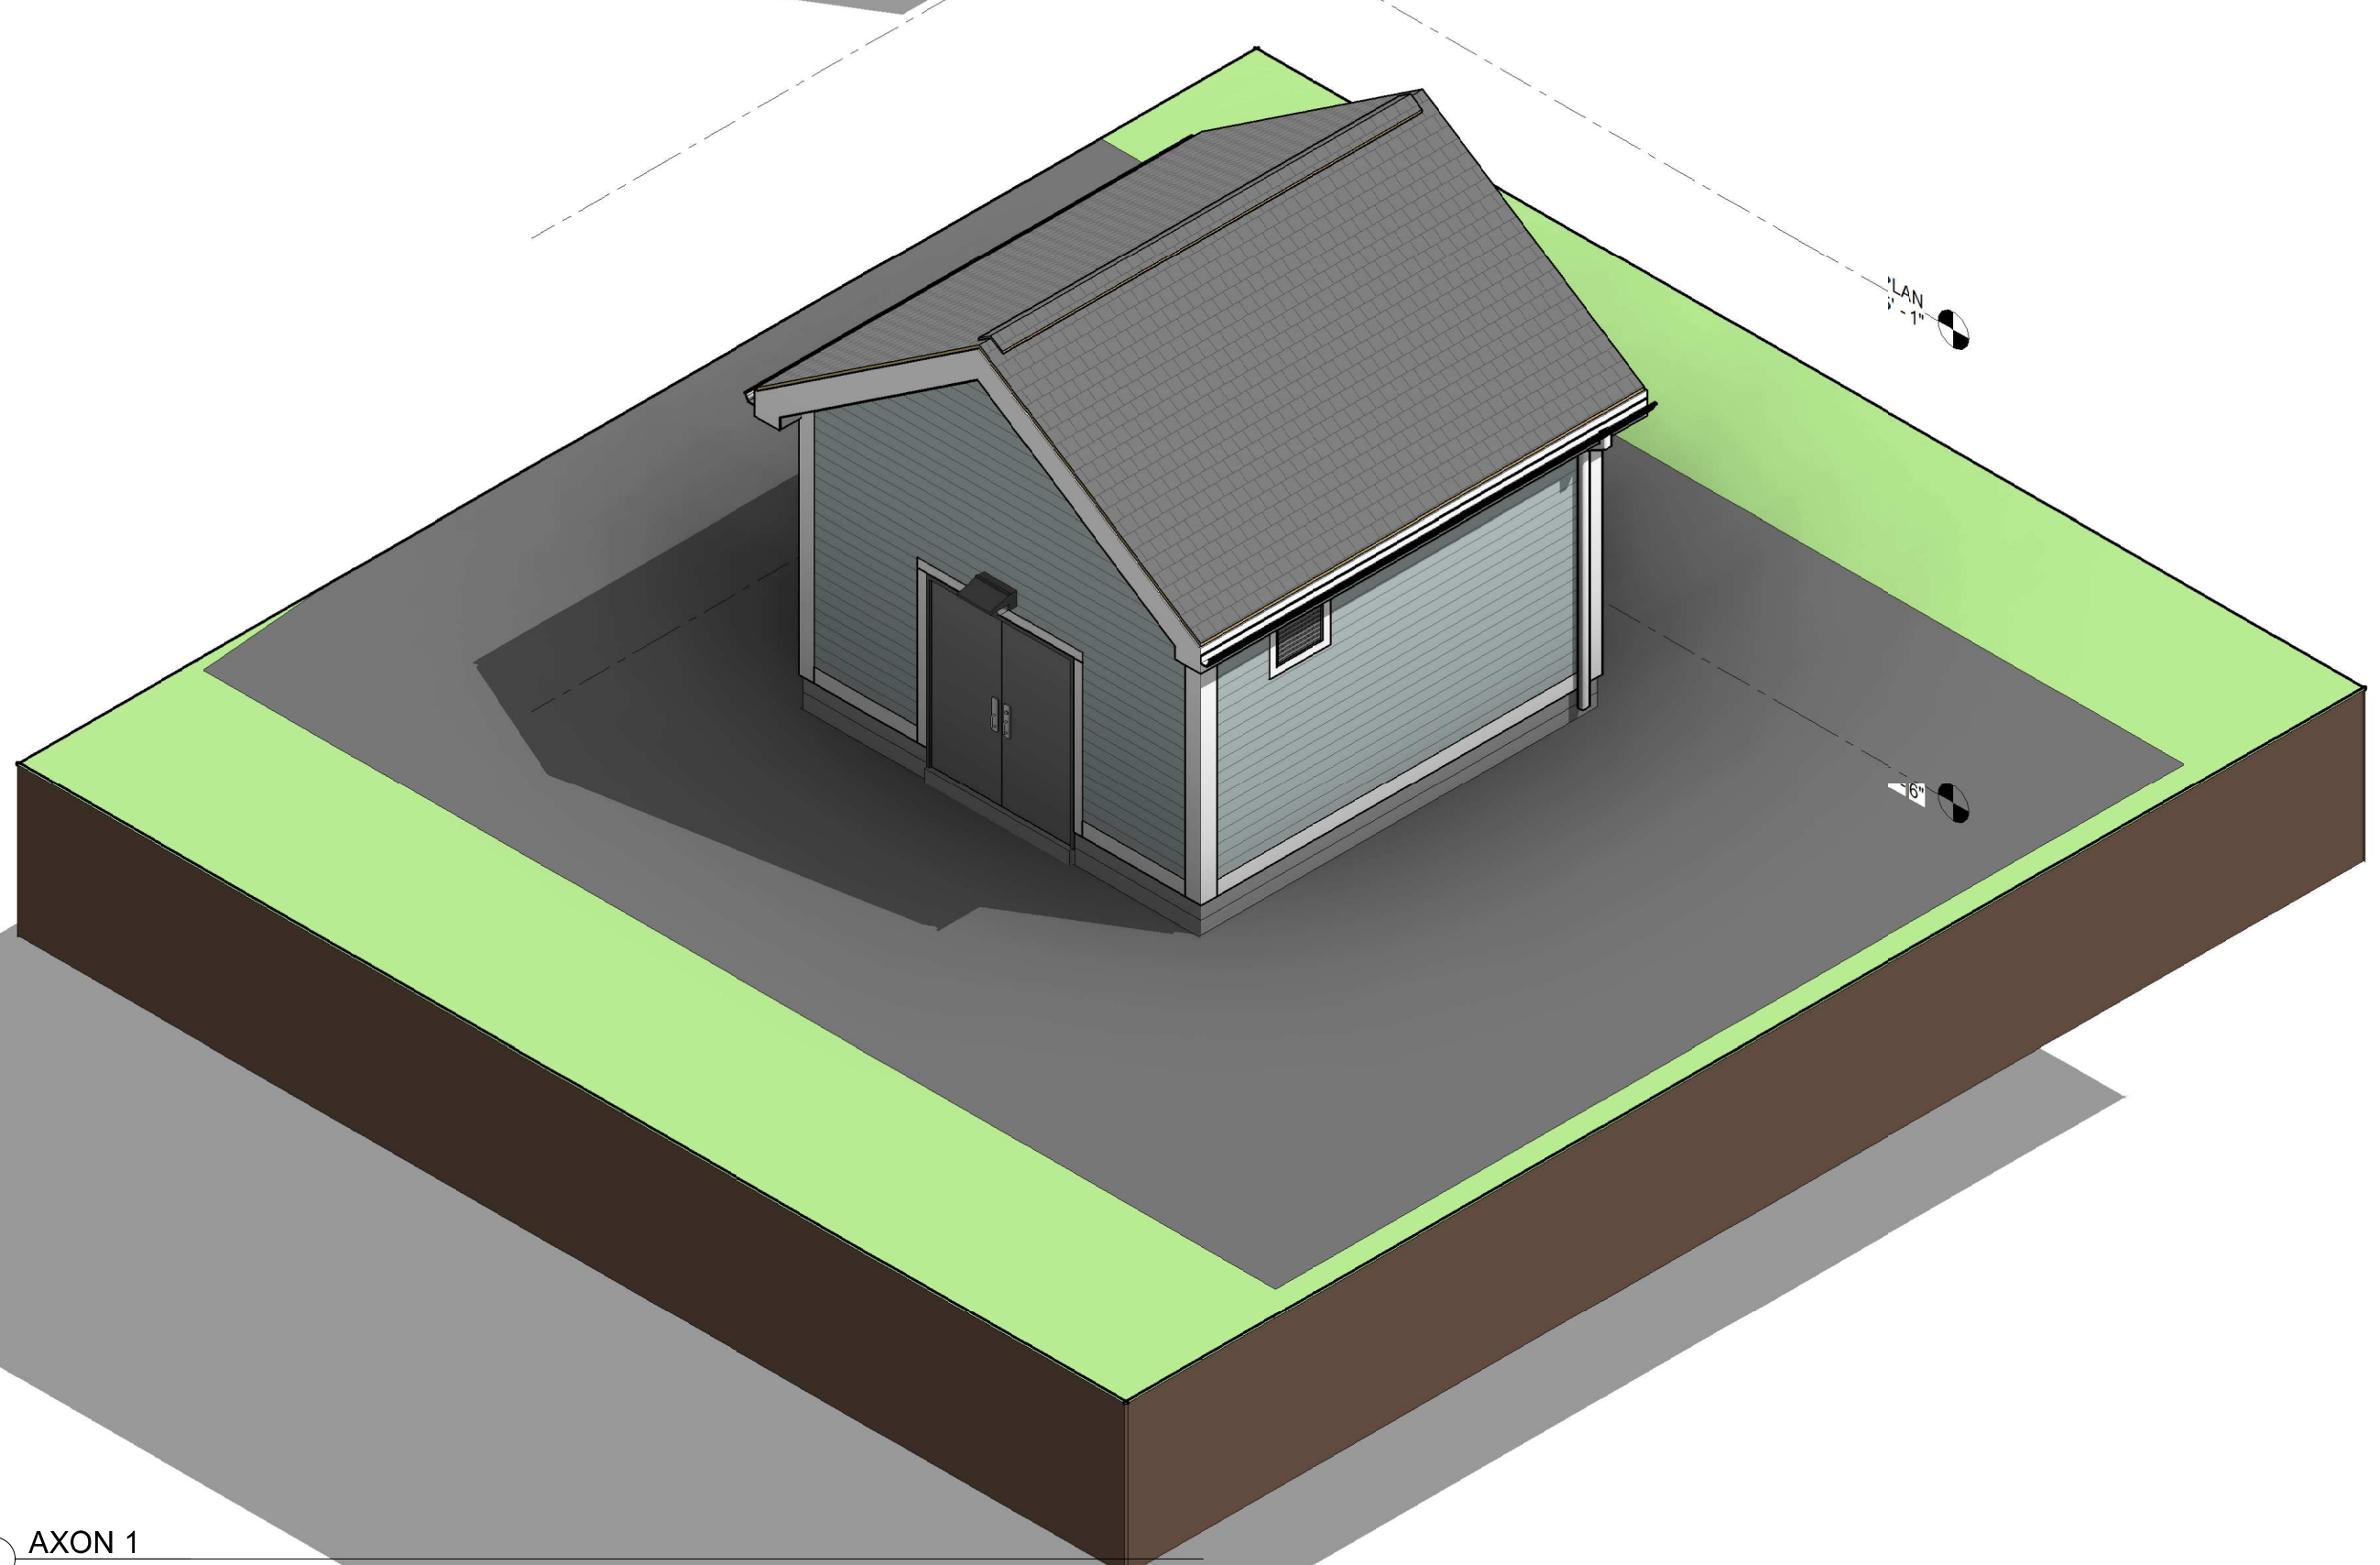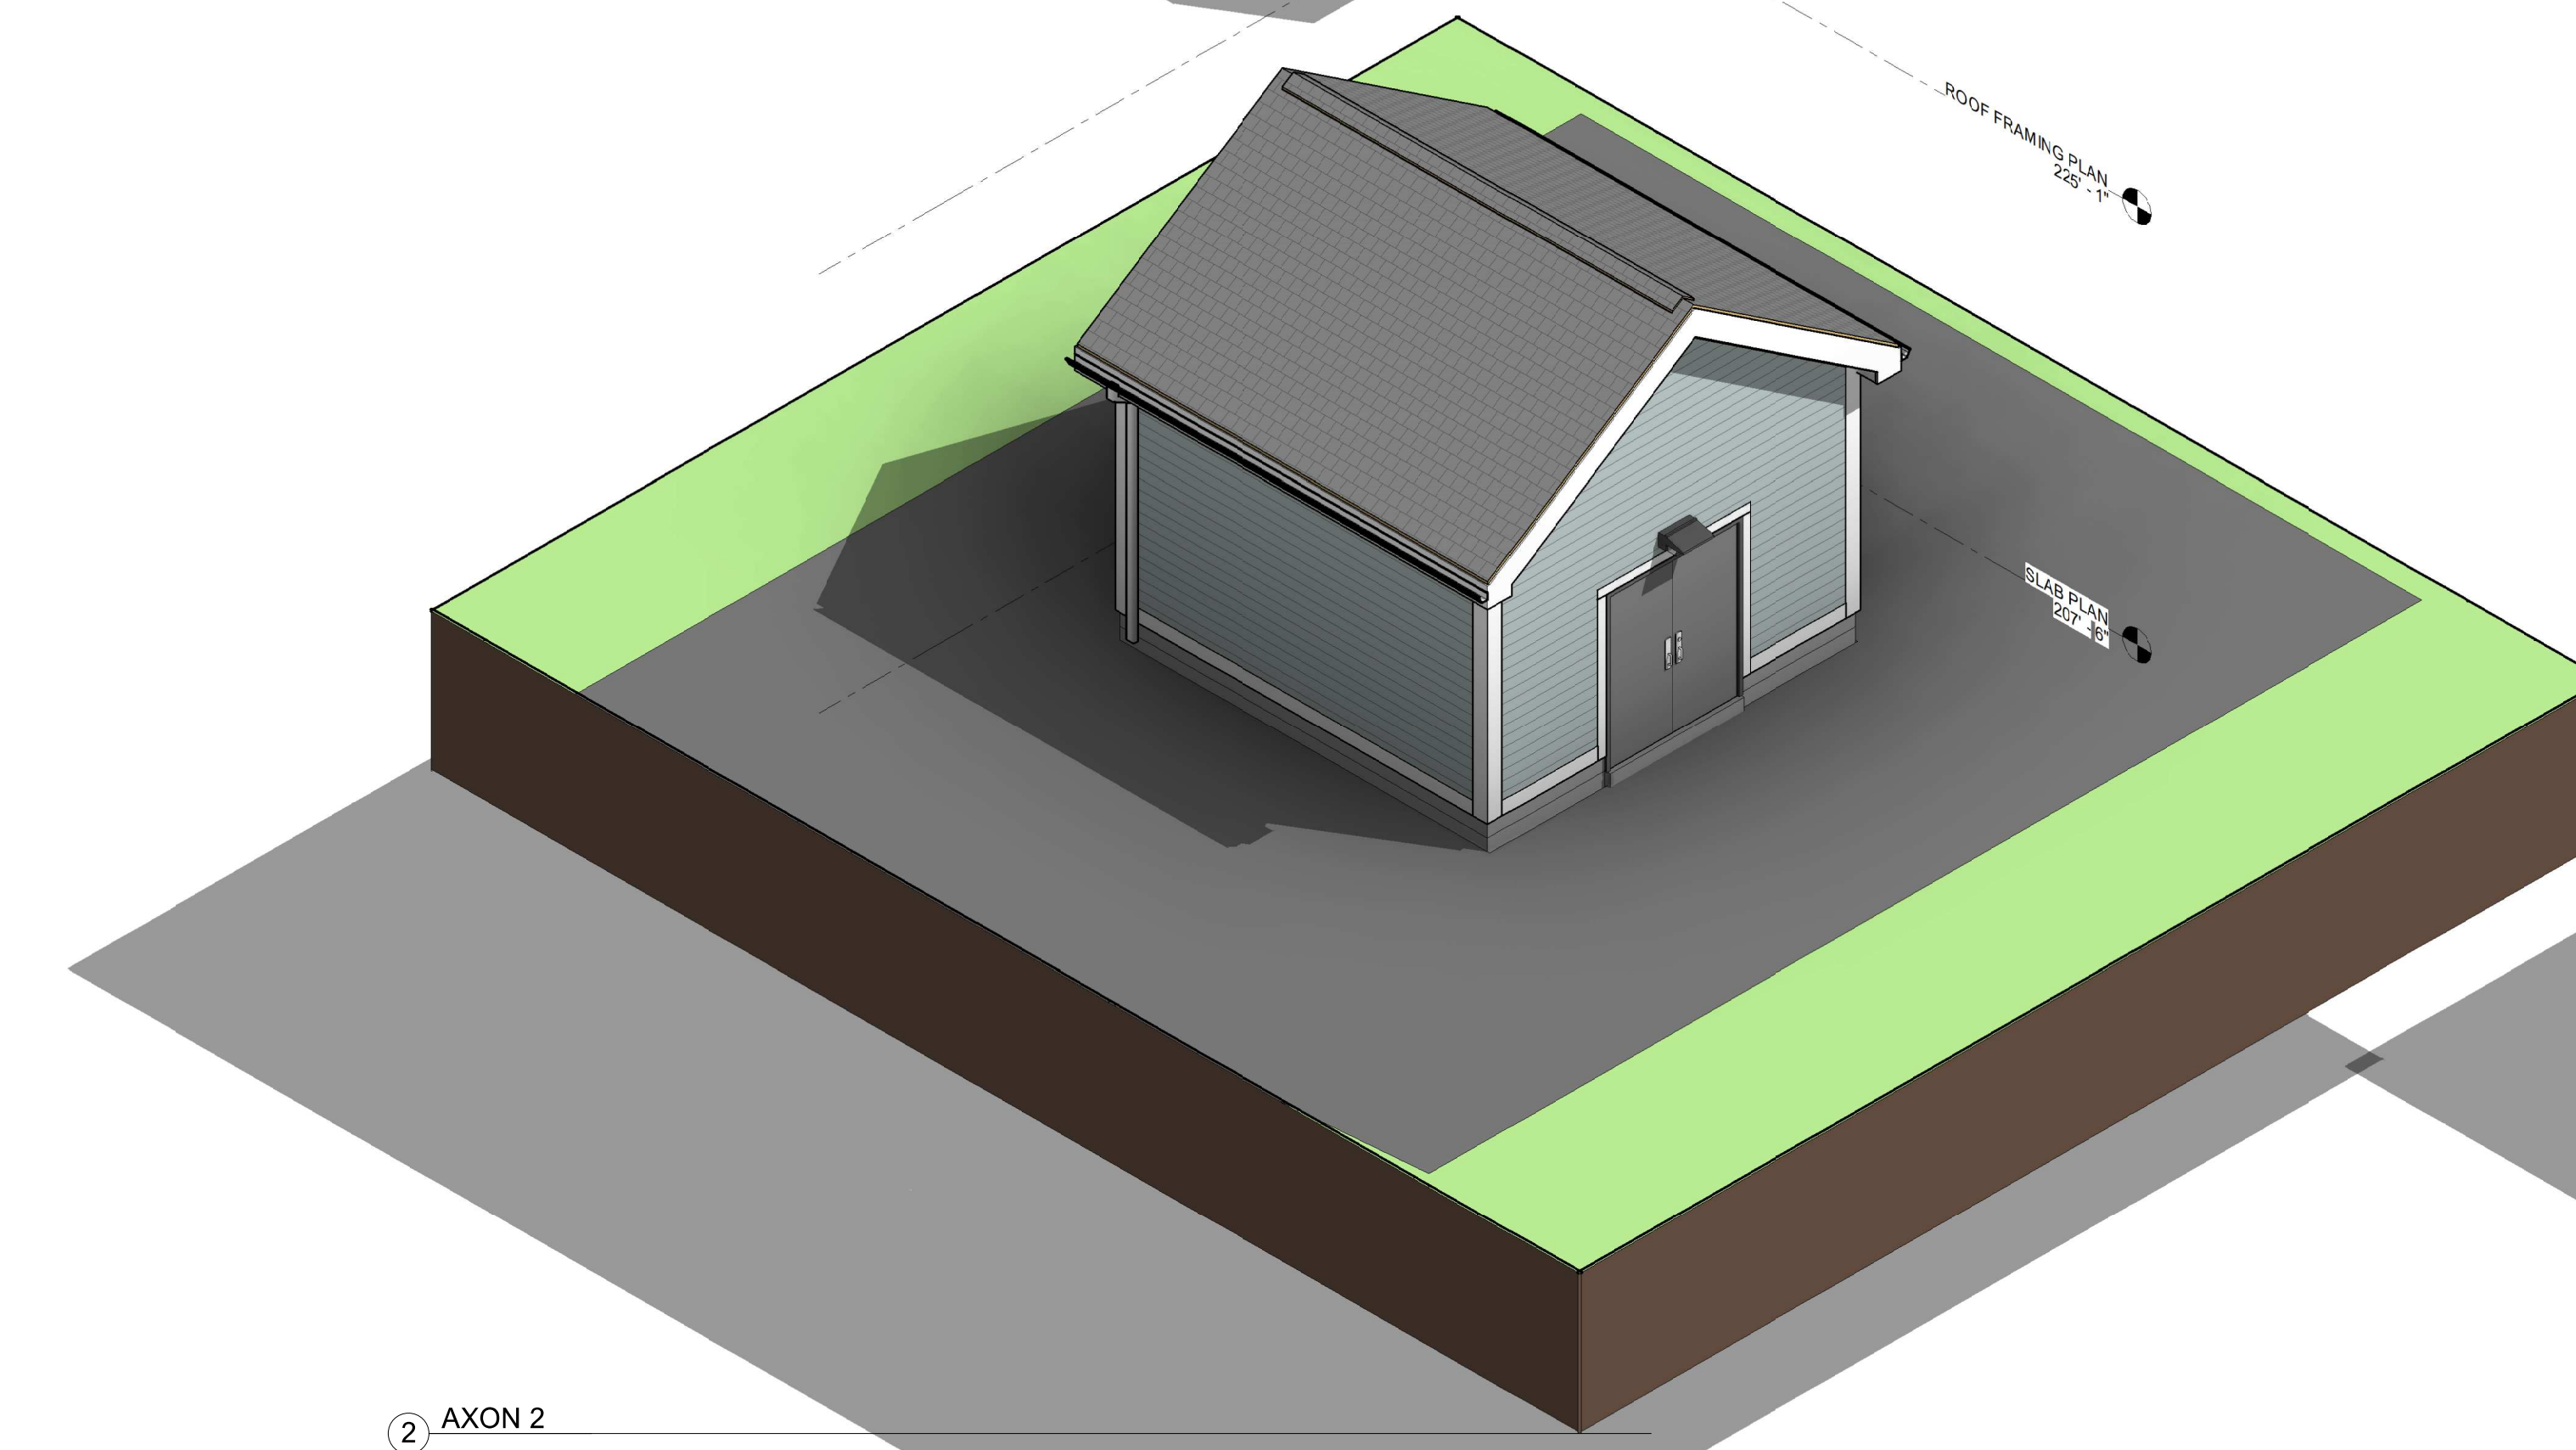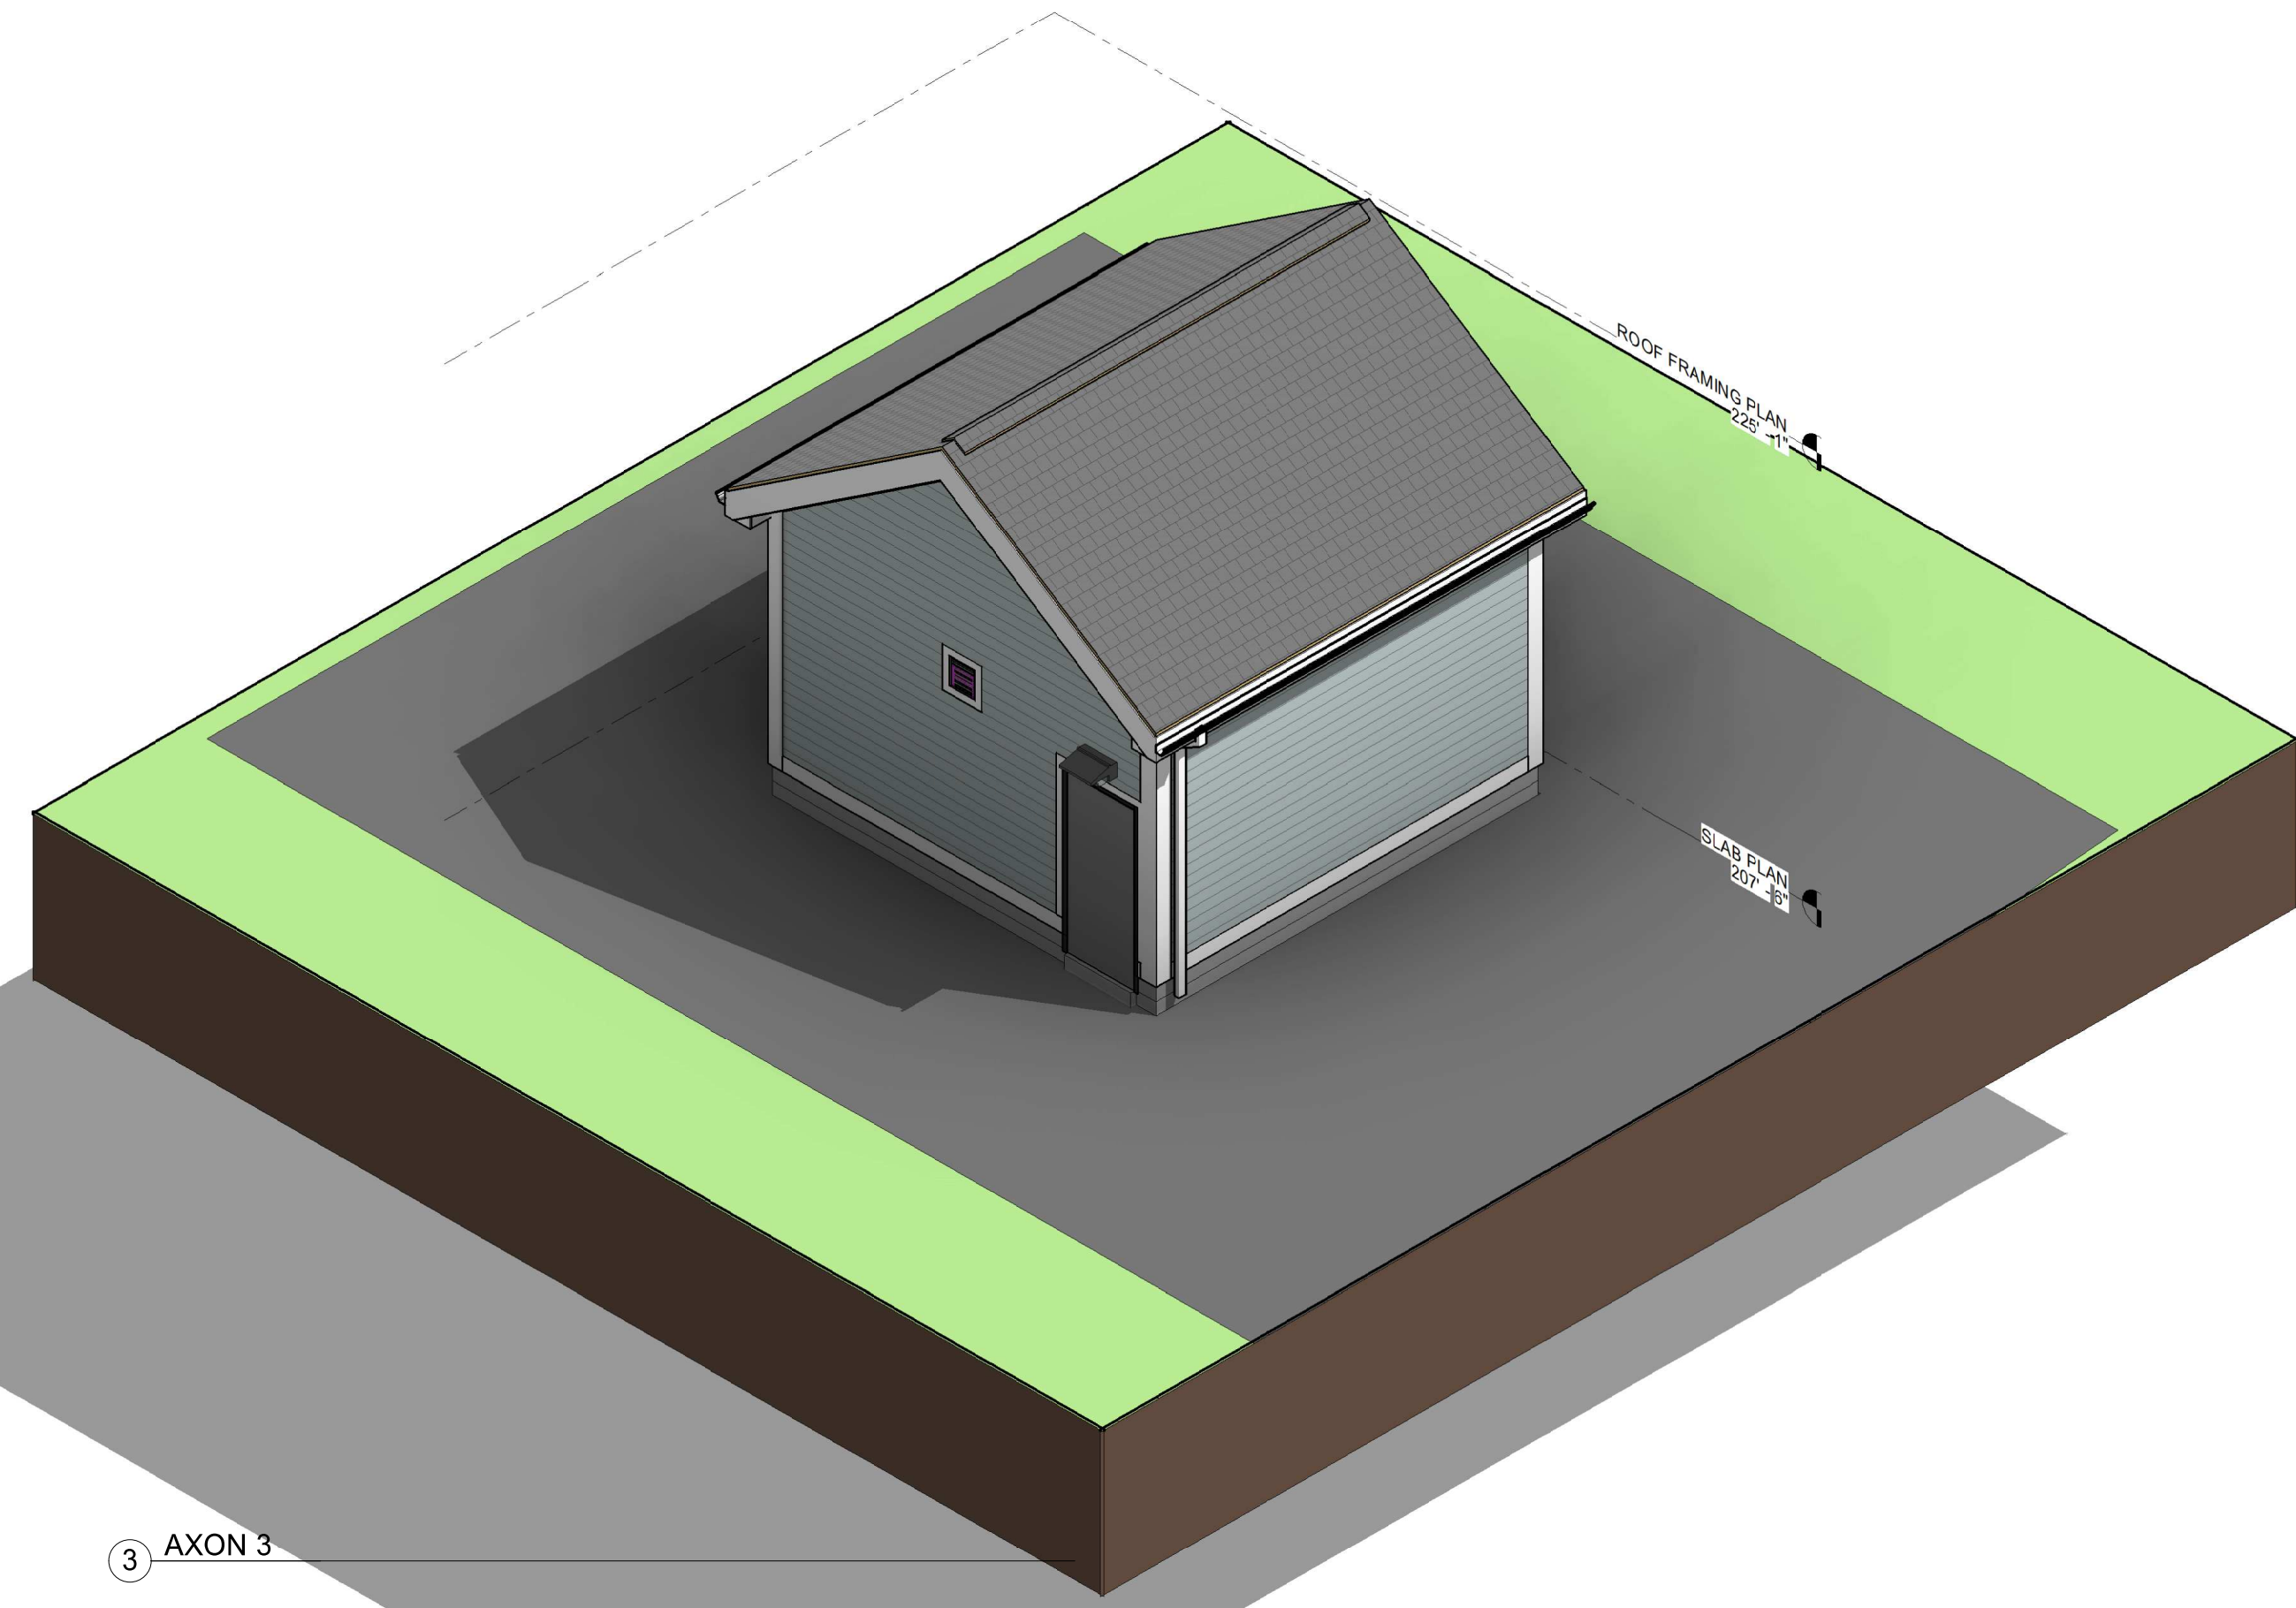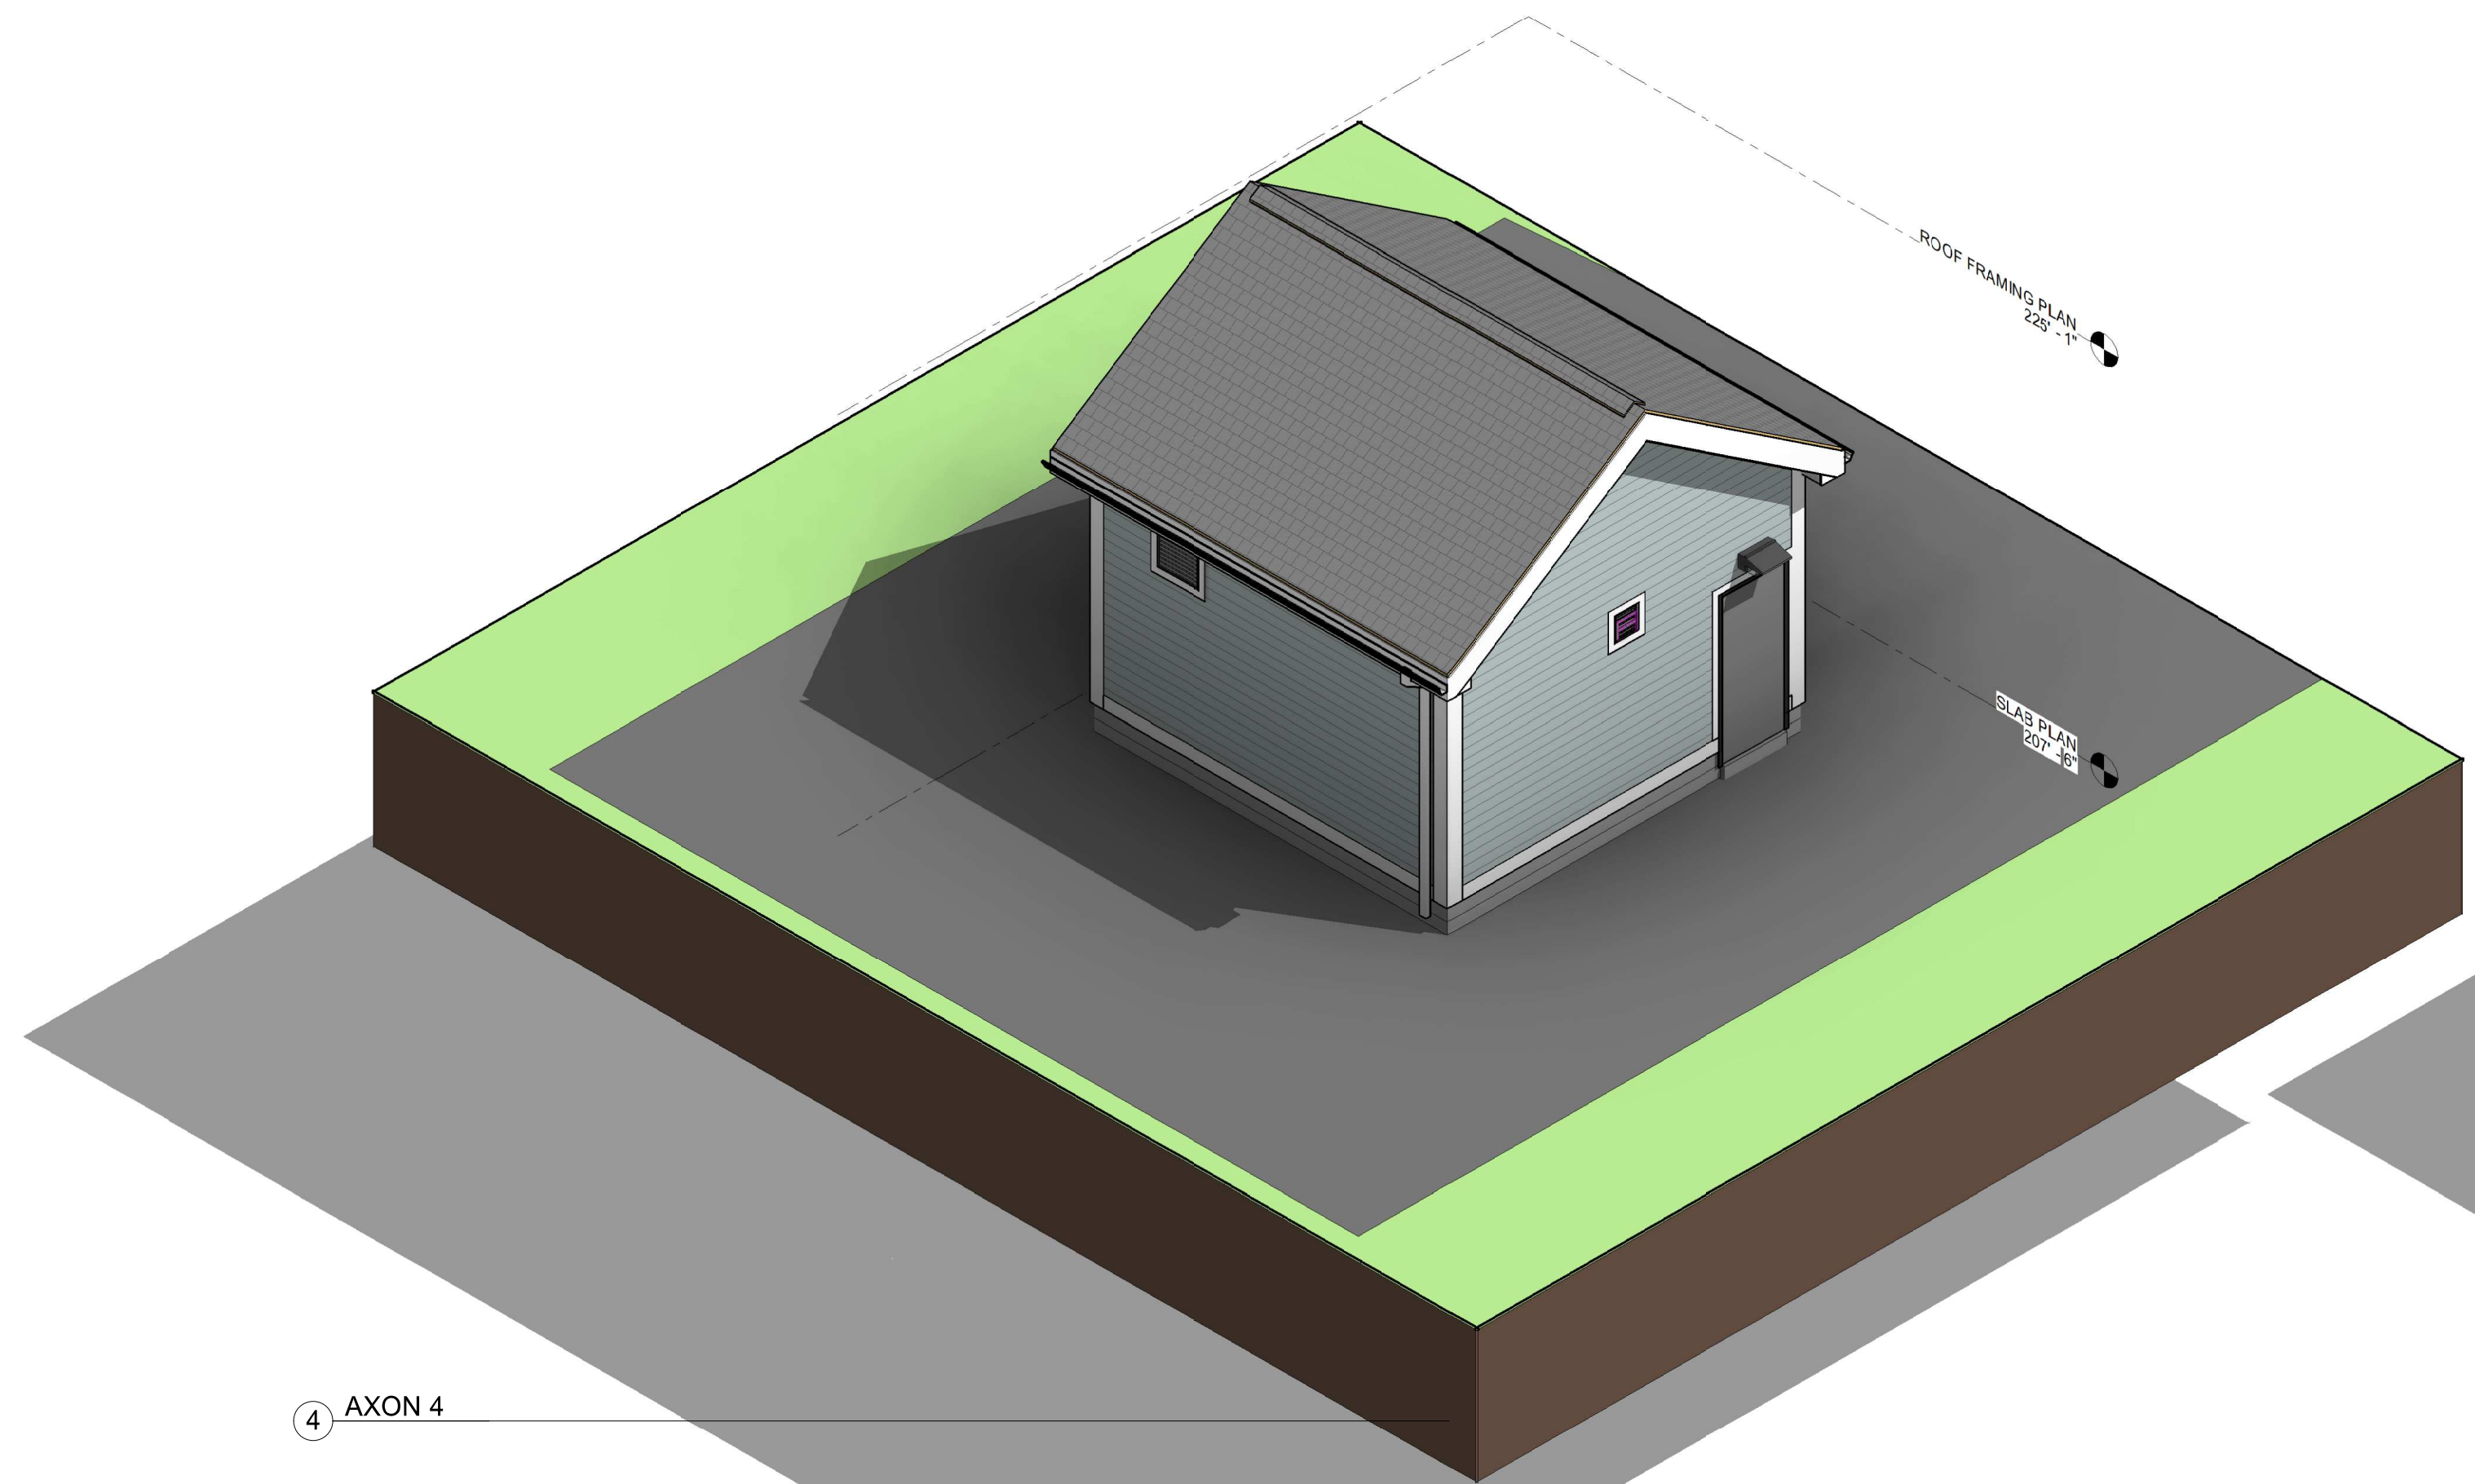Project:
CITY OF ROCHESTER, NH
LEDGEVIEW SEWER PUMP STATION
UPGRADE
54A LEDGEVIEW DRIVE
ROCHESTER, NH 03668


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Consultants:

Revisions:

No.	Date	Description

COA:

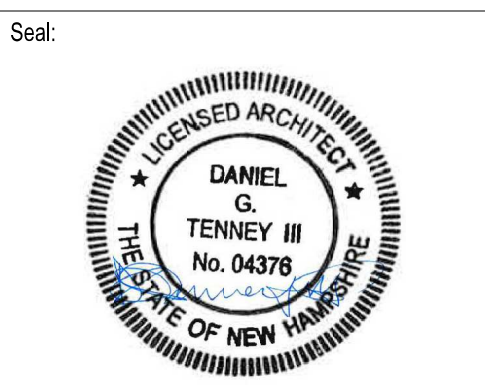

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Scale: 1/8" = 1'-0"
Key Plan:

Date: 04/24/2024
Drawn By: DGG
Reviewed By: JC
Approved By: DT
W&S Project No.: ENG23-0367
W&S File No.:

Drawing Title:
3D VIEWS

Sheet Number:
A231